NEVADA COUNTY DEPARTMENT OF PUBLIC WORKS CIVIL ENGINEERING PLANS FOR THE CONSTRUCTION OF

ELECTRIC BUS CHARGING PROJECT TINLOY STREET TRANSIT CENTER

TINLOY STREET TRANSIT CENTER, GRASS VALLEY, CALIFORNIA COUNTY PROJECT NO. 889830


NOTICE TO CONTRACTOR

48 HOURS NOTICE REQUIRED PRIOR TO COMMENCING WORK

BEFORE COMMENCING WORK, ALL REQUIRED PLANS, SCHEDULES, PROGRAMS AND OTHER SUBMITTALS MUST BE SUBMITTED AND APPROVED IN ACCORDANCE WITH THE CALTRANS STANDARD SPECIFICATIONS DATED 2024, THE CONTRACT DOCUMENTS AND SPECIAL PROVISIONS. BEFORE COMMENCING WORK THE CONTRACTOR SHALL NOTIFY THE NEVADA COUNTY DEPARTMENT OF PUBLIC WORKS 48 HOURS IN ADVANCE OF THE TIME OF COMMENCEMENT.



DIAGRAMS

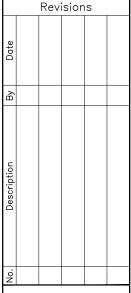



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Designed:	RP SEW
Drawn:	RP
Checked:	SEW PP EL
Job No:	889830
Date: De	c. 18, 2024
Scale	Reference

Drawing GI001

ABBREVIATIONS DIAMETER APPROXIMATELY 0 AB AC ADA AGGREGATE BASE ASPHALT CONCRETE AMERICANS WITH DISABILITIES ACT APPROXIMATELY APPROX ATCH ATTACHMENT BOTTOM FACE OF CURB BFC BELOW FINISH GRADE C CB CLR CLSM CONDUIT CIRCUIT BREAKER CLEAR CONTROLLED LOW-STRENGTH MATERIAL CORRUGATED METAL PIPE CMP CY DB CUBIC YARD DUCT BANK DΙ DRAINAGE/DROP INLET DEPARTMENT OF PUBLIC WORKS DPW DWG DRAWING DWGS (E) EA DRAWINGS EXISTING EACH EJ EXPANSION JOINT ELEC ELECTRICAL EQUIP. EQUIPMENT ELECTRIC VEHICLE CHARGING SYSTEM EVCS EW (F) FG F&I GR EACH WAY FUTURE FINISH GRADE FURNISH AND INSTALL GRADE GALVANIZED STEEL PIPE INVERT ELEVATION GSP IE INFO INFORMATION IRR IRRIGATION LB POUND MAX MAXIMUM MH MIN MANHOLE MINIMUM MSB MAIN SWITCH BOARD (N) NCOC NEW NEVADA COUNTY OPERATIONS CENTER NO. NTS OC OFCI NUMBER NOT TO SCALE ON CENTER OWNER FURNISHED CONTRACTOR INSTALLED PB PCC PULL BOX PORTLAND CEMENT CONCRETE PG&E PACIFIC GAS AND ELECTRIC COMPANY RELATIVE COMPACTION REINFORCING BAR RADIO FREQUENCY SACRAMENTO MUNICIPAL UTILITY DISTRICT REBAR RF SMUD SPECS COUNTY SPECIFICATIONS SS SST SW TYP UG UNO SANITARY SEWER STAINLESS STEEL STORMWATER TYPICAL UNDERGROUND UNLESS NOTED OTHERWISE WELDED WIRE FABRIC **XFMR** TRANSFORMER LINETYPE ABBREVIATIONS ABANDONED IN PLACE DUCT BANK E FO IRR ELECTRICAL FIBER OPTIC IRRIGATION MANHOLE М SS SW SANITARY SEWER STORMWATER DRAWING NUMBERING SYSTEM DRAWINGS ARE SUBDIVIDED INTO DISCIPLINES WITH THE FOLLOWING PREFIXES:

GENERAL LEGEND

	EXISTING	PROPOSED/NEW
EGEND.		LEGEND
	GARBAGE CAN	-E
	BENCH	
	INFO PLAQUE	
	SIGN	,
	SHELTER POST	EDGE PCC
)((BOLLARD LIGHT	CONTROL JOINT
	TRANSIT CENTER STREET LIGHT	DOWELED EXPANSION JOINT
0	POLE MOUNTED CAMERA	
•	CALTRANS STREET LIGHT	* DUCT BANK REFERS TO THE 12 3" C CONNECTING
ф.	BIKE BOLLARD	BETWEEN CABINETS AND CHARGING PADS
\bigcirc	MANHOLE	
RR0	IRRIGATION BOX	
\bowtie	VALVE	
W	WATER VALVE BOX	
e	ELECTRICAL PB	
S	SIGNAL PB	

LIGHTING PB

FIBEROPTIC PB

CONTROL POINT

-----IRR(A)-------IRRIGATION (ABANDONED IN PLACE)

· · CONCRETE JOINT

= CURB

CURB & GUTTER

-------- VALLEY GUTTER

— FO — FO — FIBEROPTIC

—IRR——IRR—— IRRIGATION

_____ RIGHT OF WAY


_____ GAS ____ GAS

HATCHING LEGEND

	TO BE DEMOLISHED
+ + + + + + + + + + + + + + + + + + + +	CLEARING & GRUBBING IRRIGATION EQUIPMENT ALTERATIONS
↓	REINSTATE (E) IRRIGATION SYSTEM RESTORE (E) LANDSCAPING
	(N) PCC - PLAN VIEW
4.	(E) PCC - SECTION VIEW
	(N) PCC - SECTION VIEW

CEMENT SLURRY

ROCK SWALE/FEATURE

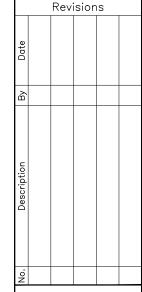



Works

Public

of

Department

County

Projec Center Sharging Transit

LEGEND **ABBREVIATIONS**, Bus C Street Electric Tinloy


Nevada

RP SEW Designed: Drawn: Checked: SEW PP EL Job No: 889830 Date: Dec. 18, 2024

Scale Reference

Drawing GI002

LEV	/EL 1 - DISCIPLINE	LEV	EL 2 - DESIGNATOR
G	GENERAL	C	INFORMATION CONTRACTUAL
V	SURVEY/MAPPING	A F	AERIAL FIELD
С	CIVIL	D S P Z	DEMOLITION SITE PAVING DETAILS

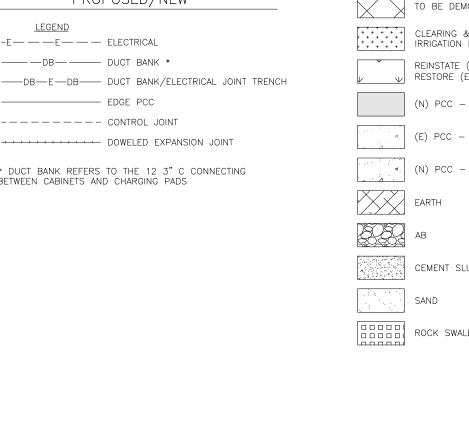

GENERAL NOTES

- ALL CONSTRUCTION AND MATERIALS SHALL BE IN ACCORDANCE WITH THE PROJECT PLANS AND SPECIFICATIONS.
- AT THE TIME THE CONTRACT IS AWARDED, THE CONTRACTOR SHALL POSSESS A CLASS "A" LICENSE, OR A COMBINATION OF CLASSES REQUIRED BY THE CATEGORIES AND CLASSES OF WORK INCLUDED IN THIS CONTRACT.
- 3. THE CONSTRUCTION METHODS AND MATERIALS SHALL CONFORM TO THE 2024 EDITION OF THE STATE OF CALIFORNIA, DEPARTMENT OF TRANSPORTATION STANDARD SPECIFICATIONS, AND STANDARD PLANS, INCLUDING REVISED STANDARD PLANS AND SPECIFICATIONS, AND APPLICABLE NEVADA COUNTY STANDARD DRAWINGS. IN CASE OF CONFLICT, REFER TO THE PROJECT SPECIAL PROVISIONS FOR ORDER OF PRECEDENCE.
- 4. THE CONTRACTOR SHALL BE HELD RESPONSIBLE FOR ANY FIELD CHANGES MADE WITHOUT WRITTEN AUTHORIZATION FROM THE OWNER. ANY DISCREPANCIES OR AMBIGUITIES SHALL BE BROUGHT TO THE ATTENTION OF THE ENGINEER AND RESOLVED IN WRITING PRIOR TO EXECUTING THE WORK.
- THE COUNTY SHALL BE NOTIFIED AT LEAST 48 HOURS IN ADVANCE OF ANY WORK BEING PERFORMED.
- THE COST OF CORRECTIVE WORK REQUIRED FOR COMPLETION AND/OR
 ACCEPTANCE OF THE WORK NECESSITATED BECAUSE OF UNSATISFACTORY
 WORKMANSHIP OR MATERIALS SHALL BE THE RESPONSIBILITY OF THE
 CONTRACTOR.
- 7. THE CONTRACTOR SHALL VERIFY ALL CONTROLLING FIELD DIMENSIONS BEFORE ORDERING OR FABRICATING ANY MATERIALS.
- 8. CONTRACTOR SHALL ASSUME SOLE AND COMPLETE RESPONSIBILITY FOR JOB SITE CONDITIONS DURING THE COURSE OF CONSTRUCTION OF THIS PROJECT, INCLUDING SAFETY OF ALL PERSONS AND PROPERTY; THIS REQUIREMENT SHALL NOT BE LIMITED TO NORMAL WORKING HOURS.
- 9. THE COUNTY MAY REQUIRE THE CONTRACTOR TO UNCOVER ANY IMPROVEMENTS THAT HAVE BEEN COMPLETED WITHOUT PROPER COUNTY INSPECTION AND/OR APPROVAL. IF THE INSTALLATION IS FOUND NOT TO MEET COUNTY STANDARDS OR PREVIOUSLY APPROVED ALTERNATIVES SHOWN ON THE PLANS, THE CONTRACTOR SHALL REMOVE AND REPLACE SUCH IMPROVEMENTS AT THE CONTRACTOR'S EXPENSE.
- 10. CONTRACTOR SHALL DEVELOP A WATER POLLUTION CONTROL PROGRAM AND ENSURE IMPLEMENTATION OF BEST MANAGEMENT PRACTICES. ALL PERSONNEL SHALL BE TRAINED IN THE CONDITIONS OF THE PLAN AND SHALL BE FULLY KNOWLEDGEABLE OF THE REPORTING REQUIREMENTS AND PROCEDURES.
- 11. NO CONSTRUCTION SHALL BE PERFORMED WITHOUT A COUNTY APPROVED EROSION AND SEDIMENT CONTROL PLAN TO PREVENT SOIL EROSION. ALL EROSION AND SEDIMENTATION CONTROL MEASURES SHALL BE IN ACCORDANCE WITH APPROPRIATE GUIDELINES, SUCH AS THE CALIFORNIA STORMWATER QUALITY ASSOCIATION (CASQA) CONSTRUCTION BMP HANDBOOK. APPLICANT AND/OR CONTRACTOR SHALL SECURE ANY NECESSARY STATE OF CALIFORNIA COVERAGE AS NEEDED UNDER THE STATE'S CONSTRUCTION GENERAL PERMIT FOR STORM WATER DISCHARGES UNDER THE NATIONAL POLLUTANT DISCHARGE ELIMINATION SYSTEM (NPDES).
- 12. INSTALLATION AND MAINTENANCE OF EROSION CONTROL MEASURES ARE THE RESPONSIBILITY OF THE CONTRACTOR. THE CONTRACTOR SHALL BE RESPONSIBLE FOR THE PREVENTION OF ANY EROSION OR SILTATION ENTERING THE STORM DRAIN SYSTEM, NATURAL DRAINAGE COURSES AND/OR INTRUDING UPON ADJACENT ROADWAYS AND PROPERTIES. THIS RESPONSIBILITY SHALL APPLY THROUGHOUT THE COURSE OF CONSTRUCTION AND UNTIL ALL DISTURBED AREAS HAVE BECOME STABILIZED AND SHALL NOT BE LIMITED TO WET WEATHER PERIODS.
- 13. THE COST OF PROTECTION AND/OR REPAIR OF THE CONTRACTOR'S WORK AS AFFECTED BY STORM WATERS DURING INCLEMENT WEATHER SHALL BE THE CONTRACTOR'S RESPONSIBILITY UNTIL THE IMPROVEMENTS HAVE BEEN ACCEPTED BY THE OWNER. CONTRACTOR SHALL BE RESPONSIBLE FOR ANY DAMAGE TO ADJACENT PROPERTIES OR IMPROVEMENTS AS A RESULT OF NOT PROTECTING SUCH AREAS FROM STORM WATERS FLOWING OUT OF THE WORK AREA.
- 14. THE DATA FOR THE EXISTING UTILITIES AND IMPROVEMENTS ARE APPROXIMATE. THE CONTRACTOR IS RESPONSIBLE FOR DETERMINING THE EXACT LOCATIONS FOR THE EXISTING FACILITIES AND FOR THE PROTECTION AND REPAIR OF DAMAGE TO THEM CAUSED BY THE CONTRACTOR'S OPERATIONS. NEVADA COUNTY HAS MADE EVERY EFFORT TO SHOW LOCATIONS OF ANY AND ALL EXISTING SURFACE AND SUBSURFACE FACILITIES. HOWEVER, ACTUAL FIELD CONDITIONS AND LOCATIONS CAN VARY CONSIDERABLY FROM PLAN LOCATION. THEREFORE, NEVADA COUNTY CANNOT, AND DOES NOT, ASSUME RESPONSIBILITY FOR THE EXISTENCE OR LOCATION OF ANY FACILITIES SUCH AS, BUT NOT LIMITED TO, UTILITIES, PIPELINES AND SEWER. THE CONTRACTOR IS RESPONSIBLE FOR ACCURATELY LOCATING UTILITIES.
- 15. ANY EXISTING UTILITY STRUCTURE, INCLUDING BUT NOT LIMITED TO VALVE BOXES, SEWER AND STORM MANHOLES AND INLETS, ELECTRICAL, WATER, GAS, AND TELEPHONE BOXES AND VAULTS OCCURRING IN THE LOCATION OF

- PROPOSED IMPROVEMENTS SHALL BE PROTECTED.
- 16. THE CONTRACTOR SHALL BE RESPONSIBLE FOR POTHOLING EXISTING UTILITIES AS REQUIRED PRIOR TO CONSTRUCTION OF ANY UNDERGROUND WORK.
- 17. THE CONTRACTOR IS RESPONSIBLE FOR COORDINATING ANY NECESSARY UTILITY RFI OCATIONS.
- 18. THE CONTRACTOR SHALL MAINTAIN ADEQUATE DUST CONTROL PER SECTION 10-5 OF THE CALTRANS STANDARD SPECIFICATIONS.
- 19. TRUCKS HAULING DIRT AND DEBRIS SHALL BE COVERED TO REDUCE WIND BLOWN DUST AND SPILLS.
- 20.IF ANY ARCHAEOLOGICAL ARTIFACTS, EXOTIC ROCK (NON-NATIVE), OR UNUSUAL AMOUNTS OF SHELL OR BONE ARE UNCOVERED DURING ANY ON-SITE CONSTRUCTION ACTIVITIES, ALL WORK MUST STOP IMMEDIATELY IN THE AREA. ENGINEER SHALL BE NOTIFIED, AND A QUALIFIED ARCHAEOLOGIST RETAINED TO EVALUATE THE DEPOSIT. IF THE DISCOVERY CONSISTS OF HUMAN REMAINS, ENGINEER SHALL BE NOTIFIED AND THE NEVADA COUNTY CORONER AND NATIVE AMERICAN HERITAGE COMMISSION MUST ALSO BE CONTACTED. WORK IN THE AREA MAY ONLY PROCEED AFTER AUTHORIZATION IS GRANTED BY THE COUNTY.
- 21. THE CONTRACTOR SHALL BE RESPONSIBLE FOR MAINTAINING AS—BUILT DRAWINGS THROUGHOUT THE COURSE OF CONSTRUCTION. SUCH DRAWINGS SHALL RECORD THE LOCATION AND DETAILS OF ALL IMPROVEMENTS CONSTRUCTED AND SHALL BE SUBMITTED TO THE CONSTRUCTION INSPECTOR PRIOR TO, AND IN CONSIDERATION OF THE OWNER'S ACCEPTANCE OF THE WORK
- 22. THE CONTRACTOR SHALL ACCURATELY RECORD ALL LOCATIONS AND ELEVATIONS OF ALL ANGLE POINTS AND FITTINGS OF NEW UTILITIES, AND ABANDONED LINES.
- 23. THE CONTRACTOR SHALL SECURE A TRENCH PERMIT FROM THE CALIFORNIA DIVISION OF INDUSTRIAL SAFETY PRIOR TO EXCAVATION OF ANY TRENCH OVER FIVE FEET IN DEPTH.
- 24. PRIOR TO THE CONCLUSION OF THE WORK, THE CONTRACTOR SHALL REPAIR OR REPLACE IN KIND ALL DAMAGED PROPERTY FOR WHICH HE IS RESPONSIBLE (INCLUDING UTILITIES, DRAINAGE, CULVERTS, FENCING, CURB, GUTTER AND SIDEWALK). THE WORK SITE AND ADJACENT AREAS SHALL BE CLEANED UP. THIS REPAIR AND REPLACEMENT, AND CLEAN UP WORK SHALL BE SUBJECT TO THE APPROVAL AND ACCEPTANCE OF THE OWNER.
- 25. THE CONTRACTOR SHALL BE SOLELY RESPONSIBLE FOR FURNISHING, INSTALLING AND MAINTAINING ALL WARNING SIGNS AND DEVICES NECESSARY TO SAFEGUARD THE GENERAL PUBLIC AND THE WORK AND FOR PROVIDING PROPER AND SAFE ROUTING OF THE VEHICULAR AND PEDESTRIAN TRAFFIC DURING THE PERFORMANCE OF THE WORK. THIS REQUIREMENT SHALL APPLY CONTINUOUSLY AND SHALL NOT BE LIMITED TO WORKING HOURS. THE USE OF FLAGGERS, BARRICADES AND CONSTRUCTION SIGNING SHALL COMPLY WITH THE CURRENT EDITION OF WORK AREA AND TRAFFIC CONTROL HANDBOOK (W.A.T.C.H.) AND THE CALIFORNIA MIJICO.
- 26. PUBLIC SAFETY AND TRAFFIC CONTROL SHALL BE PROVIDED IN ACCORDANCE WITH COUNTY AND CALTRANS ENCROACHMENT PERMIT REQUIREMENTS. SAFE VEHICULAR AND PEDESTRIAN ACCESS SHALL BE PROVIDED AT ALL TIMES DURING CONSTRUCTION.
- 27. THE DEPARTMENT OF PUBLIC WORKS (DPW) SHALL HAVE FIRST RIGHT OF REFUSAL FOR AC GRINDINGS AND/OR REUSABLE AB MATERIAL THAT IS REMOVED. CONTRACTOR SHALL NOTIFY DPW ROAD MAINTENANCE DIVISION AT LEAST 24 HOURS PRIOR TO BEGINNING WORK TO DETERMINE IF DPW INTENDS TO RETAIN AC GRINDINGS AND/OR REUSABLE AB MATERIAL. IF DPW OPTS TO RETAIN ANY MATERIAL THEY WILL PROVIDE THE CONTRACTOR WITH A LOCAL SITE FOR THE CONTRACTOR TO DEPOSIT, AT CONTRACTOR'S EXPENSE, THE REUSABLE MATERIALS FOR THE BENEFIT OF DPW. IF DPW OPTS TO NOT RETAIN ANY MATERIAL THE CONTRACTOR SHALL BE SOLELY RESPONSIBLE FOR FINAL MATERIAL DISPOSAL.
- 28. THE CONTRACTOR MUST PROVIDE TEMPORARY TRAFFIC STRIPING IF EXISTING DELINEATIONS ARE DESTROYED DURING TRENCHING OR OTHER WORK, PAINTED MARKINGS OR STRIPING TAPE MAY BE USED. THE TEMPORARY STRIPING MUST BE APPROVED FOR MATERIAL AND LAYOUT BY THE COUNTY BEFORE TRENCHING OR OTHER WORK IS STARTED. THE CONTRACTOR, AT ITS EXPENSE, SHALL SANDBLAST ALL TEMPORARY PAINTED MARKINGS THAT ARE TO BE REMOVED.
- 29. CONTRACTOR SHALL PROVIDE ALL TEMPORARY UTILITIES NECESSARY TO INSTALL, TEST AND COMMISSION THE EQUIPMENT PRIOR TO OWNER ACCEPTANCE.
- 30. ALL TRAFFIC STRIPES, ARROWS, AND PAVEMENT MARKINGS SHALL BE REPLACED IN-KIND WITH LIKE MATERIALS (PAINT OR THERMOPLASTIC) TO THE SPECIFICATIONS SET FORTH IN CHAPTER 3 OF THE CALIFORNIA MUTCD LATEST EDITION.
- 31. THE CONTRACTOR IS RESPONSIBLE FOR PRESERVATION AND PROTECTION OF EXISTING SURVEY AND PROPERTY CORNER MONUMENTS THAT EXIST AT THE TIME OF CONSTRUCTION IN THE AREA WHERE CONSTRUCTION ACTIVITIES OCCUR. MONUMENTS DISTURBED, OR LOST, DUE TO CONSTRUCTION ACTIVITIES WILL

- REQUIRE THAT THE CONTRACTOR HAVE THEM REPLACED, IN KIND, BY A LICENSED CALIFORNIA LAND SURVEYOR, WHO WILL BE REQUIRED TO FILE WITH THE COUNTY EITHER A CORNER RECORD OR A RECORD OF SURVEY, WHICHEVER WILL MEET THE REQUIREMENTS OF THE LAND SURVEYOR'S ACT, SECTION 8771(B) AND (C).
- 32. CONTRACTOR SHALL COMPLY WITH BUSINESS AND PROFESSIONS CODE SECTION 8771(B) REGARDING REFERENCING, PRESERVING AND RECONSTRUCTING MONUMENTS, WHETHER OR NOT MONUMENTS ARE SHOWN IN THESE PLANS.
- 33. CONTRACTOR SHALL PROTECT ALL EXISTING FACILITIES AND SHALL RESTORE ANY DAMAGED FACILITIES TO EXISTING CONDITION.
- 34. CONTRACTOR SHALL BE RESPONSIBLE FOR RELOCATING/REINSTATING THE EXISTING IRRIGATION SYSTEM IF THIS IS NEEDED IN ORDER TO ACCOMPLISH THE WORK. THE REINSTATED IRRIGATION SYSTEM SHALL BE COMPLETED AND TESTED BY THE CONTRACTOR AND SHALL BE SUBJECT TO THE APPROVAL AND ACCEPTANCE OF THE OWNER.
- 35. THE CONTRACTOR SHALL AT ALL TIMES BE RESPONSIBLE FOR JOB SITE SECURITY OF THEIR VEHICLES, EQUIPMENT, TOOLS, MATERIALS, PERSONAL BELONGINGS, ETC. THE OWNER OR ITS AGENT SHALL NOT BE RESPONSIBLE FOR LOSS OR DAMAGE TO THESE ITEMS OR ANY OTHER ITEMS OWNED BY CONTRACTOR, EMPLOYEES OR SUBCONTRACTORS.
- 36. THE CONTRACTOR IS RESPONSIBLE FOR PROVIDING ALL CONSTRUCTION SURVEYING AND STAKING THAT MAY BE REQUIRED FOR CONSTRUCTION ACTIVITES, INCLUDING, BUT NOT LIMITED TO, SETTING ANY ELEVATIONS AS REQUIRED.
- 37. THE EXISTING SURVEYED FACILITIES AND TOPOGRAPHY SHOWN ON THESE PLANS IS BASED ON FIELD AND AERIAL SURVEYING FROM NELSON ENGINEERING IN AUGUST 2023. ALL DISCREPANCIES OR CLARIFICATIONS REGARDING SURVEY DATA PROVIDED SHALL BE REQUESTED BY CONTRACTOR AND RESOLVED BY ENGINEER IN WRITING PRIOR TO COMMENCING SITE WORK.
- 38. CONTRACTOR SHALL LIMIT STORAGE AND STAGING TO AREA INDICATED ON PLANS. STORAGE OR STAGING WITHIN OTHER AREAS AS NECESSARY OUTSIDE THE PROJECT AREA SHALL BE THE RESPONSIBILITY OF THE CONTRACTOR TO ARRANGE, COORDINATE AND PROVIDE.

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GENERAL NOTES

Electric Bus Charging Tinloy Street Transit

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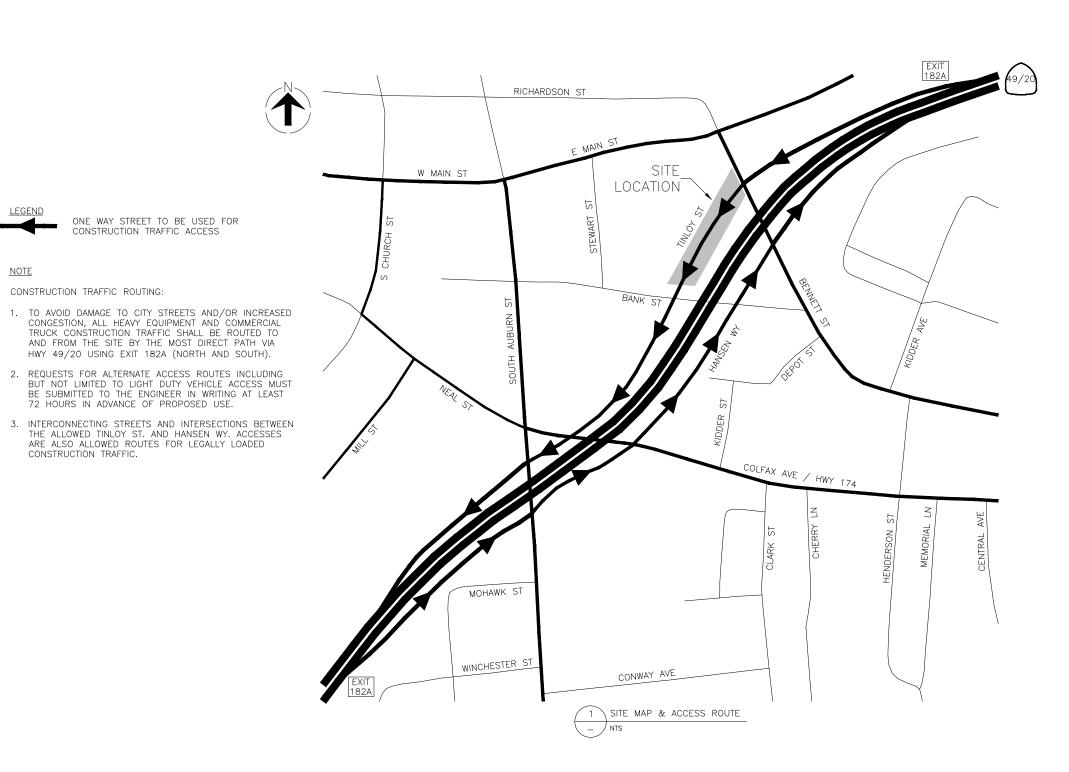
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Job No: 889830
Date: Dec. 18, 2024
Scale Reference

Drawing GC001




ONE WAY STREET TO BE USED FOR CONSTRUCTION TRAFFIC ACCESS

HWY 49/20 USING EXIT 182A (NORTH AND SOUTH).

NOTE

CONSTRUCTION TRAFFIC ROUTING:

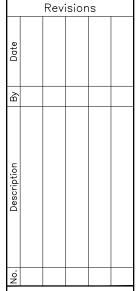



Project Center

Charging et Transit

Bus C Street

Electric Tinloy

Works Public

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ROUTE **CCESS** ⋖ ∞ MAP SITE

Nevada

Designed: RP SEW
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Job No: 889830
Date: Dec. 18, 2024
Scale Reference

Drawing GC103





<u>LEGEND</u>

SIGN

TYPE 2 BARRICADE

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TRAFFIC CONE

PARKING AREA

<u>NOTES</u>


1. TINLOY ST. POSTED SPEED LIMIT IS 30 MPH

SHEET NOTES

(1) WITHIN CONTINUOUS RUN OF K-RAIL PROVIDE MOVEABLE K-RAIL FOR ACCESS.

ALLOW SPACES BETWEEN SECTIONS OF K-RAIL TO ALLOW STREET TO DRAIN TO VALLEY GUTTER.


- (2) NORMAL OPERATIONS SHALL BE CONDUCTED BEHIND K-RAIL. WHEN OCCASIONAL TEMPORARY LANE CLOSURE IS NEEDED, PROVIDE SIGNAGE AND TRAFFIC CONES AS SHOWN.
- (3) COUNTY WILL MAKE ARRANGEMENTS FOR TEMPORARY BUS STOPS ON TINLOY ST BETWEEN BANK ST AND NEAL ST. STAGING/STORAGE IS NOT PERMITTED IN THIS AREA.
- THIS AREA CAN BE USED FOR PARKING OF CONTRACTOR ON—HIGHWAY VEHICLES BUT NOT FOR MATERIAL OR EQUIPMENT STORAGE.
- (5) ON SITE STORAGE/STAGING SHALL BE LIMITED TO THE AREA ENCLOSED BY THE K-RAIL AND BARRICADES
- PROVIDE SIGNAGE INDICATING LOCATION OF AND DIRECTION TO TEMPORARY BUS STOPS ON TINLOY ST BETWEEN BANK ST AND NEAL ST. ATTACH TO BARRICADES AND (E) SIGN POST / LIGHT POLE. PROVIDE DRAFT OF SIGN FOR ENGINEER APPROVAL.

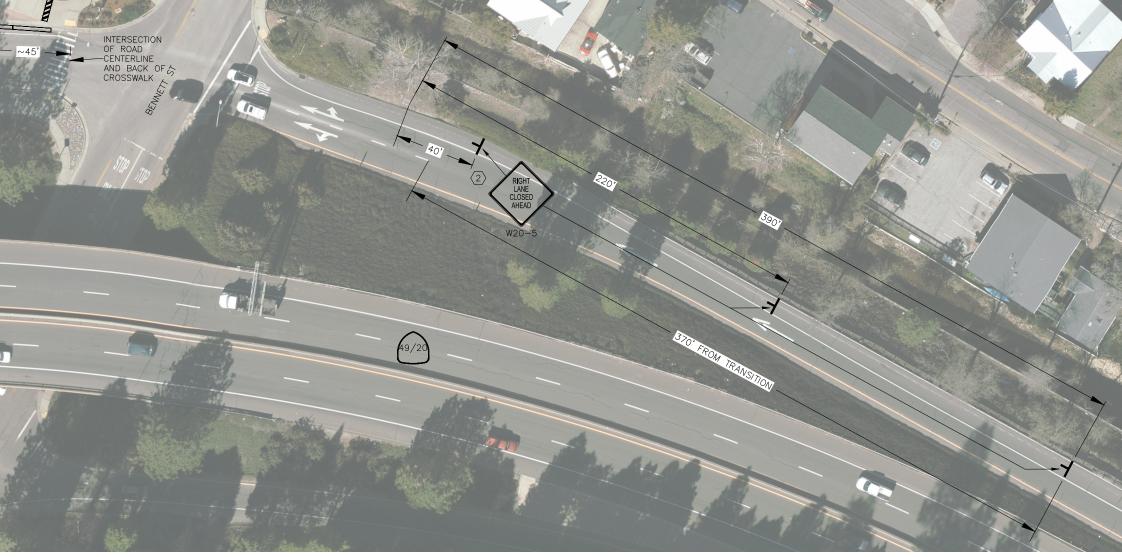

1 TRAFFIC CONTROL PLAN (NORTH)

1" = 50'



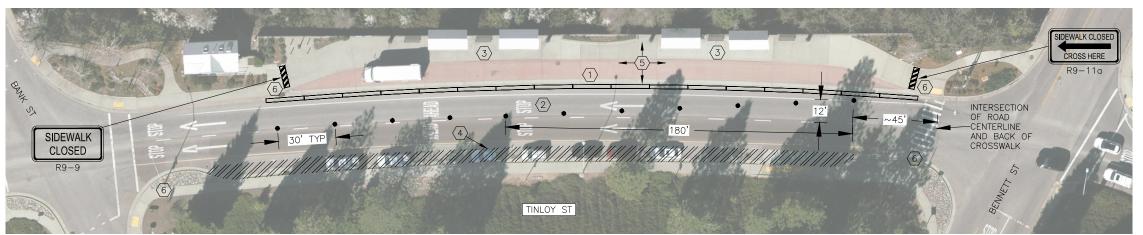

2 TRAFFIC CONTROL PLAN (SOUTH)
- 1" = 50'

Electric Bus Charging Project Tinloy Street Transit Center **TRAFFIC CONTROL PLAN** Works

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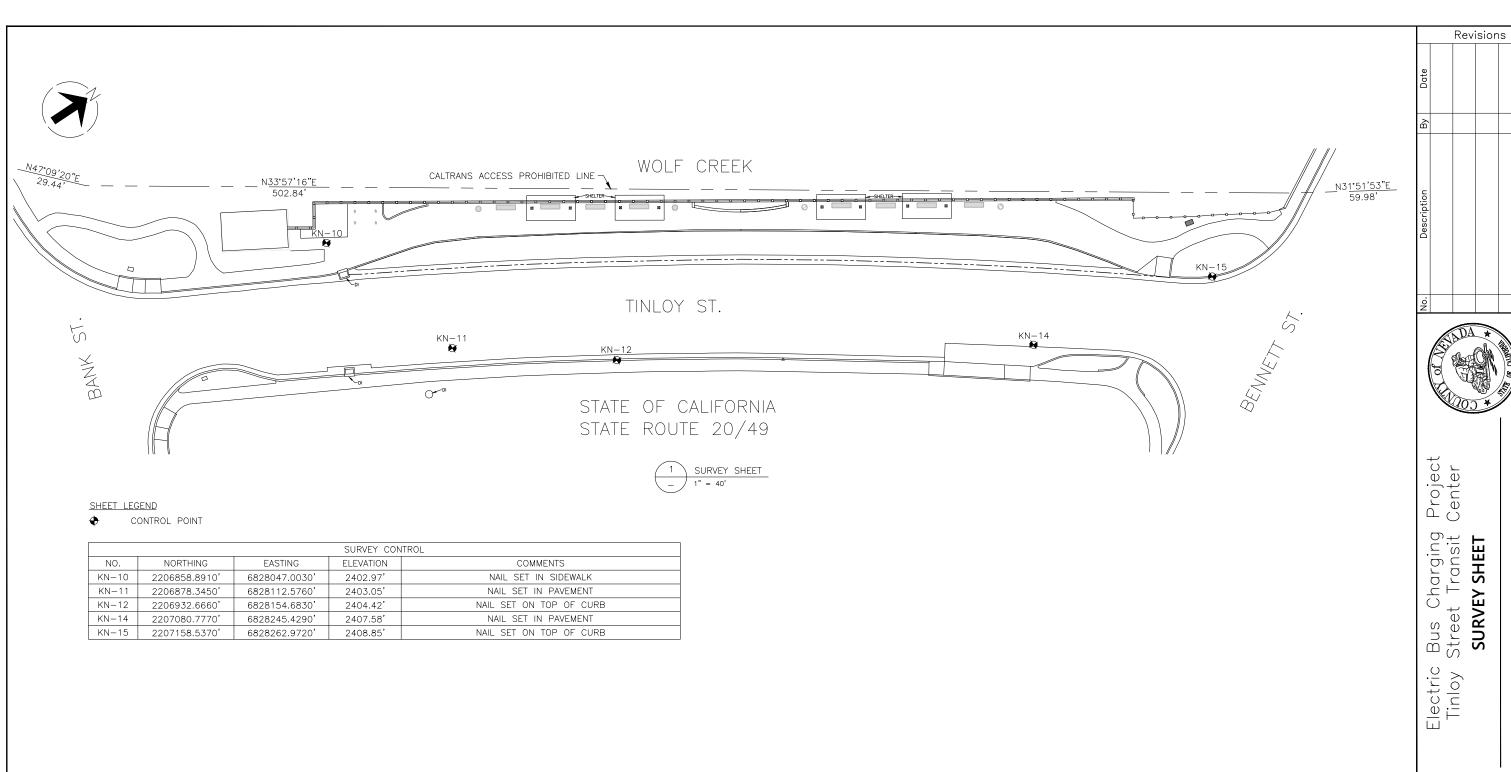
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Revisions

CIVIL NO. C52884 CEP. 12-31-20 CIVIL ONLY

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Date:	Dec. 18,	2024
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Project Center Bus Charging Street Transit (SURVEY SHEET Electric

Public Works

of

Department

County

Nevada

Designed:	RP SEW
Drawn:	RP
Checked:	SEW PP KN
Job No:	889830
Date: De	ec. 18, 2024
Scale	Reference

Drawing VF101

Revisions **NOTES** CALTRANS ACCESS PROHIBITED LINE (SEE DRAWING VF101) 1. PROTECT IN PLACE ALL EXISTING FACILITIES NOT TO BE DEMOLISHED. 2. CONTRACTOR SHALL CONTACT U.S.A. (UNDERGROUND SERVICE ALERT) AT LEAST 48 HOURS PRIOR TO EXCAVATING ANY AREA CONTAINING UNDERGROUND UTILITIES. <u>LEGEND</u> TO BE DEMOLISHED 14 CLEARING & GRUBBING IRRIGATION EQUIPMENT ALTERATIONS ROCK SWALE/FEATURE (E)FACILITIES NOTES (1) IE OF 24" SS MAIN APPROX 11' BELOW STREET GRADE TINLOY ST. 2 IE OF 24" SW APPROX 4.5' BELOW STREET GRADE AT THIS POINT SHEET NOTES (1) REMOVE REINFORCED PCC TURNOUT (2) REMOVE REINFORCED PCC SIDEWALK (2A) REMOVE (E) SIDEWALK CLEANLY TO (E) JOINT (3) REMOVE PLANTS, LANDSCAPING MATERIALS, SOIL ETC. AS NEEDED IN PREPARATION FOR (N) GA CABINET PAD AND (N) SWITCHGEAR HOUSEKEEPING PAD. $\overline{\langle 4 \rangle}$ REMOVE IRRIGATION SYSTEM. PROVIDE BYPASS TO MAINTAIN EXISTING FUNCTIONALITY OF ALL DOWNSTREAM IRRIGATION EQUIPMENT. Projec Center (5) REMOVE REINFORCED PCC PLANTER WALL TO CENTRAL JOINT DEMOLITION PLAN (NORTH) 6 REMOVE REINFORCED PCC PLANTER WALL TO RETAINING WALL. PROTECT (E) RETAINING WALL CALTRANS ACCESS PROHIBITED LINE (SEE DRAWING VF101) 7 REMOVE TREES, PLANTS, LANDSCAPING MATERIALS, SOIL ing ETC. AS NEEDED IN PREPARATION FOR (N) WORK. REMOVE IRRIGATION EQUIPMENT THAT PREVIOUSLY SERVED nargi Frans THE REMOVED PLANTER AREA. RECONFIGURE IRRIGATION EQUIPMENT SERVING THE RETAINED PLANTER AREA AS REQUIRED TO MAINTAIN FUNCTIONALITY AND ENSURE THAT ALL DOWNSTREAM IRRIGATION EQUIPMENT MAINTAINS FUNCTIONALITY. \bigcirc (9) REMOVE PLANTER CURB Bus Stree (10) REMOVE EXISTING IRRIGATION SYSTEM. MAINTAIN PRE-PROJECT FUNCTIONALITY OF ALL DOWNSTREAM IRRIGATION EQUIPMENT. (E) IRRIGATION CONTROL IS REQUIRED FOR DOWNSTREAM COMPONENTS, RELOCATE ectric AND ACCOMODATE IN (N) SIDEWALK. (11) REMOVE CURB AS NECESSARY TO PLACE (N) CONDUIT RUNS/DUCT BANKS. PROTECT (E) CURB IN PLACE WHERE $\check{\Phi}$ 2 $\pm i \pm 1$ (12) (E) RETAINING WALL & FENCE - PROTECT IN PLACE (13) (E) VALLEY GUTTER - PROTECT IN PLACE TINLOY ST. (14) ROUTE OF UNDERGROUND CONNECTIONS TO (E) CAMERAS HAS NOT BEEN LOCATED. CONTRACTOR SHALL PROTECT ~24' UNDERGROUND CONNECTIONS. (15) ROCK FROM (E) ROCK SWALE/FEATURE SHALL BE REMOVED AND REUSED TO SURROUND THE (N) SWITCHGEAR EQUIPMENT PAD LOCATED IN LANDSCAPING. (16) RESTORE LANDSCAPING TO ORIGINAL CONDITION 47 APPROXIMATE LOCATION OF (E) 3" GSP WATER PIPE. PIPE IS SHOWN AS CALTRANS IRRIGATION ON PLANS FOR PREVIOUS PROJECT. IT IS NOT CLEAR FROM PLANS IF IT WAS REMOVED, Designed: ABANDONED IN PLACE OR IS STILL ACTIVE. CONTRACTOR SHALL POTHOLE TO LOCATE AND REMOVE THE PIPE IF Drawn: IRR BOXES INACTIVE/ABANDONED OR RELOCATE AND MAINTAIN CONNECTIONS Checked: SEW PP EL IF PIPE IS ACTIVE. Job No: Date: Dec. 18, 2024 Scale Reference DEMOLITION PLAN (SOUTH) Drawing

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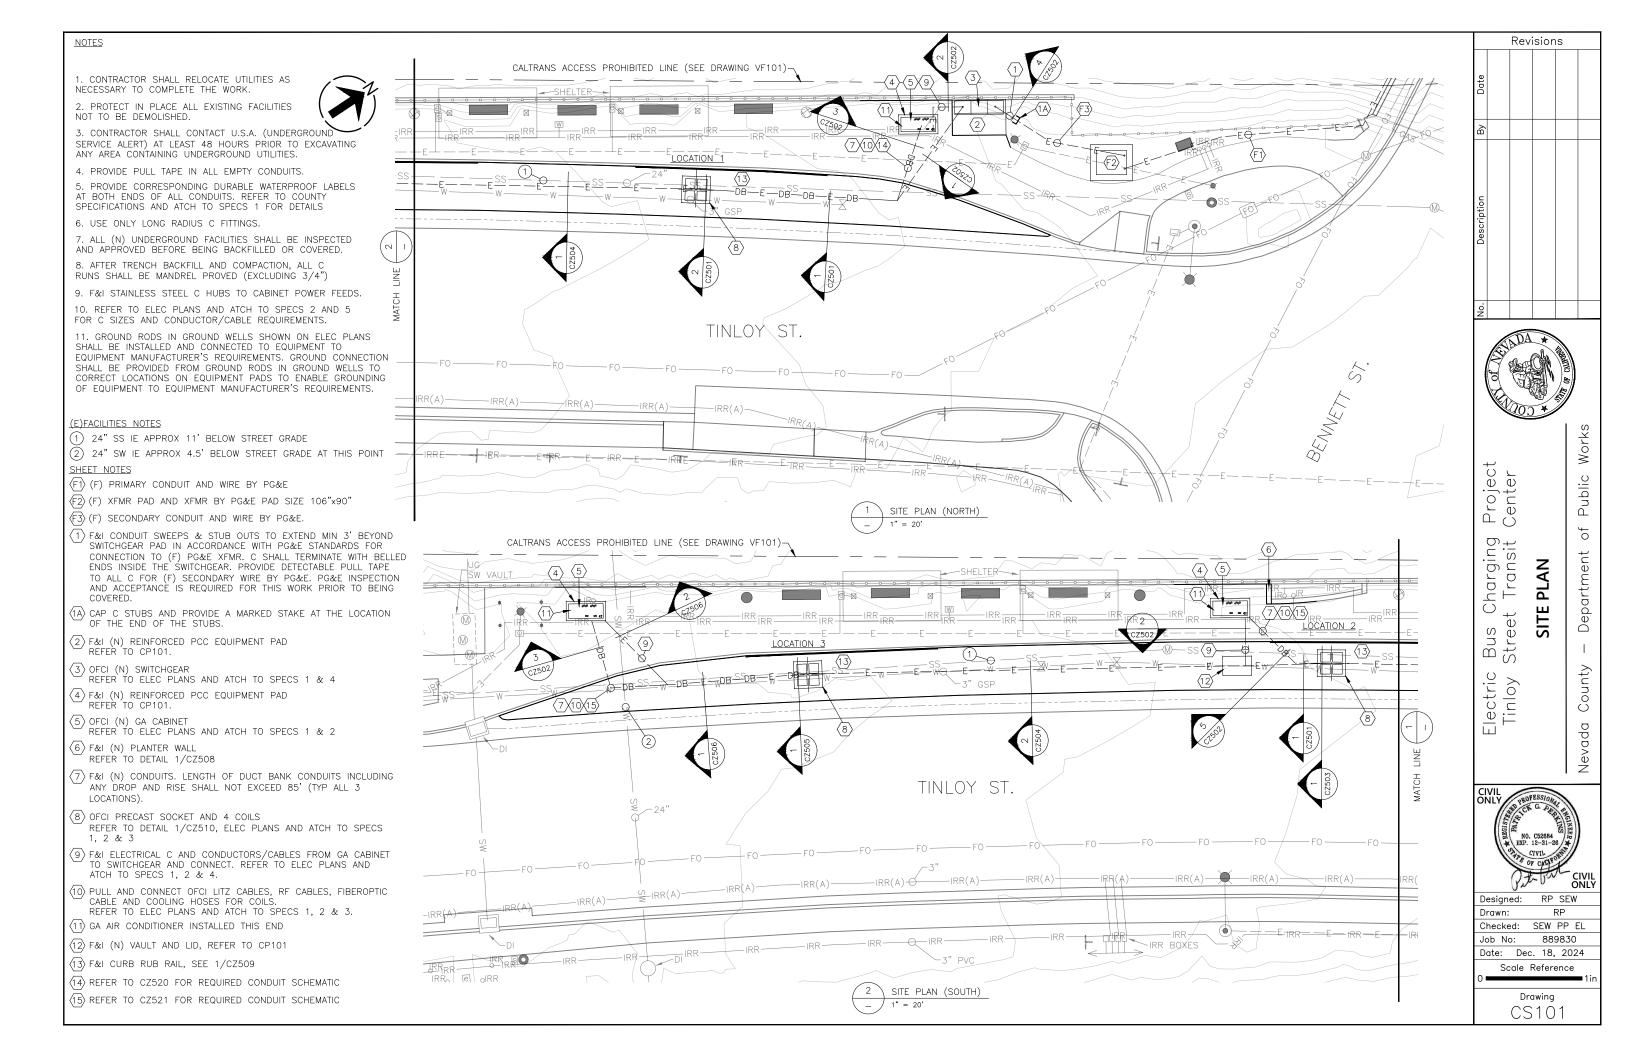
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DEMOLIT



NOTES

- 1. PAINT CURB SECTIONS BETWEEN JOINTS IN SIDEWALK AS SHOWN ON SITE PLAN. (NOTE THE 6" BAND OF COLOR 009DDE)
- 2. PREPARE CURB SURFACE AND APPLY PRIMER AND PAINT IN ACCORDANCE WITH MANUFACTURER'S INSTRUCTIONS.
- 3. USE PREVIOUSLY APPLIED CANS OF PAINT FOR COLOR MATCHING. COORDINATE WITH NEVADA COUNTY FACILITIES SERVICES DEPARTMENT FOR ACCESS.
- 4. FOR FUTURE MAINTENANCE, PROVIDE TO THE COUNTY A COMPLETE LIST OF PRODUCTS USED AND COPIES OF ALL PAINT FORMULAS. IF USEABLE AMOUNTS OF PAINT ARE LEFT AFTER CURBS ARE PAINTED, COUNTY RESERVES THE OPTION TO KEEP PAINT FOR FUTURE USE.

FOR NEW CURB


- 5. APPLY BENJAMIN MOORE "FRESH START" ACRYLIC PRIMER OR EQUAL.
- 6. APPLY 2 COATS OF BENJAMIN MOORE "COROTECH COMMAND" SATIN WATERBORNE ACRYLIC URETHANE OR EQUAL


FOR CURB THAT IS ALREADY PAINTED


- IF THE EXISTING PAINT IS SOUND:
- 7. CLEAN THE SURFACE AND APPLY 2 COATS OF BENJAMIN MOORE "COROTECH COMMAND" SATIN WATERBORNE ACRYLIC URETHANE OR EQUAL.
- IF THE EXISTING PAINT IS FAILING:
- 8. SCRAPE/SAND TO REMOVE ALL LOOSE PAINT.
- 9. APPLY BENJAMIN MOORE "FRESH START" ACRYLIC PRIMER OR EQUAL.
- 10. APPLY 2 COATS OF BENJAMIN MOORE "COROTECH COMMAND" SATIN WATERBORNE ACRYLIC URETHANE OR EQUAL


FOR NON-CUSTOM COLORS ("RED" AND "WHITE")


11. PAINT CAN BE A SUITABLE LATEX TRAFFIC PAINT AND DOES NOT HAVE TO BE BENJAMIN MOORE "COROTECH COMMAND", BUT FOLLOW ALL OTHER REQUIREMENTS ABOVE.

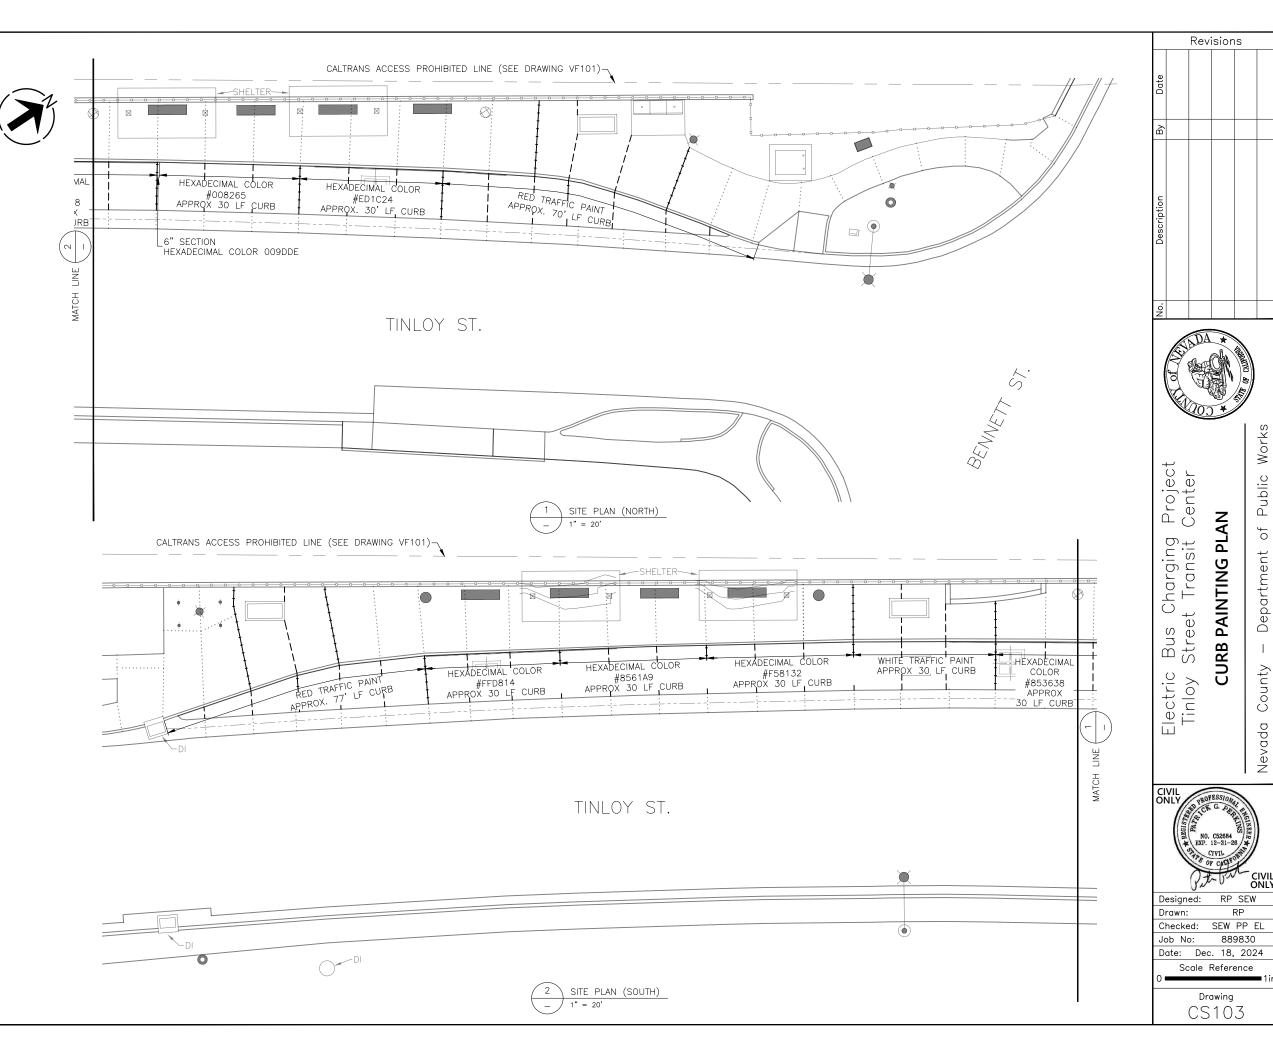


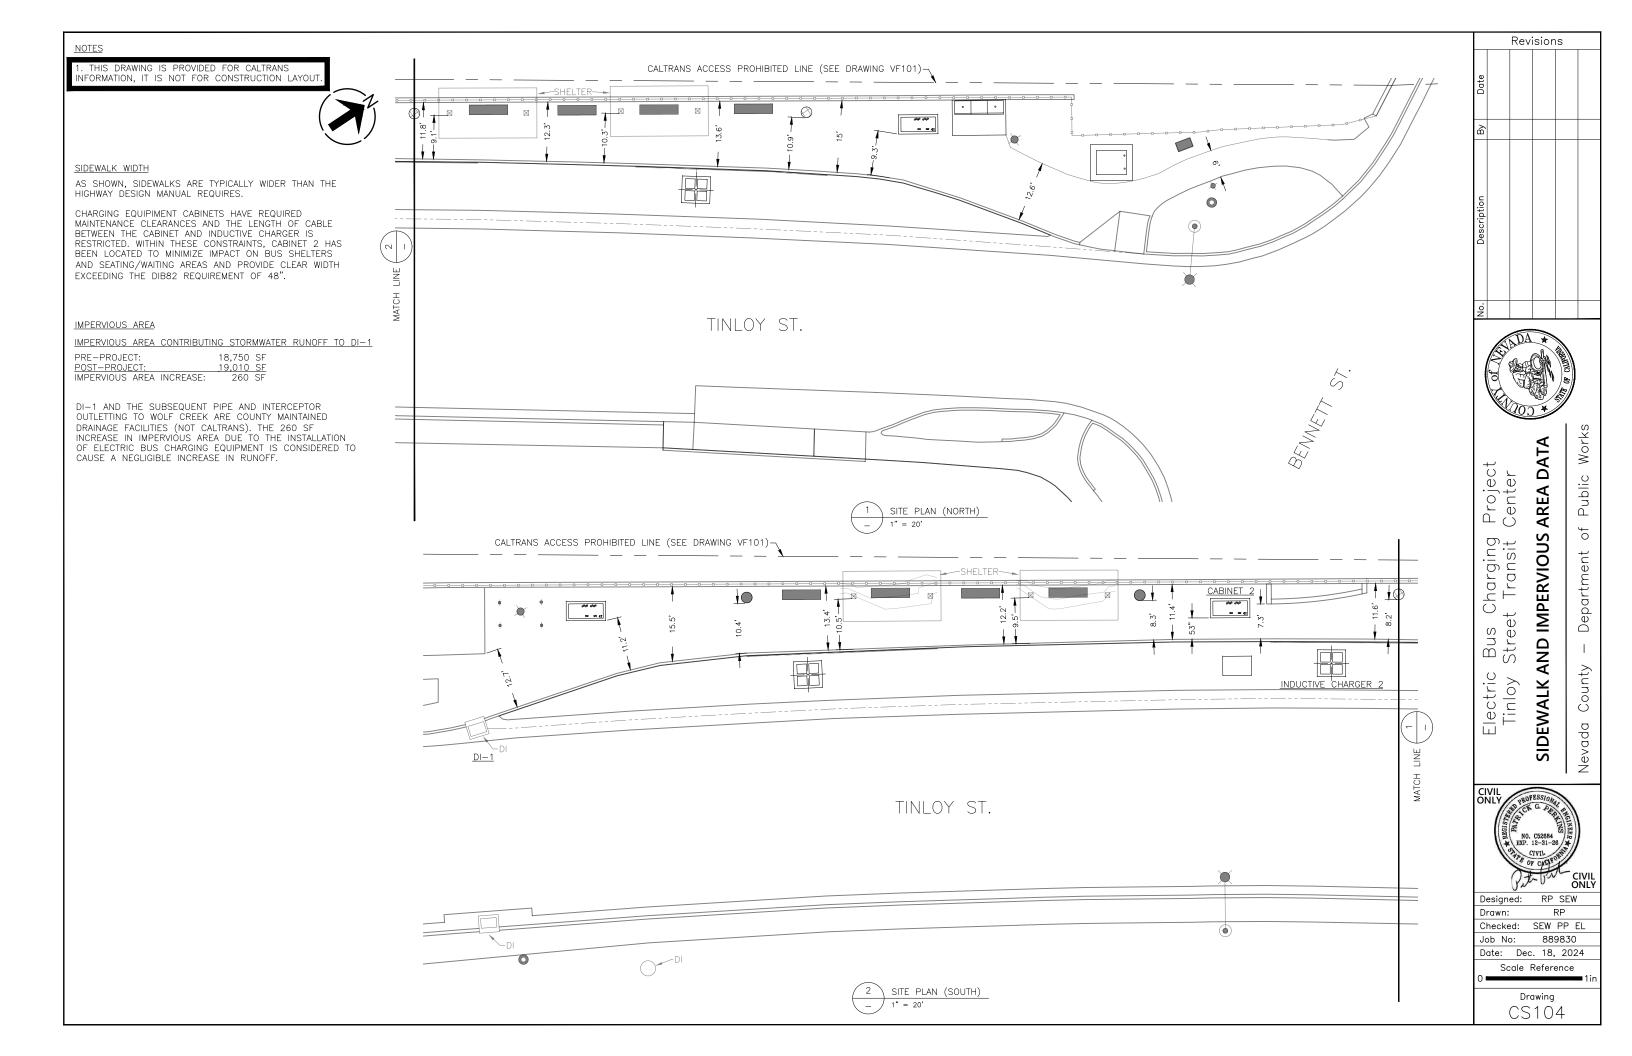


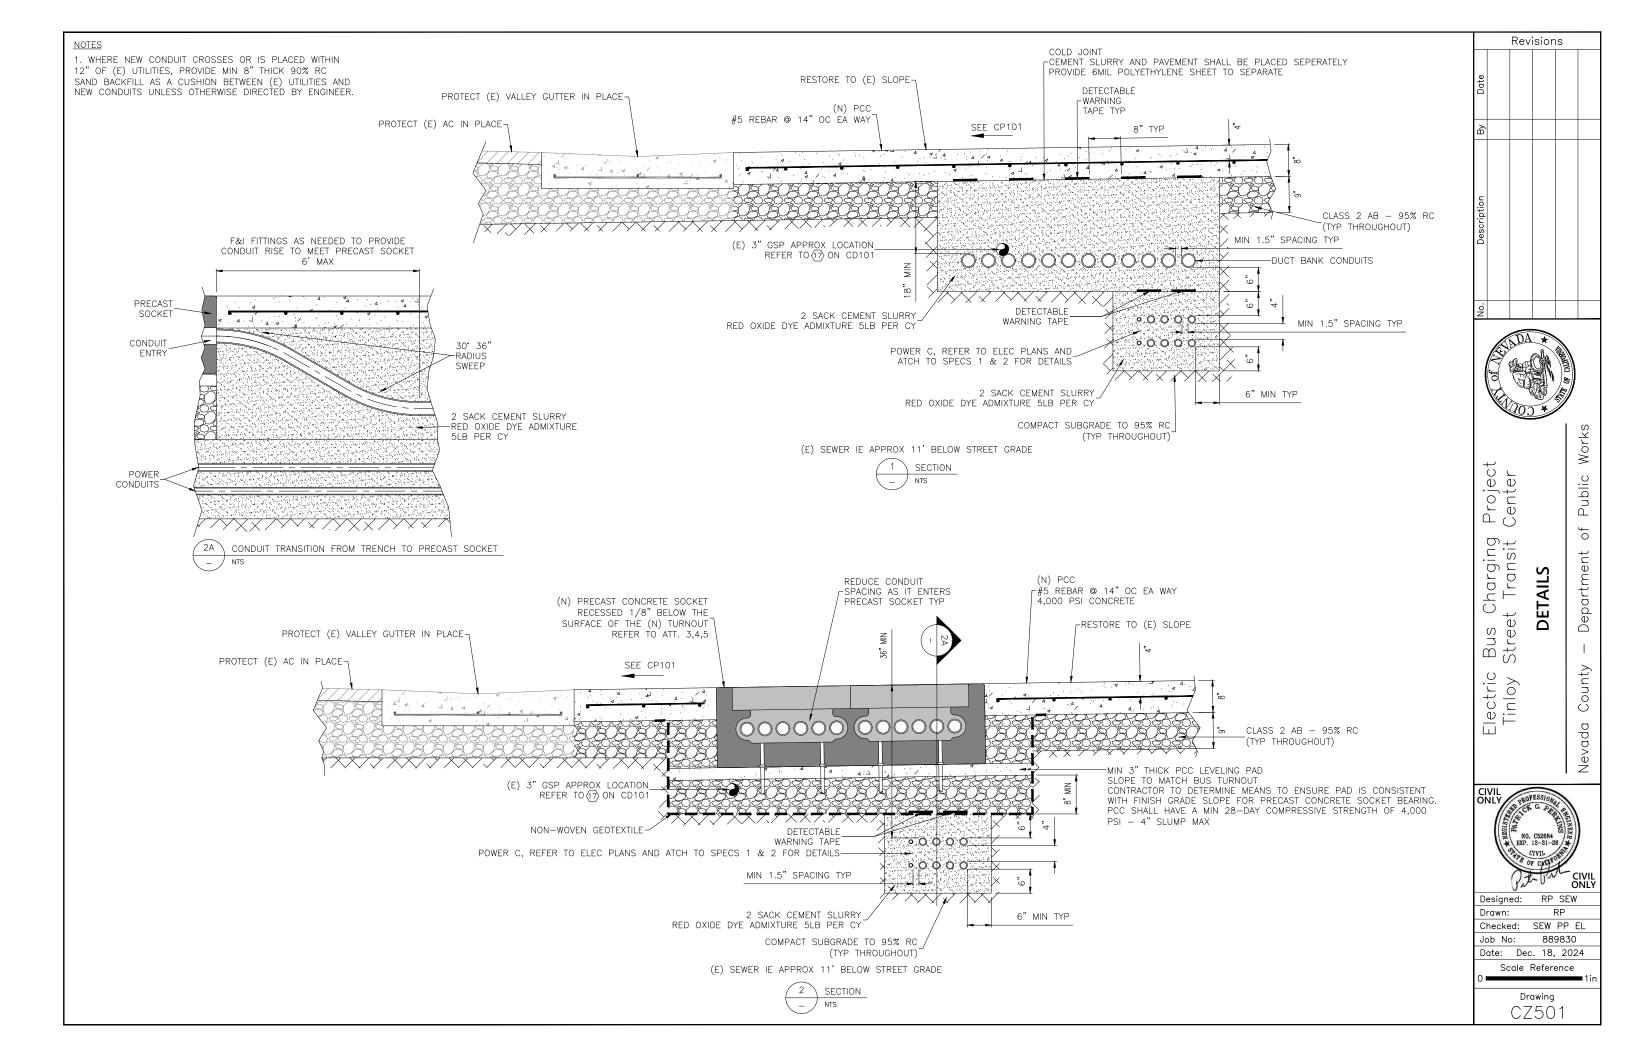


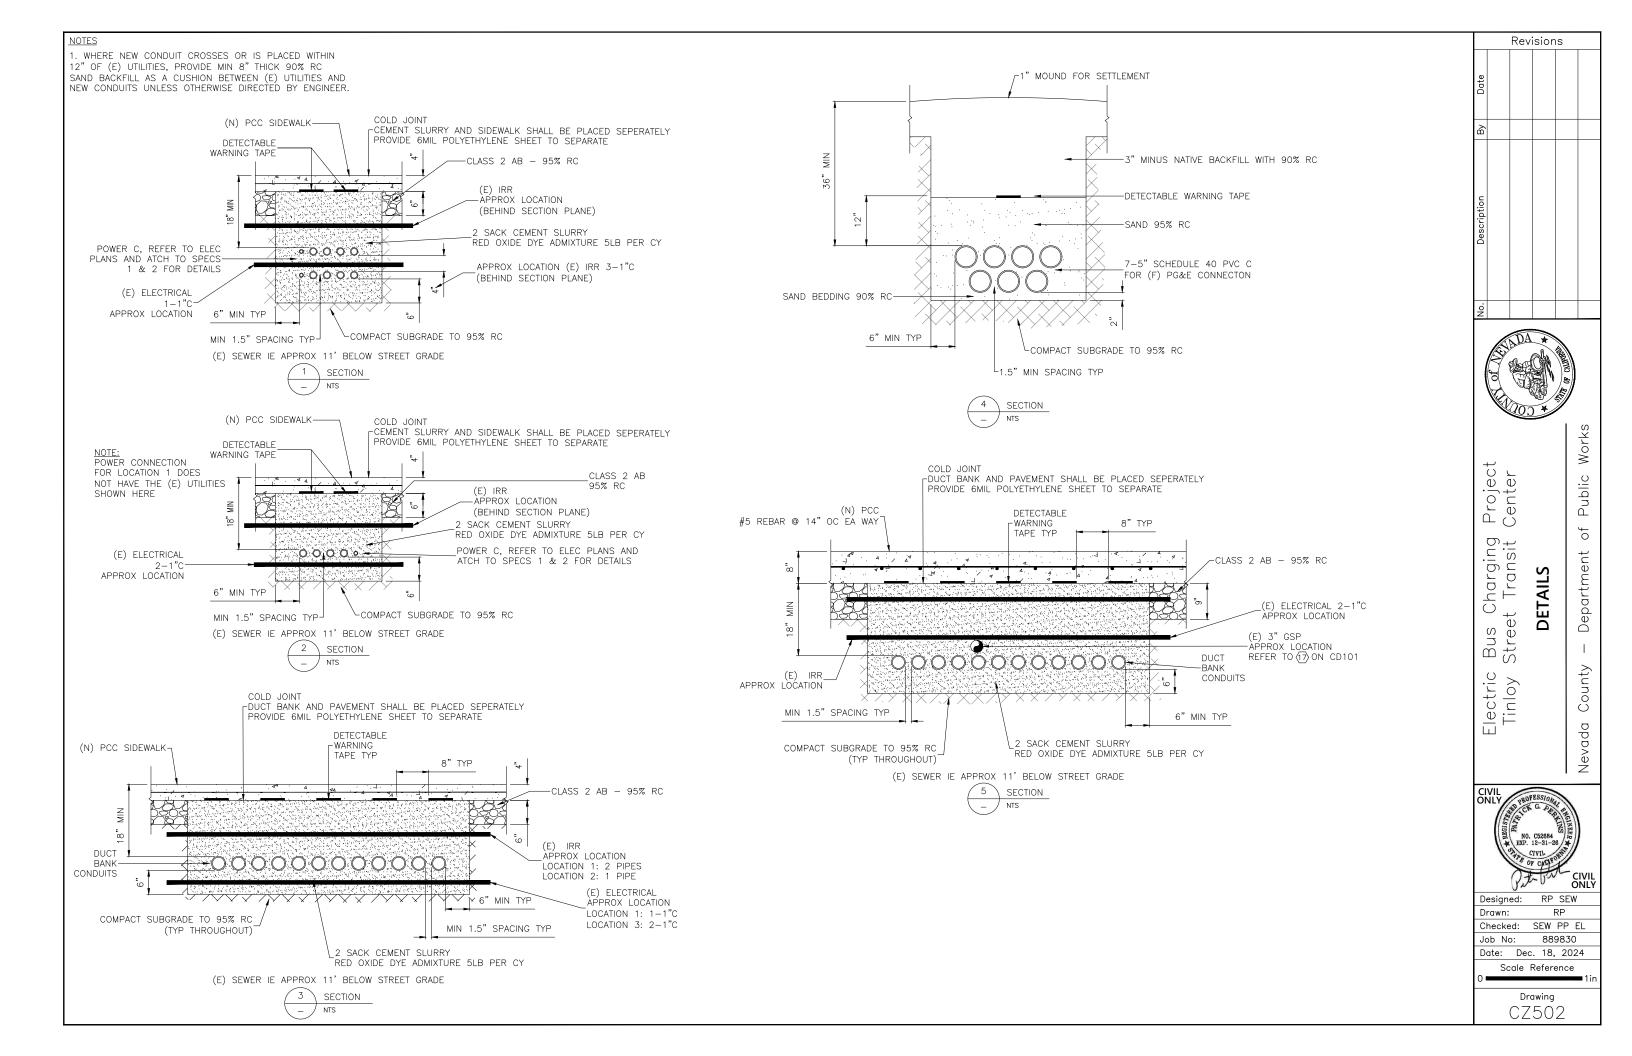


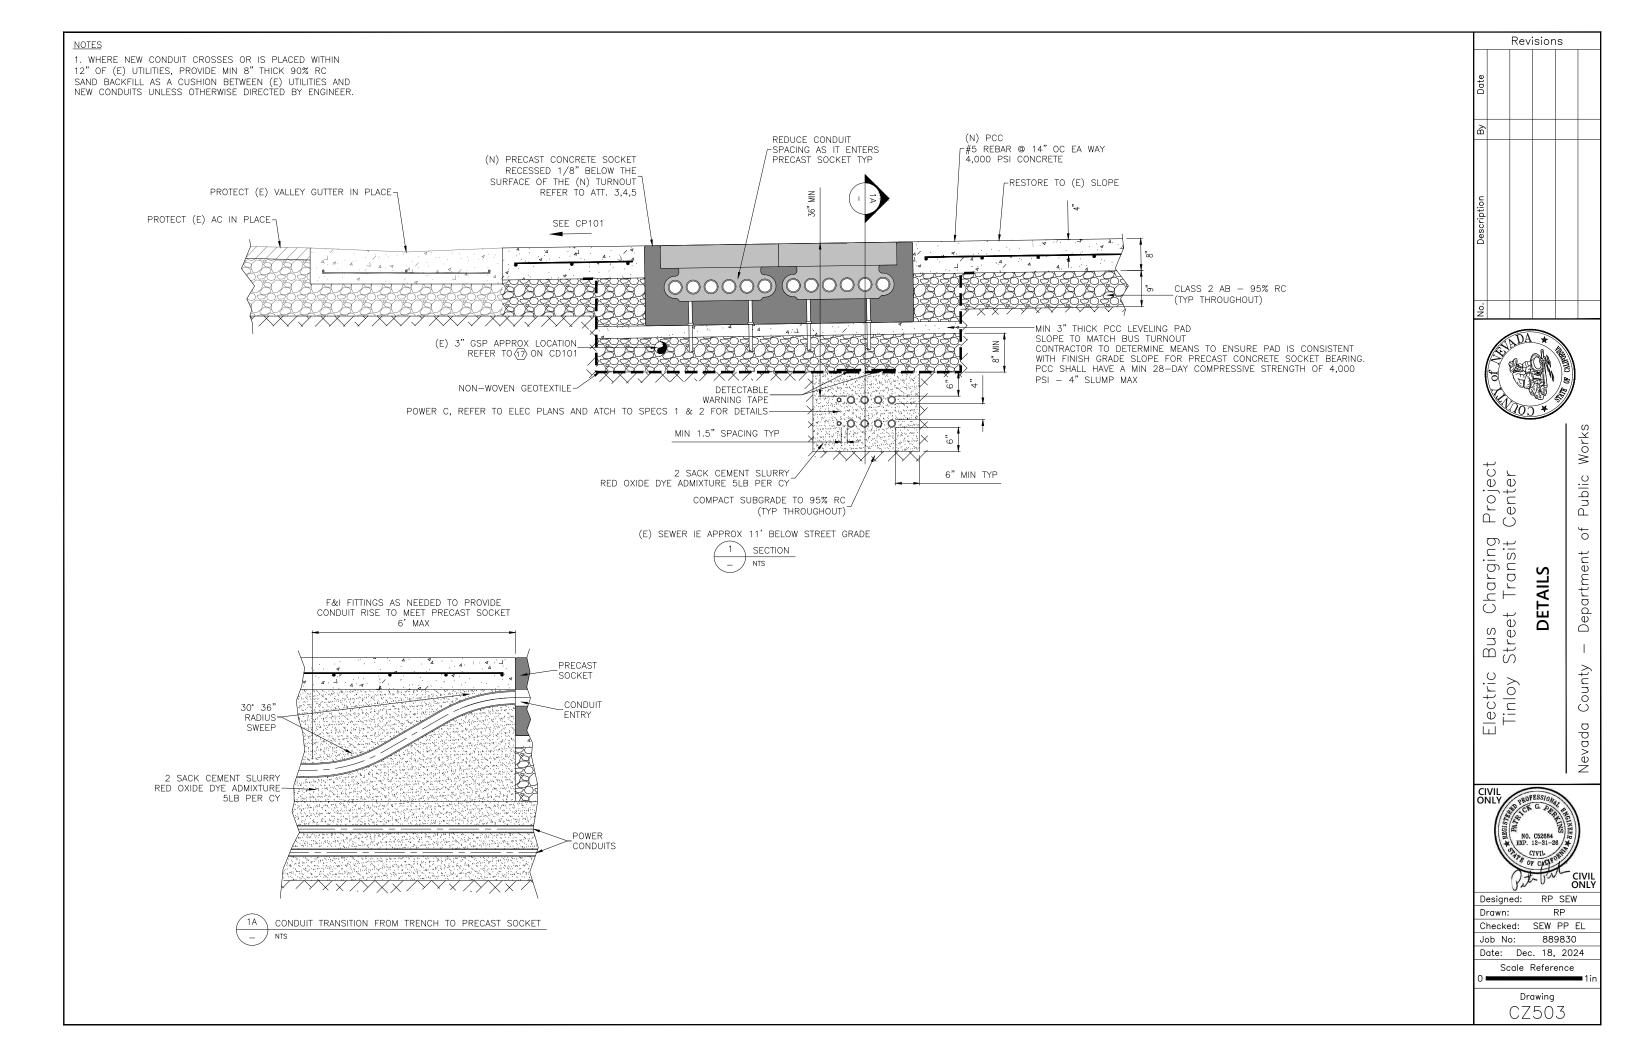


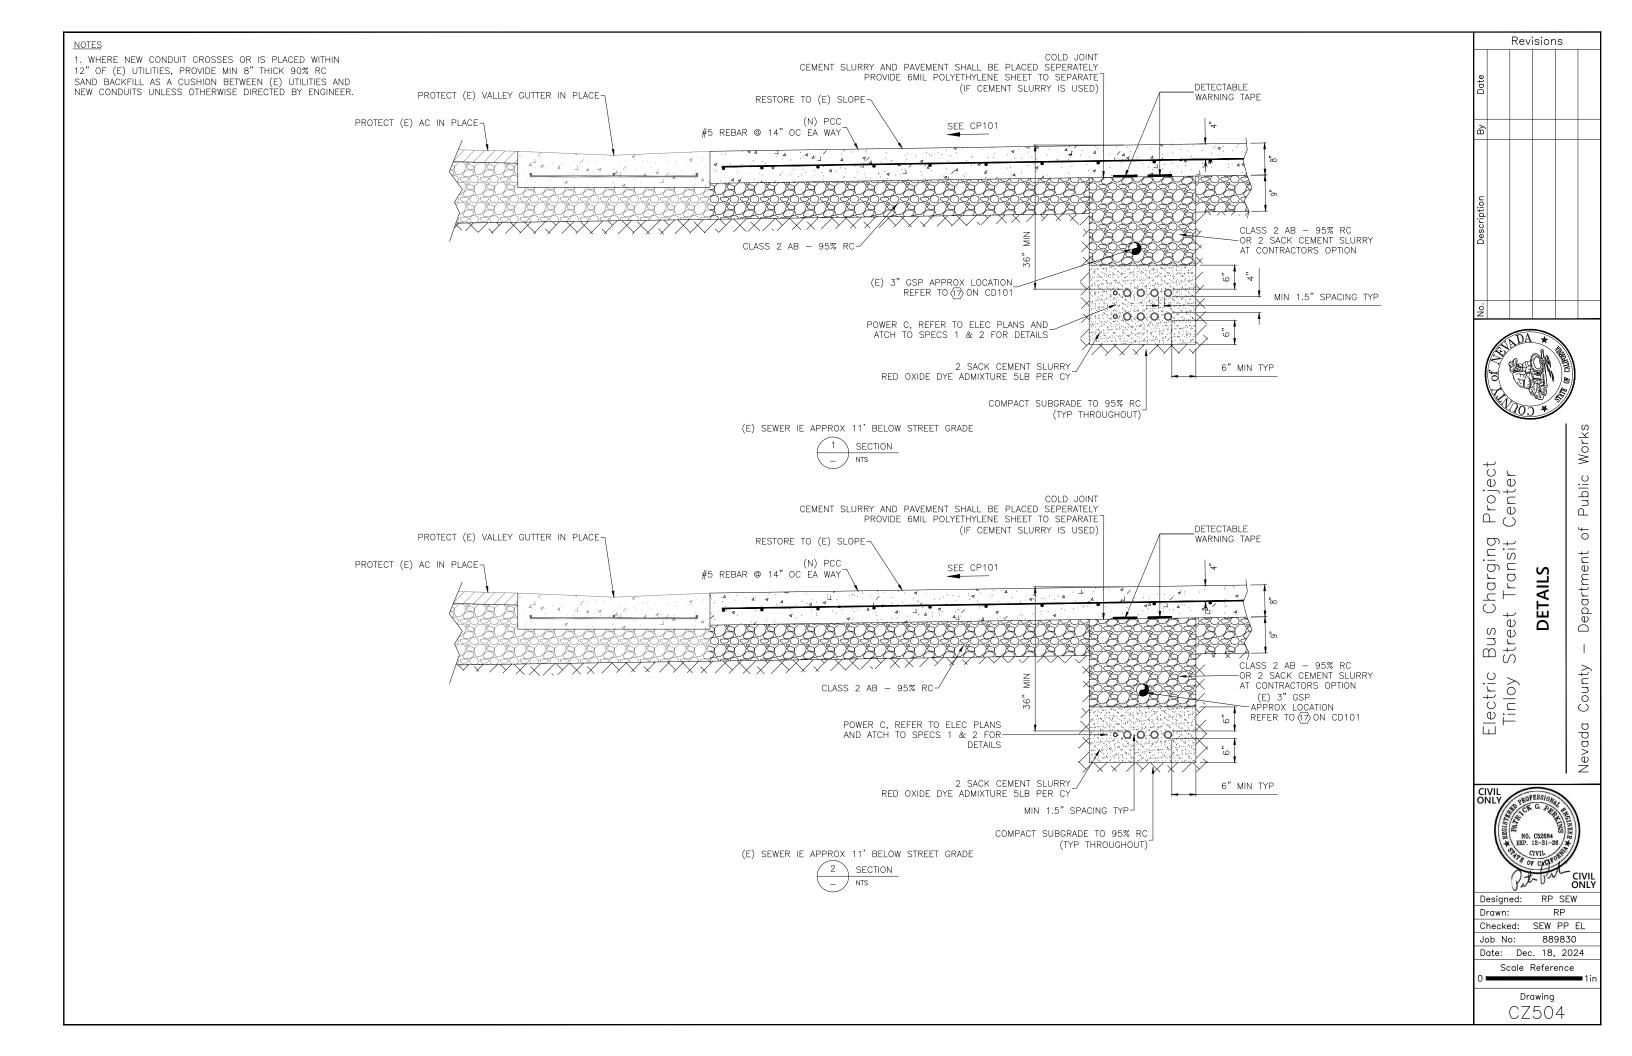

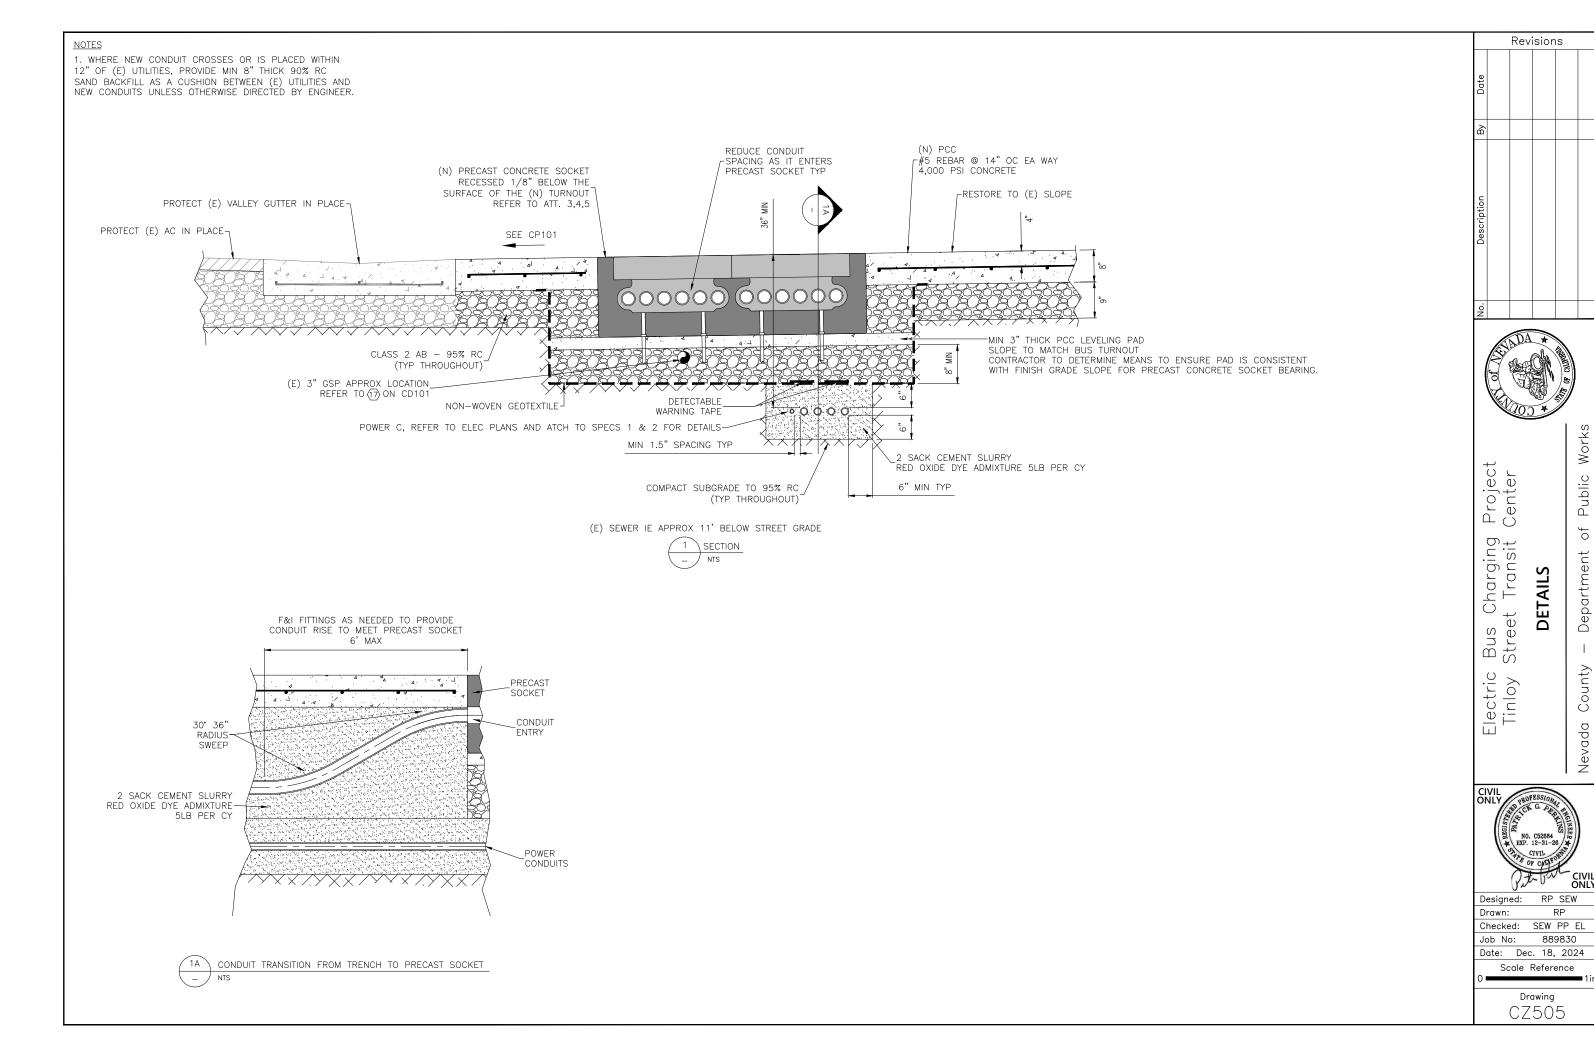

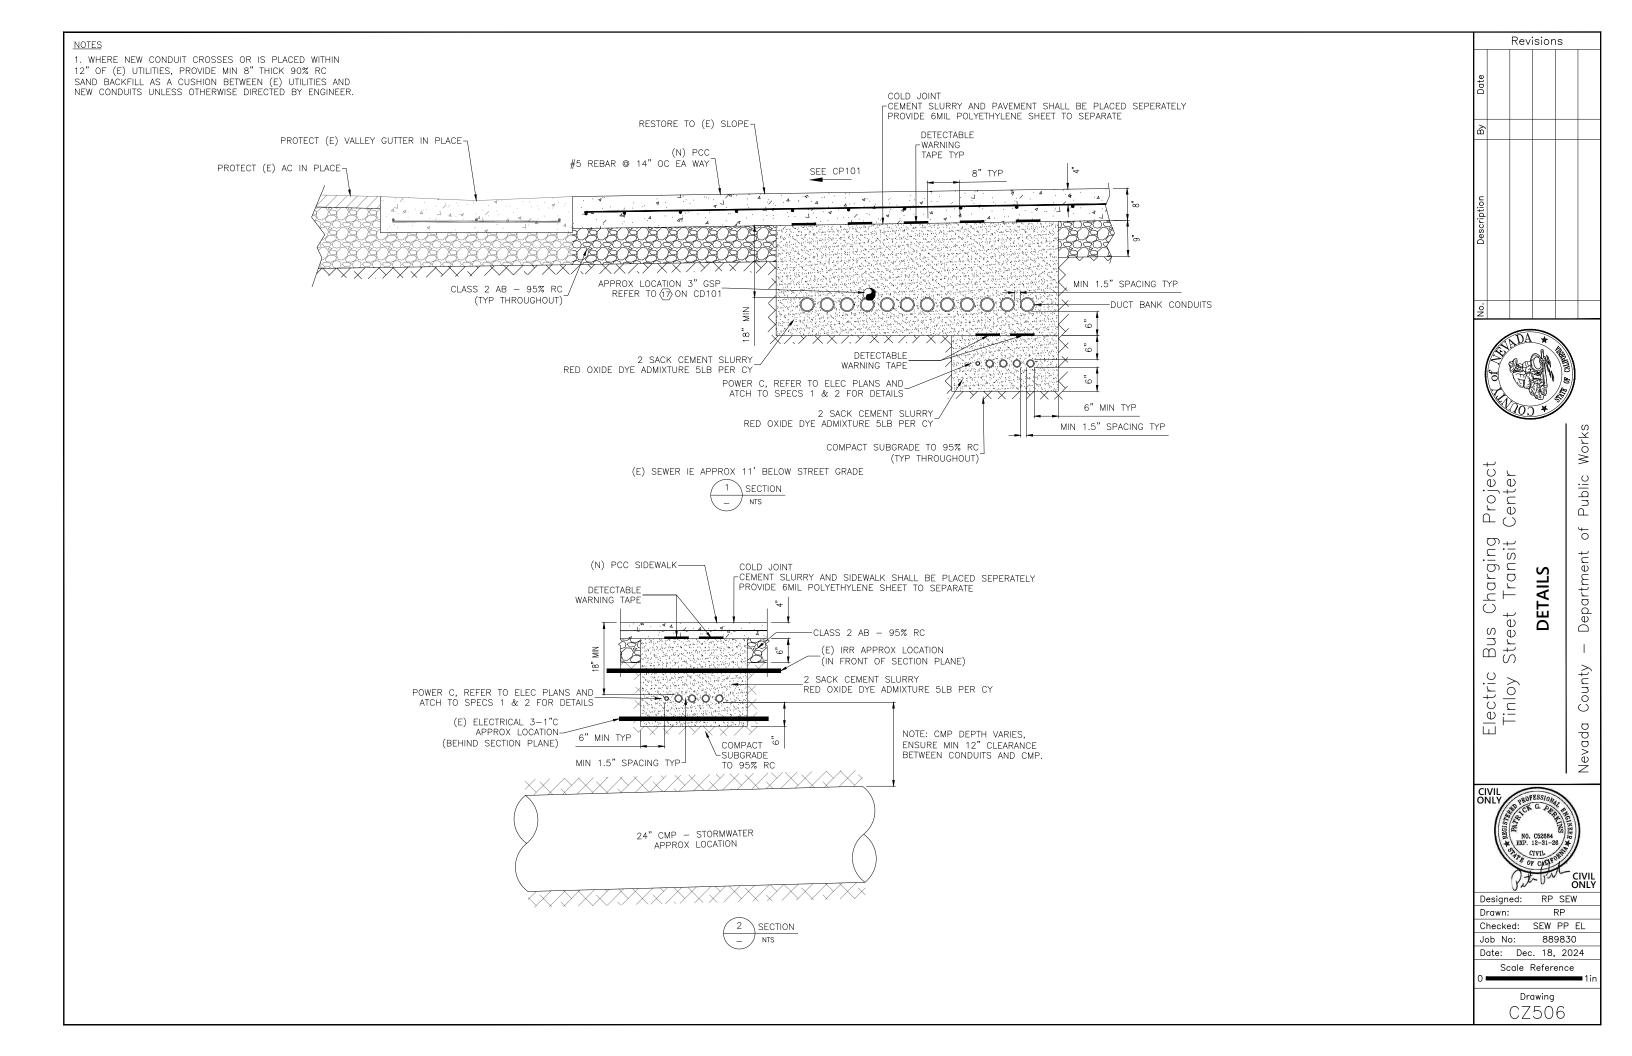

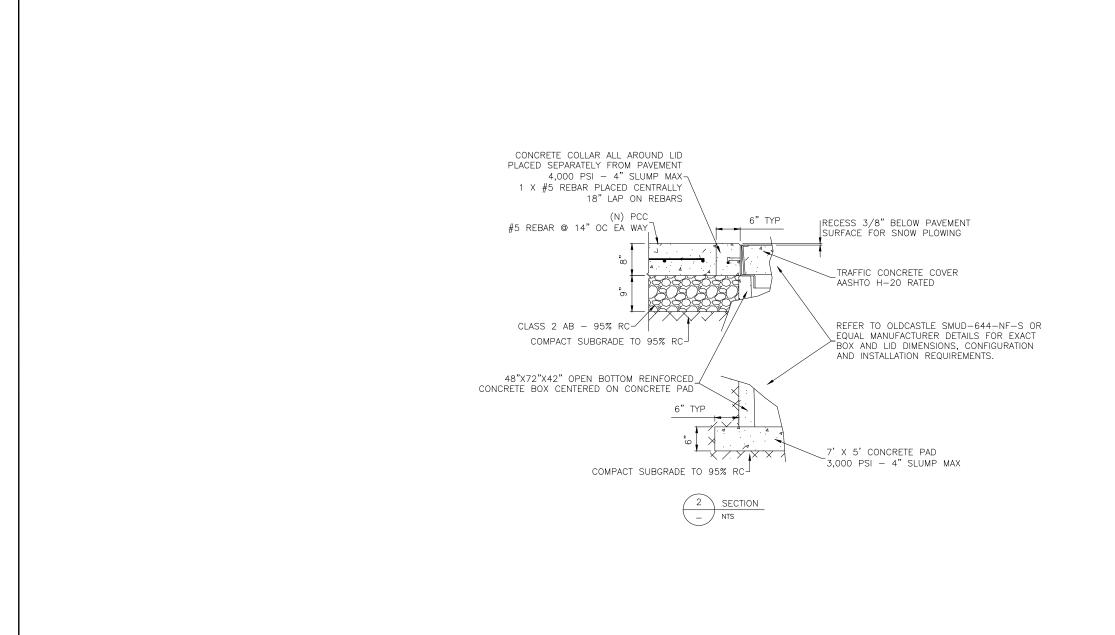

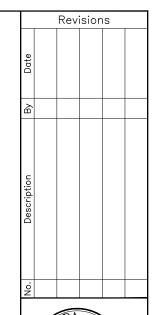



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DETAILS


Bus C Street

Electric Tinloy

Nevada


Designed:	RP SEW
Drawn:	RP
Checked:	SEW PP EL
Job No:	889830
Date: De	c. 18, 2024

Scale Reference

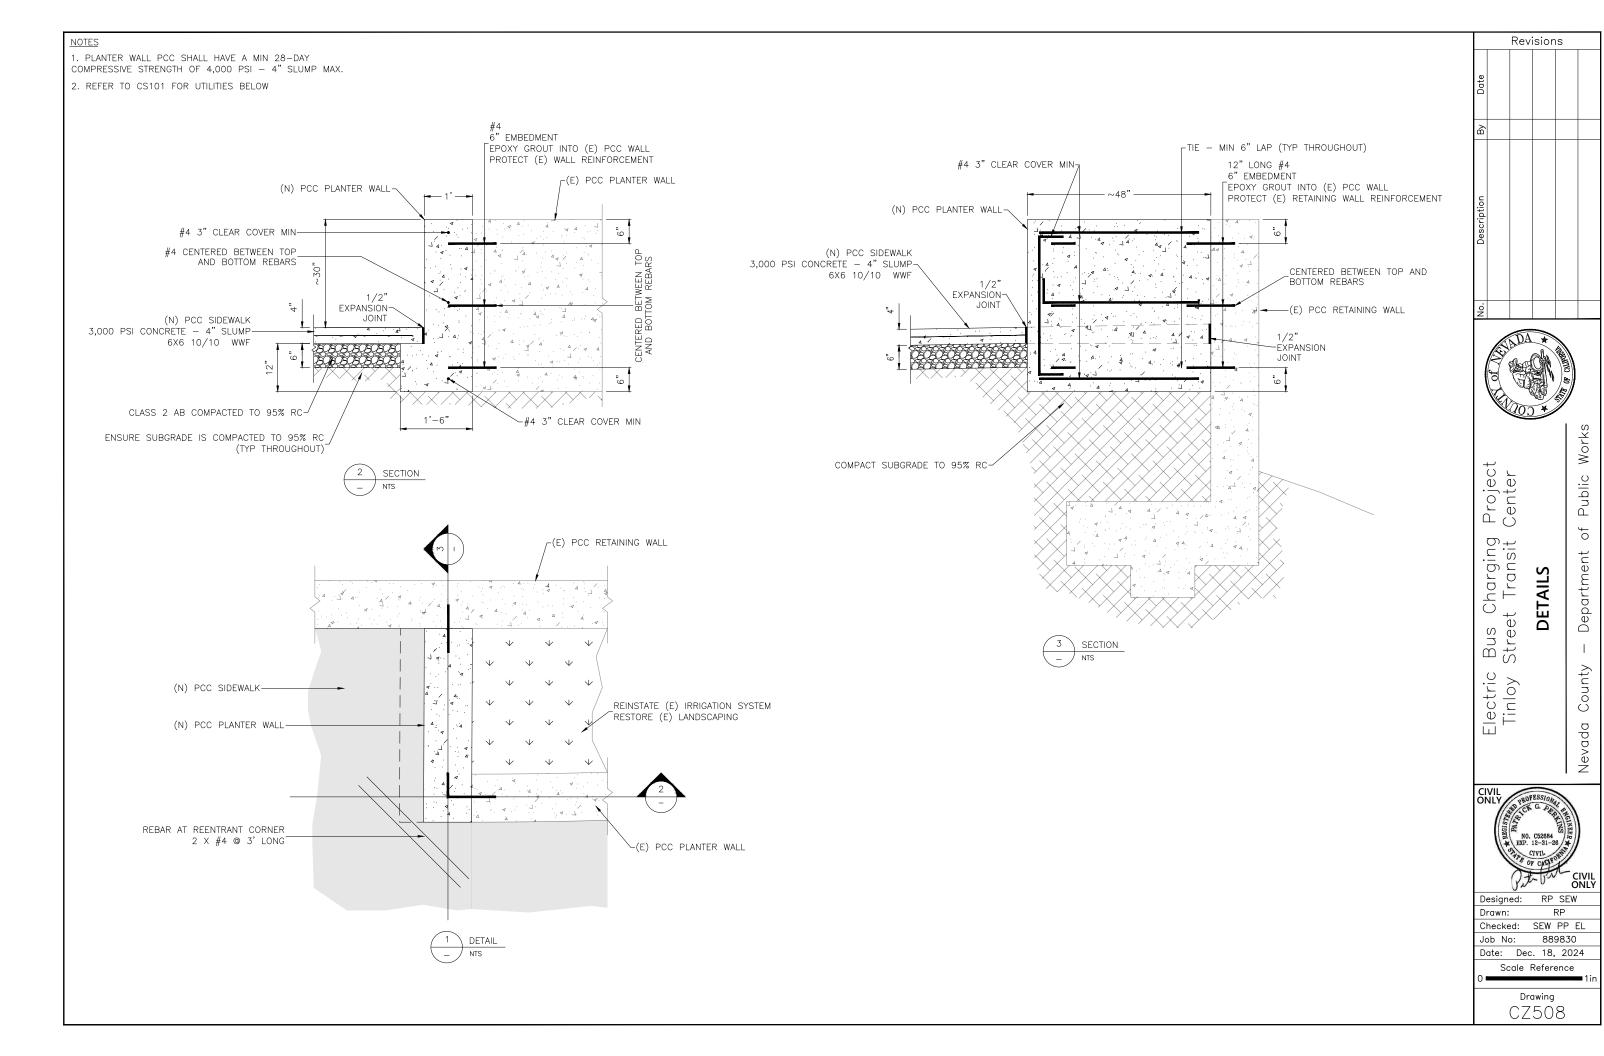



NOTES 1. ANC 2. ANC 3. PRICTHEY A


- 1. ANCHOR SPACING TO RUB RAIL MANUFACTURER REQUIREMENTS
- 2. ANCHOR INSTALLATION TO RUB RAIL AND ANCHOR MANUFACTURER REQUIREMENTS
- 3. PRIOR TO ADDING EPOXY, CUT ANCHOR RODS AS NECESSARY TO ENSURE THEY ARE RECESSED MIN 1" BEHIND THE FACE OF THE RUB RAIL

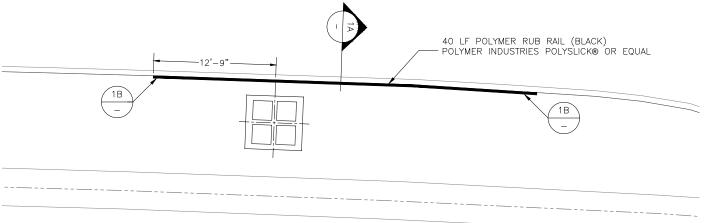

1 TYPICAL RUB RAIL LAYOUT NTS

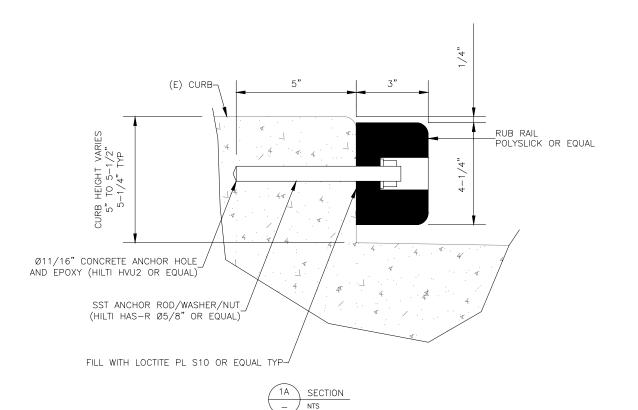

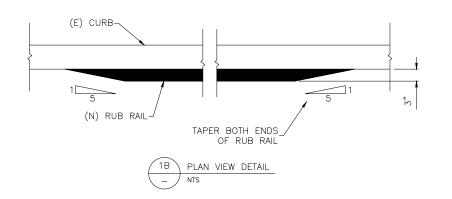

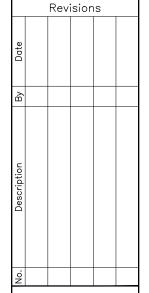



Electric Bus Charging Project Tinloy Street Transit Center **DETAILS** Works

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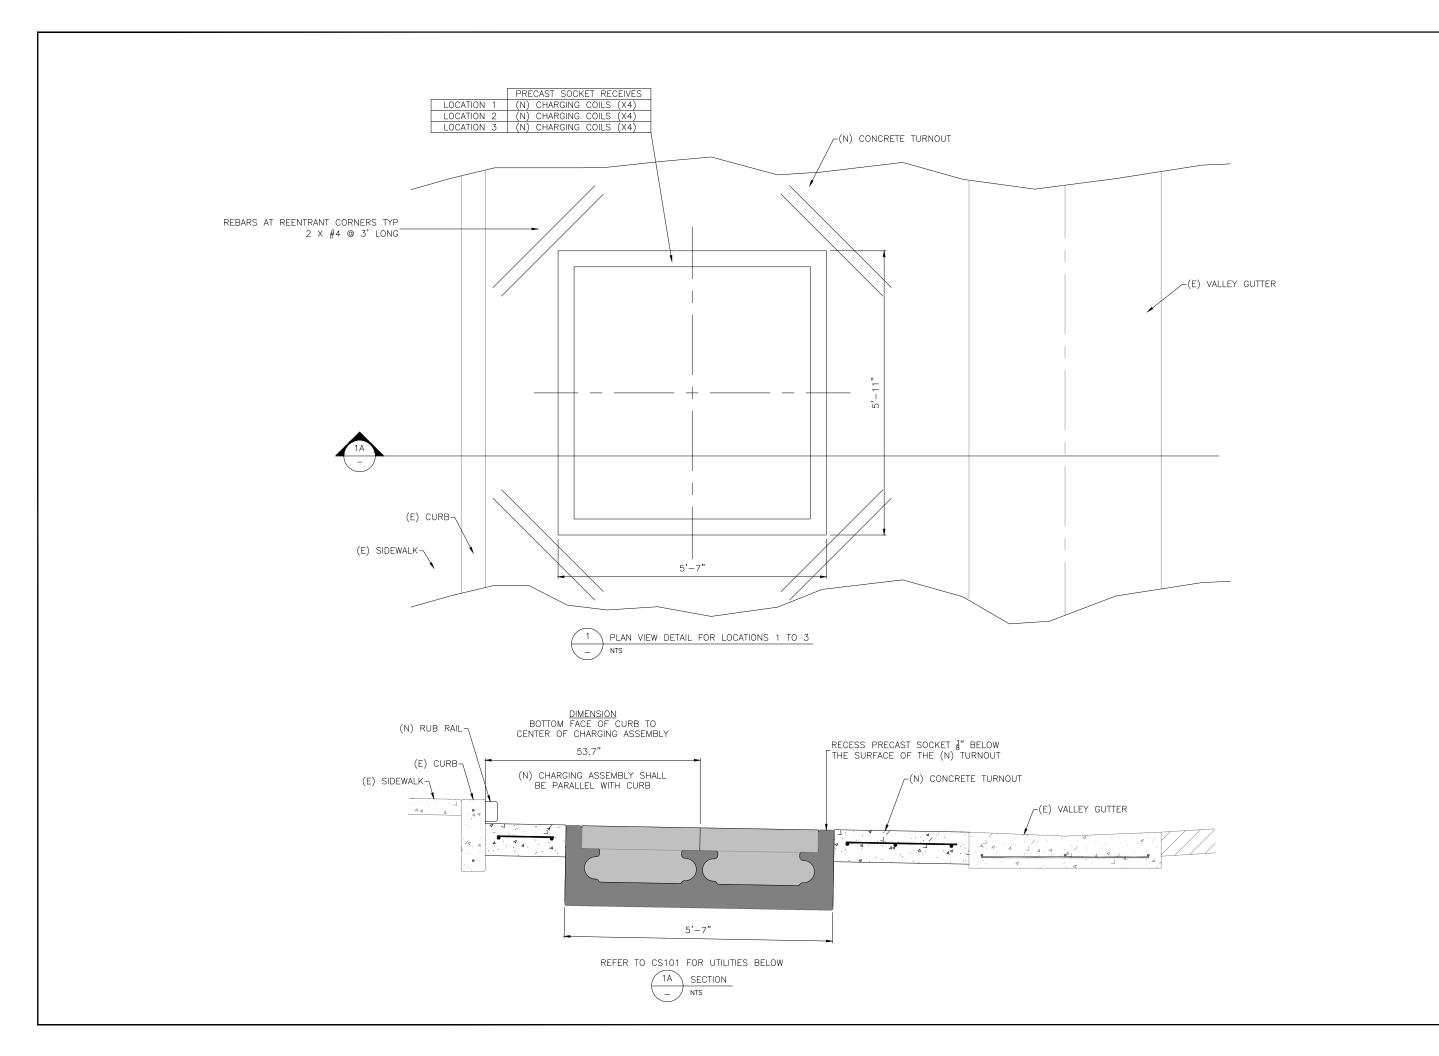
CIVIL ONLY


SECTOR OF CIVIL ONLY

CIVIL ONLY

SECTOR OF CIVIL ONLY

Designed:	RP SEW
Drawn:	RP
Checked:	SEW PP EL
Job No:	889830
Date: Dec	18, 2024
Scale f	Reference



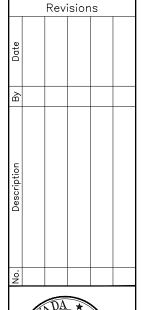



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Project Center Charging et Transit DETAILS Bus C Street


Electric Tinloy

Nevada

Designed:	RP SEW
Drawn:	RP
Checked:	SEW PP EL
Job No:	889830
Date: Dec	. 18, 2024
Scale F	Reference

Drawing

CZ510

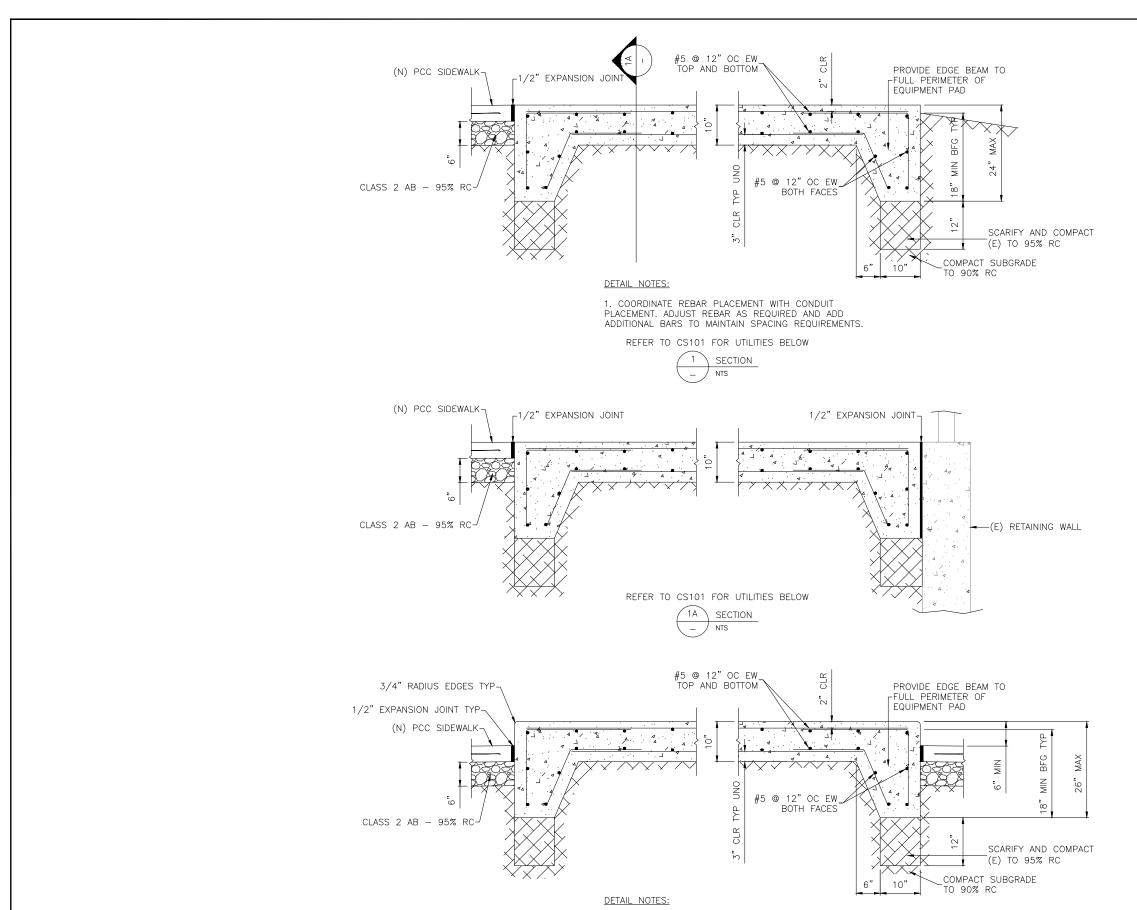

1. COORDINATE REBAR PLACEMENT WITH CONDUIT PLACEMENT. ADJUST REBAR AS REQUIRED AND ADD ADDITIONAL BARS TO MAINTAIN SPACING REQUIREMENTS.

REFER TO CS101 FOR UTILITIES BELOW



Project Center Charging t Transit Bus C Street Electric Tinloy

DETAILS

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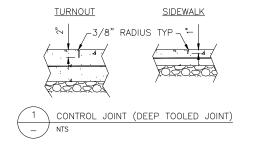
County


Revisions

Nevada

RP SEW Designed: RP Drawn: Checked: SEW PP EL Job No: 889830 Date: Dec. 18, 2024


Scale Reference




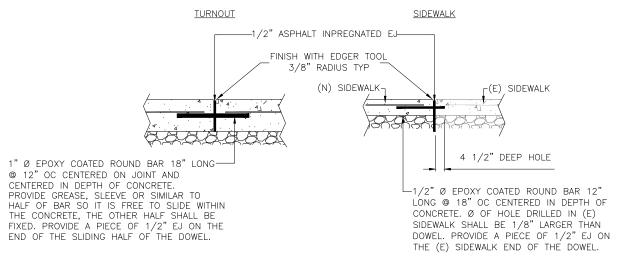



NOTE: PROVIDE 1" DEEP CONTROL JOINT PER DETAIL 1 ALONG CURB AT SIDEWALK JOINTS

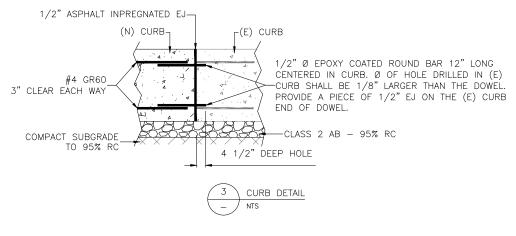

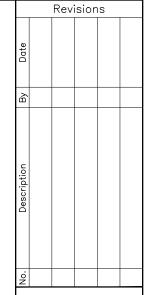



Project Center

Charging et Transit

Bus C Street

Electric Tinloy

DETAILS

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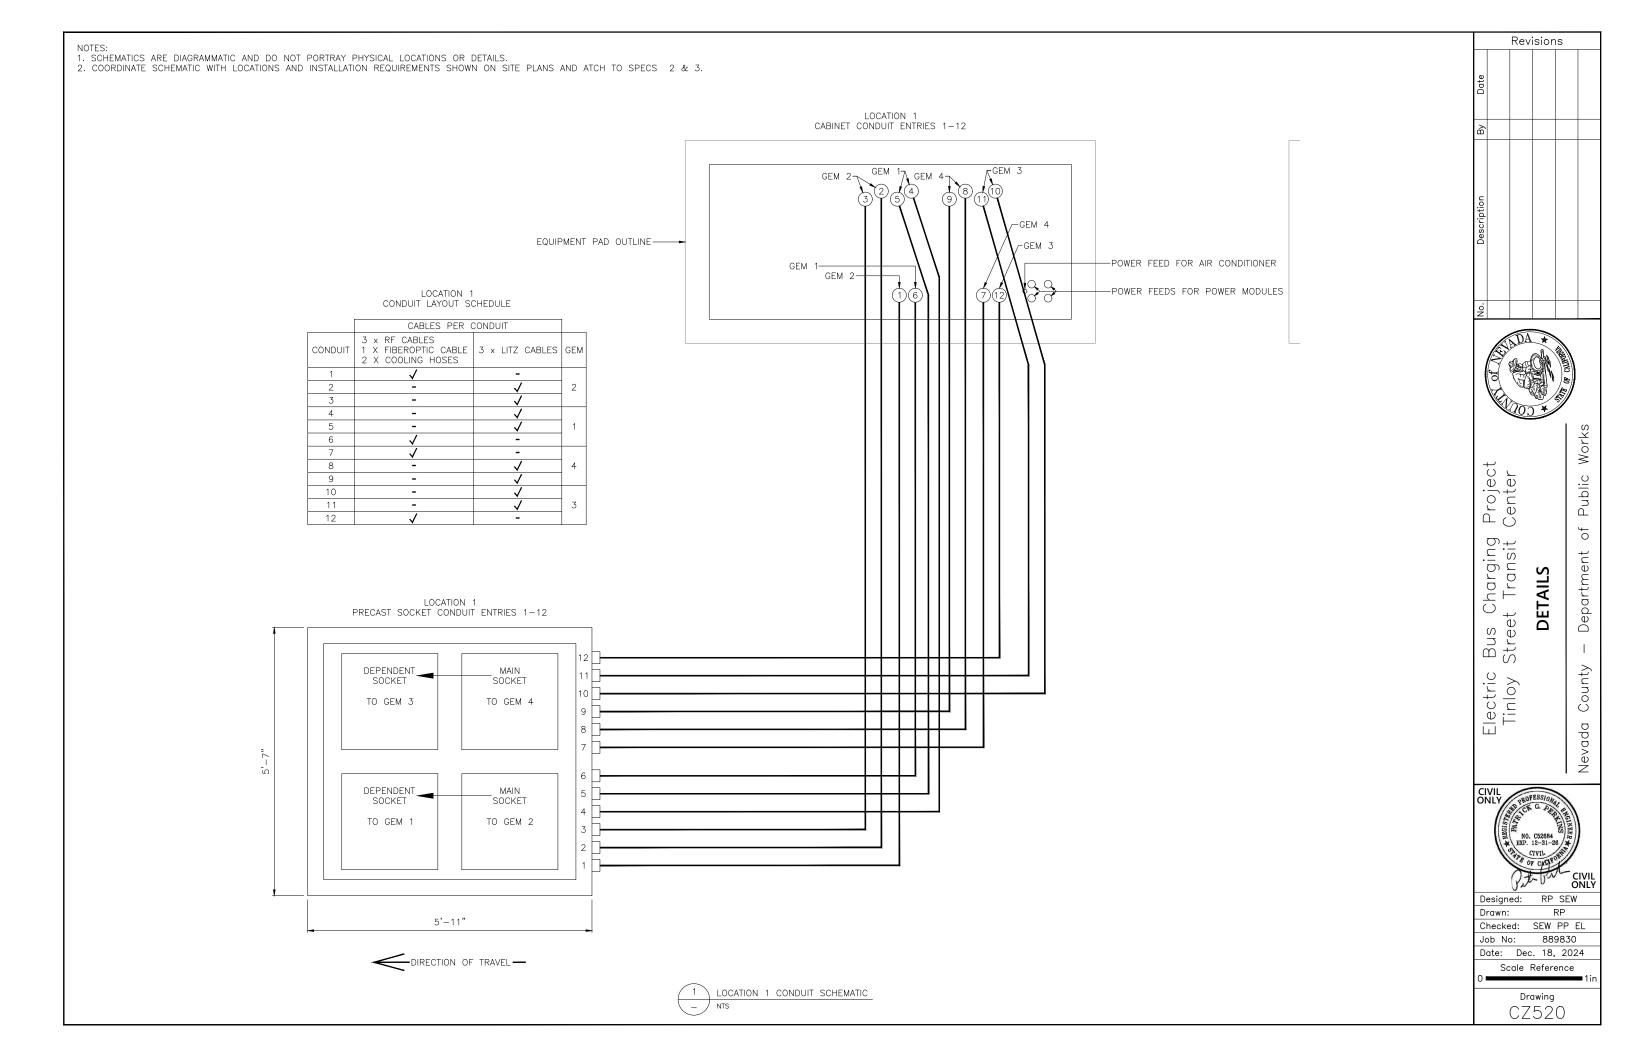
Department

County


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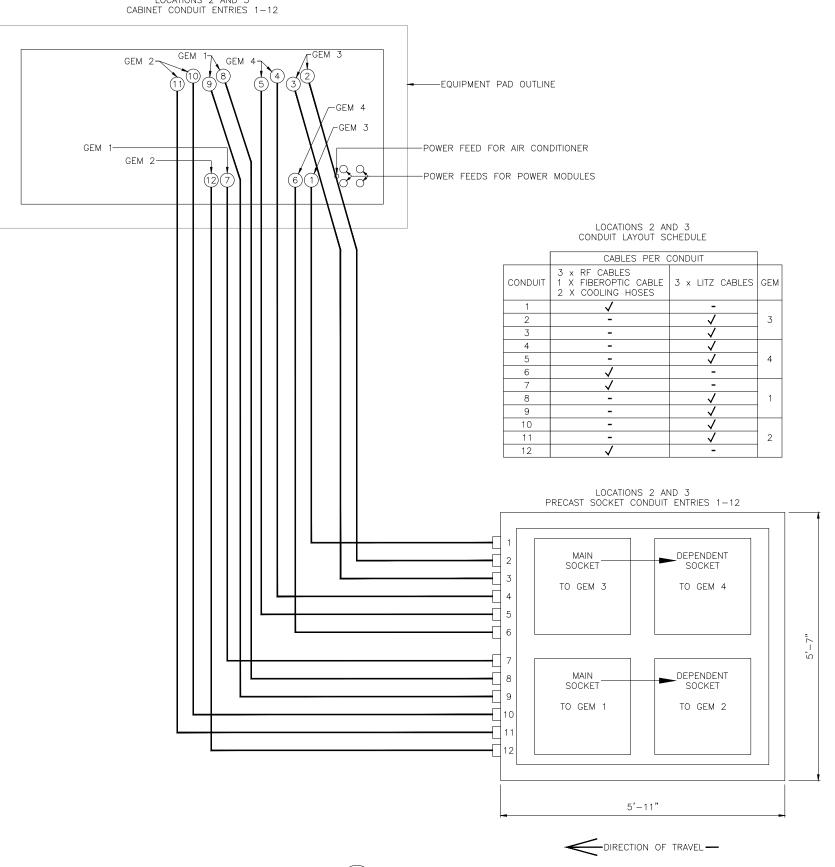
RP SEW Designed: Drawn: Checked: SEW PP EL Job No: 889830 Date: Dec. 18, 2024

Scale Reference



NOTES: 1. SCHEMATICS ARE DIAGRAMMATIC AND DO NOT PORTRAY PHYSICAL LOCATIONS OR DETAILS. 2. COORDINATE SCHEMATIC WITH LOCATIONS AND INSTALLATION REQUIREMENTS SHOWN ON SITE PLANS AND ATCH TO SPECS 2 & 3.



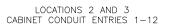

LOCATIONS 2 AND 3 CONDUIT SCHEME

NTS

Revisions



Project Center Charging et Transit **DETAILS** Bus C Street


Public

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County

Electric Tinloy




RP SEW Designed: Drawn: Checked: SEW PP EL Job No: 889830 Date: Dec. 18, 2024

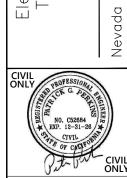Scale Reference

GRASS VALLEY - TINLOY STREET TRANSIT CENTER - EV BUS CHARGING STATION STATE RT 20/49 GRASS VALLEY, CA 95945

PROJECT DESCRIPTION	PROJECT TEAM	CODE INFORMATION	SHEET INDEX
PROJECT CONSISTS OF THE INSTALLATION A NEW UTILITY TRANSFORMER, A NEW 2000A, 277/480V, 30 SWITCHBOARD AND INFRASTRUCTURE FOR A NEW OFOI WIRELESS INDUCTION VEHICLE CHARGING STATION.	OWNER: NEVADA COUNTY CONNECTS + NEVADA COUNTY NOW CONTACT: ROBIN VAN VALKENBURGH ELECTRICAL: THE ENGINEERING ENTERPRISE CONTACT: OWEN QUAIL ELECTRICAL: THE ENGINEERING ENTERPRISE CONTACT: OWEN QUAIL ENTERPRISE CONTACT:	ALL WORK SHALL BE PERFORMED IN ACCORDANCE WITH THE APPLICABLE REGULATIONS, INCLUDING BUT NOT LIMITED TO THE FOLLOWING: STATE OF CALIFORNIA CODE OF REGULATIONS (CCR) 2019 TITLE 24 BUILDING CODE PART 3, CALIFORNIA BUILDING CODE (CPC) PART 3, CALIFORNIA ELECTRICAL CODE (CPC) PART 4, CALIFORNIA FIRE CODE (CFC) PART 5 CALIFORNIA FIRE CODE (CFC)	SHEET NO. SHEET NO. GO.1 COVER SHEET E.0.01 SYMBOLS, SHEET INDEX, SCHEDULES AND DETAILS E.1.01 SITE PLAN E.1.02 IENLARGED SITE PLANS E.2.01 DIAGRAMS
VICINITY MAP	SITE MAP		
Constitution of the second of			

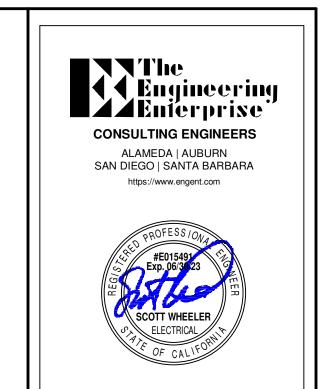

FINLOY STREET TRANSIT CENTER - EV CHARGING STATION

REVISIONS

DESCRIPTION

DESIGNER:TEE


SCALE: 1" = 100'-0"


DATE:11/13/2024
TITLE:

COVER SHEET

DRAWING NO.


G0.1

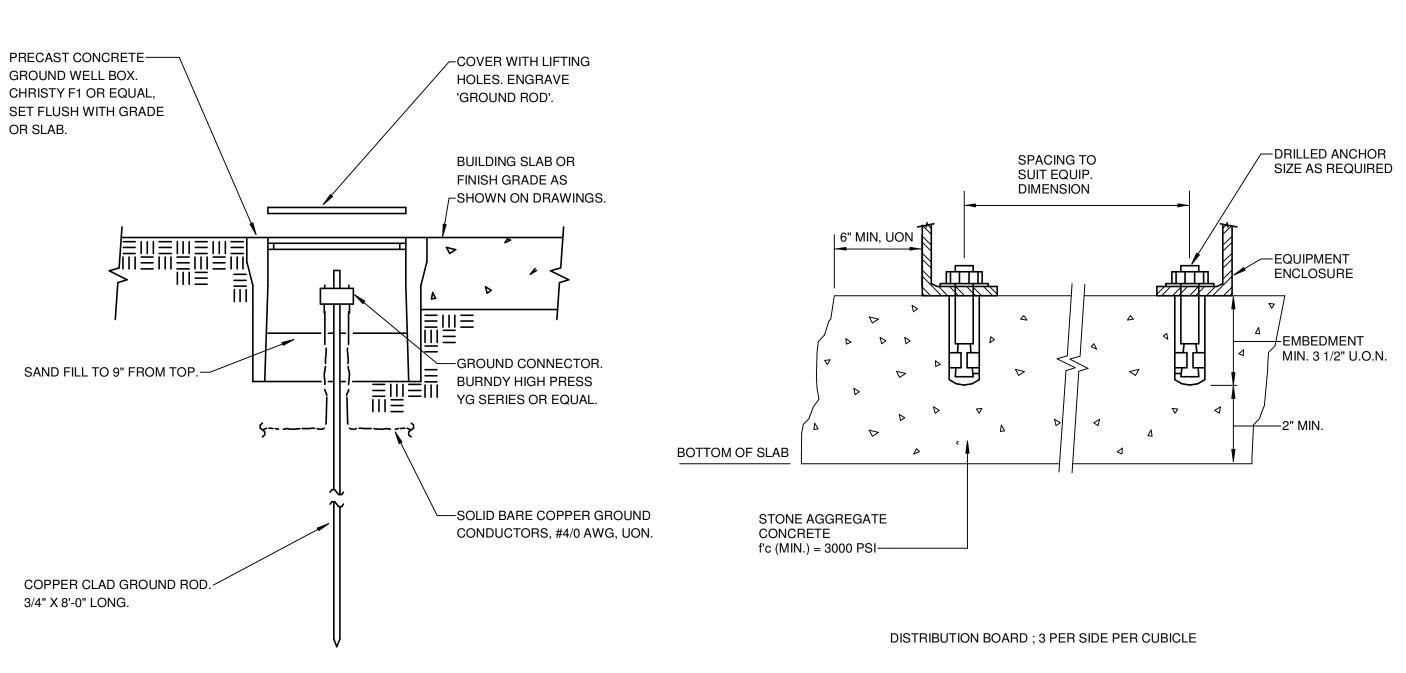


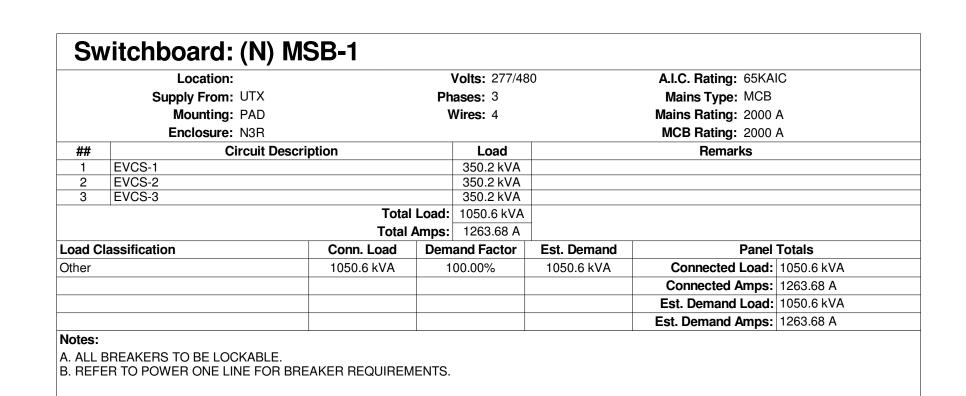

FEEDER SCHEDULE			
FEEDER SCHEDULE GENERAL NOTES			
1. COPPER FEEDER SIZES SHOWN IN THIS SCHEDULE ARE BASED ON CONDUCTORS WITH THHN/THWN-2 INSULATION IN EMT CONDUIT.			
2. ALUMINUM FEEDER SIZES SHOWN IN THIS SCHEDULE ARE BASED ON CONDUCTORS WITH XHHW-2 INSULATION IN EMT CONDUIT.			
3. FEEDER SIZES SHOWN IN THIS SCHEDULE ARE BASED ON AN AMBIENT TEMPERATURE OF 30 DEGREES C (86 DEGREES F).			
4. FEEDERS CONSISTING OF MULTIPLE SETS OF CONDUCTORS AND CONDUITS ARE TO BE PROVIDED WITH THE INDICATED SIZE GROU IN EACH CONDUIT.	ND CONDUCTOF	?	
5. PER CEC ARTICLE 110.14, ALL FEEDERS SIZED AT #2 AWG OR LESS ARE CALCULATED PER 60 DEGREE TABLE. FEEDERS GREATER THAN #2 AWG			
ARE RATED 75 DEGREE.			
FEEDER SCHEDULE REMARKS			
A. OVERSIZED 150% NEUTRAL, SUITABLE FOR SERVICE FROM K-13 RATED TRANSFORMERS.			
B. FEEDER APPROVED FOR USE WITH SEPARATELY DERIVED SYSTEM; GROUNDING AS REQUIRED BY CEC ARTICLES 240 AND 250.			
C. FEEDER GROUND AND BONDING JUMPER SHALL HAVE AN AREA NOT LESS THAN 12.5% OF THE AREA OF THE LARGEST PHASE CONDUCTOR.			
D. INCREASE CONDUIT TO THE NEXT LARGER TRADE SIZE WHEN USING SCHEDULE 40 OR 80 PVC CONDUIT.			
E. PER CEC SECTION 240.4(B), FOR OVERCURRENT DEVICES RATED 800A OR LESS, THE NEXT HIGHER STANDARD OVERCURRENT DEVICE RATING (ABOVE THE			
AMPACITY OF THE CONDUCTORS) CAN BE USED. RULE CAN NOT BE APPLIED IF 100% RATED BREAKERS ARE USED.			
F. PER CEC 240.21(C), THE PROVISIONS OF 240.4(B) SHALL NOT BE PERMITTED FOR TRANSFORMER SECONDARY CONDUCTORS.			
SEPARATEL'	Y DERIVED		
FEEDER FEEDER CONDUCTORS SYST	STEM		
TAG DESCRIPTION CONDUIT GROUNDING	BONDING	REMARKS	
PHASE/NEUTRAL GROUND GROUND ELECTRODE			
	JOIVII LIT		
302 30 AMP, 2 WIRE 1-0.75" 2 #10 CU 1 #10 CU -	-	-	
1253 130 AMP, 3 WIRE 1-1.50" 3 #1 CU 1 #6 CU -	-	-	


	NUMBERED SHEET NOTES
1	PRIMARY CONDUIT AND WIRE BY PG&E.
2	TRANSFORMER PAD AND TRANSFORMER BY PG&E.
3	SECONDARY CONDUIT AND WIRE BY PG&E.
	SPACE PROVISIONS FOR FOUR 125A/3Ø AND ONE 20A/1Ø CIRCUIT BREAKERS FOR FUTURE EVCS.

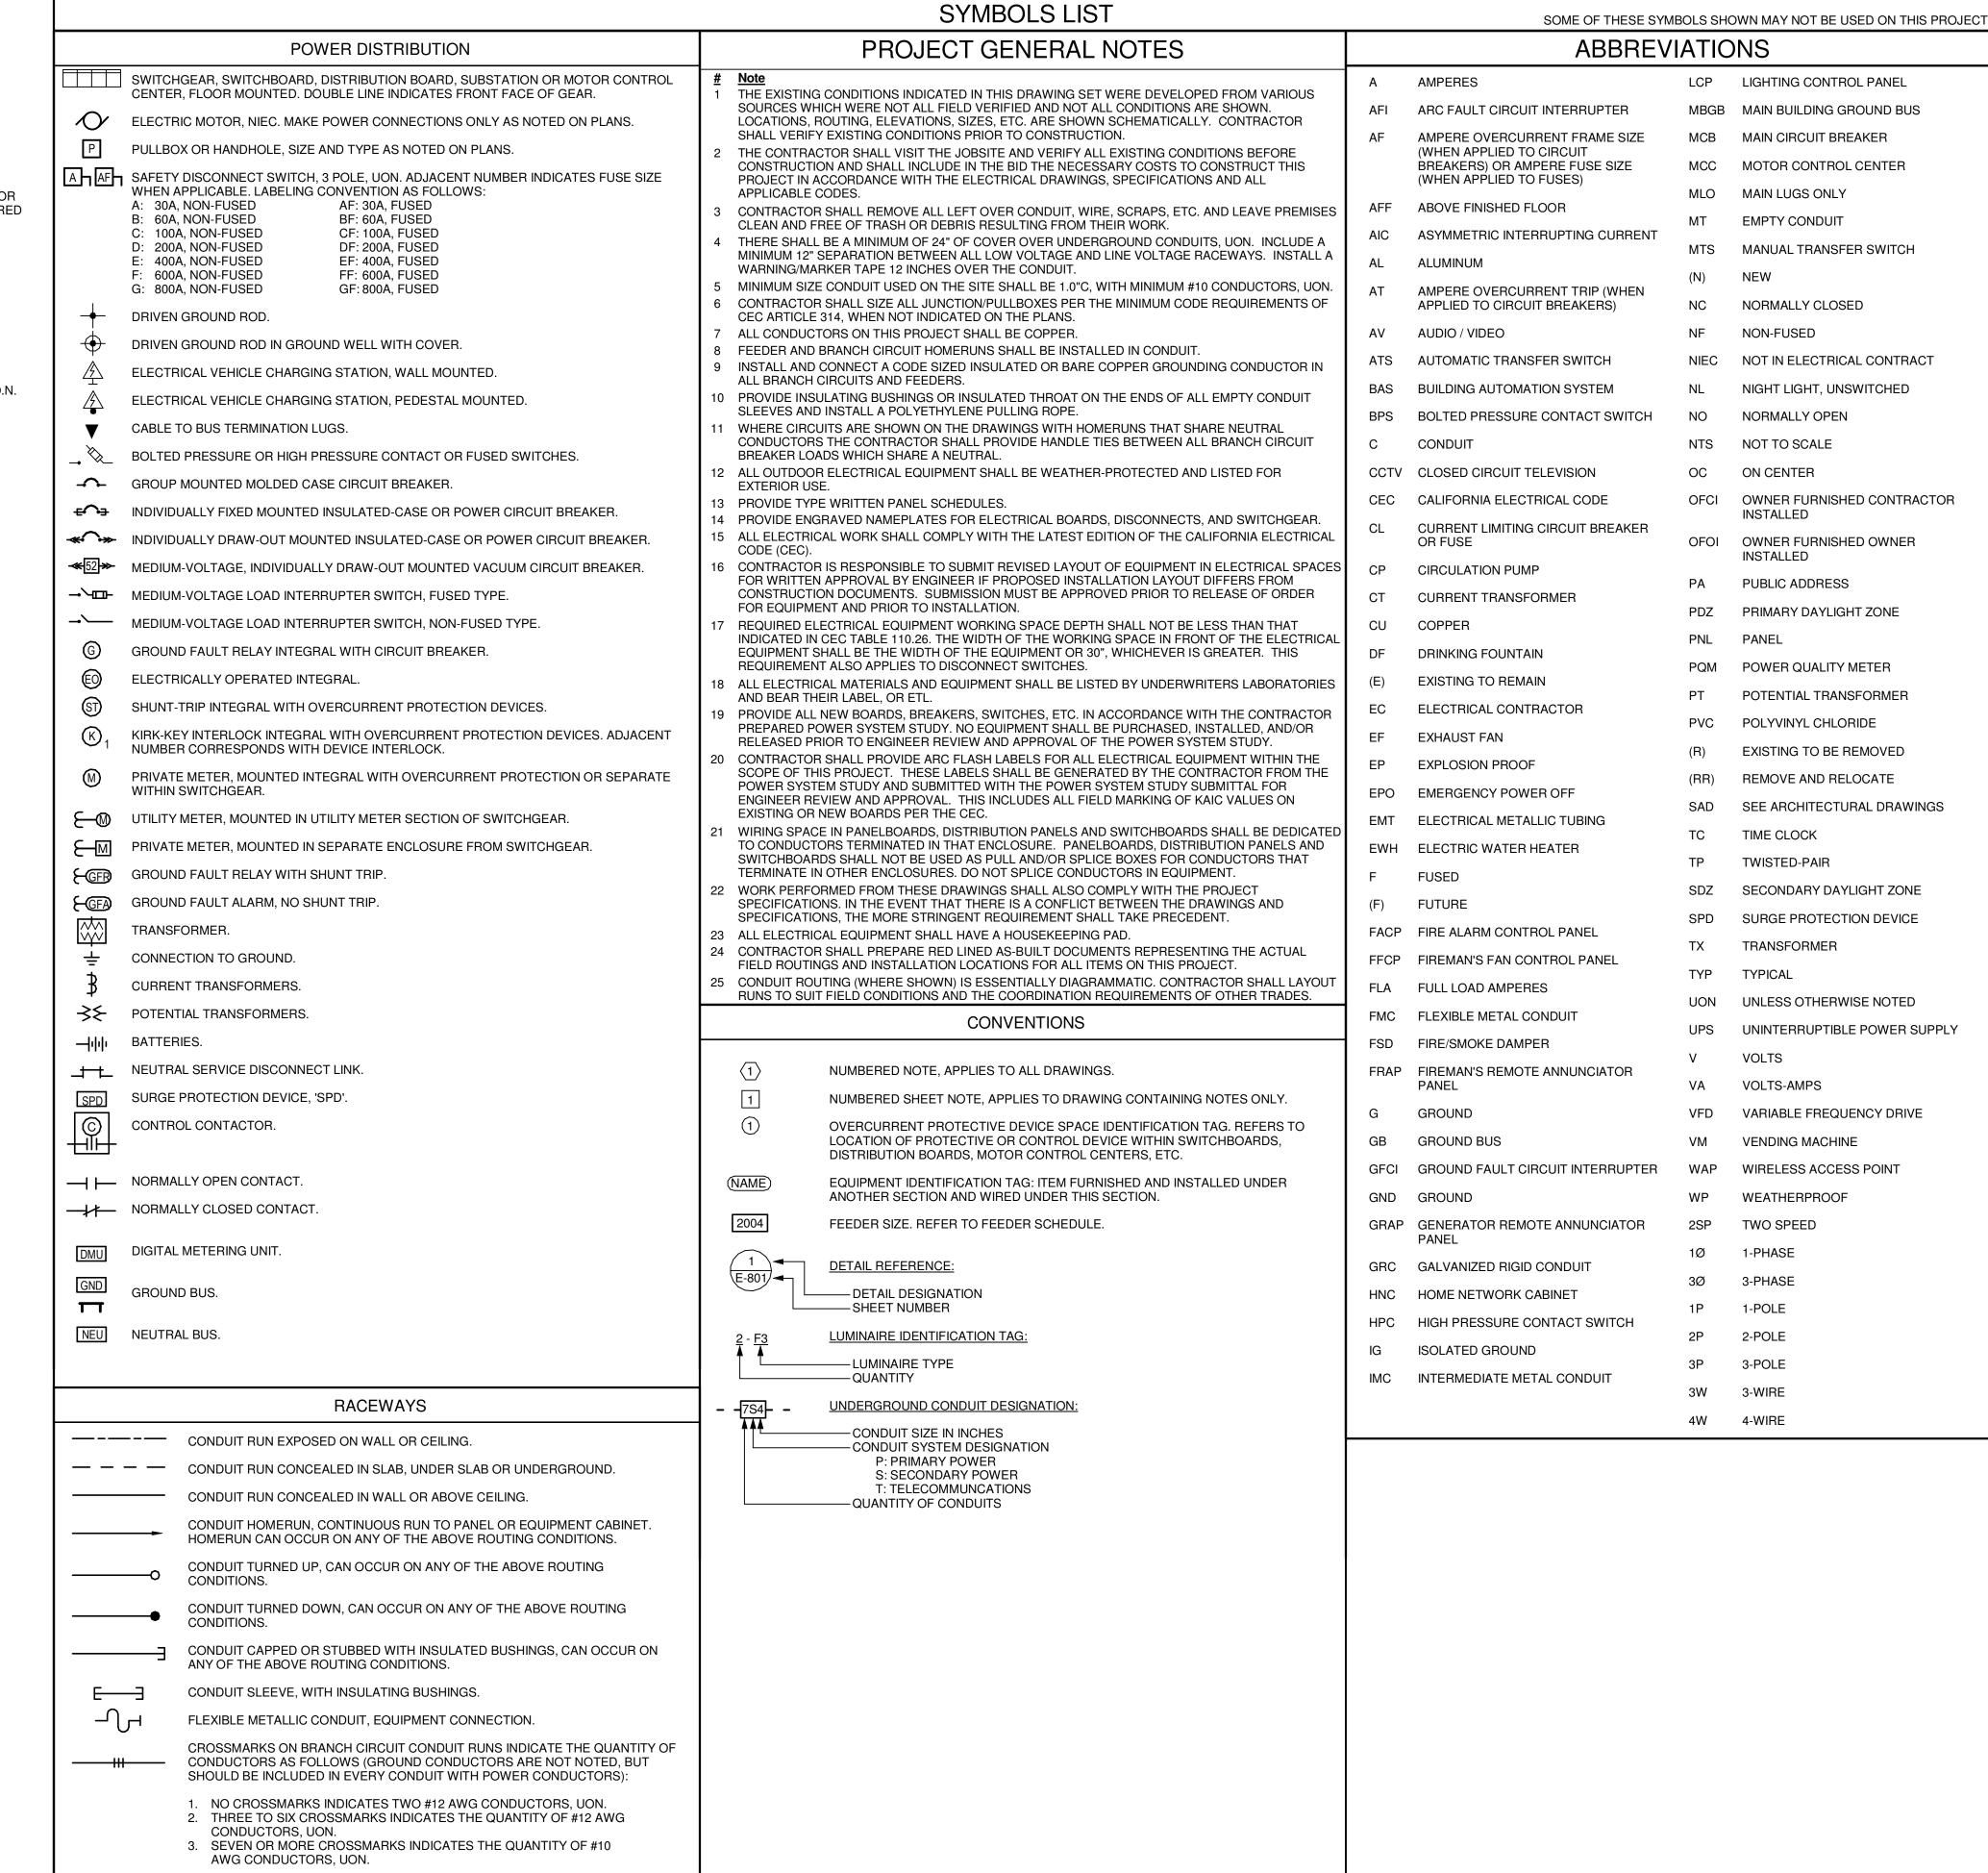

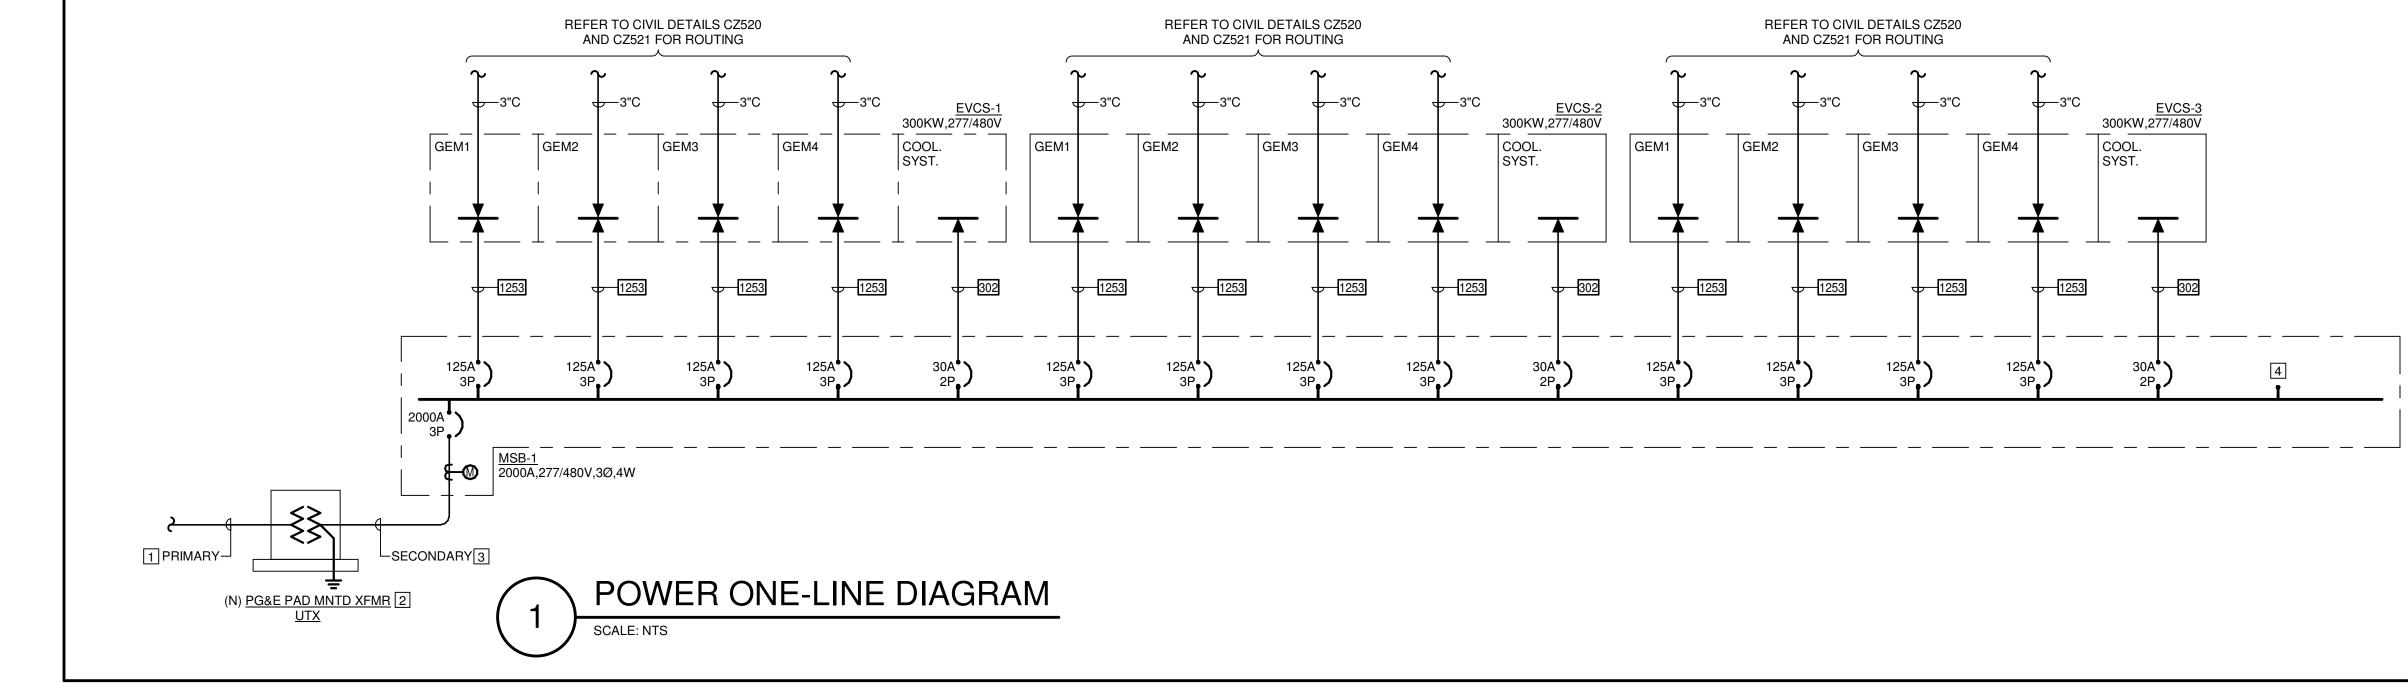

EQUIPMENT ANCHORING

◀ ◀ Engineering **LÀÀ E**nierprise ' CONSULTING ENGINEERS ALAMEDA | AUBURN SAN DIEGO | SANTA BARBARA https://www.engent.com

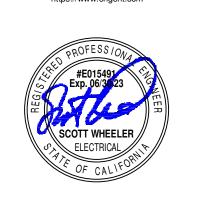

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ATE RT :

REVISIONS # DESCRIPTION


DESIGNER:TEE SCALE: NTS

DATE:11/13/2024

SYMBOLS, SHEET INDEX, SCHEDULES AND **DETAILS**

DRAWING NO.

E0.01

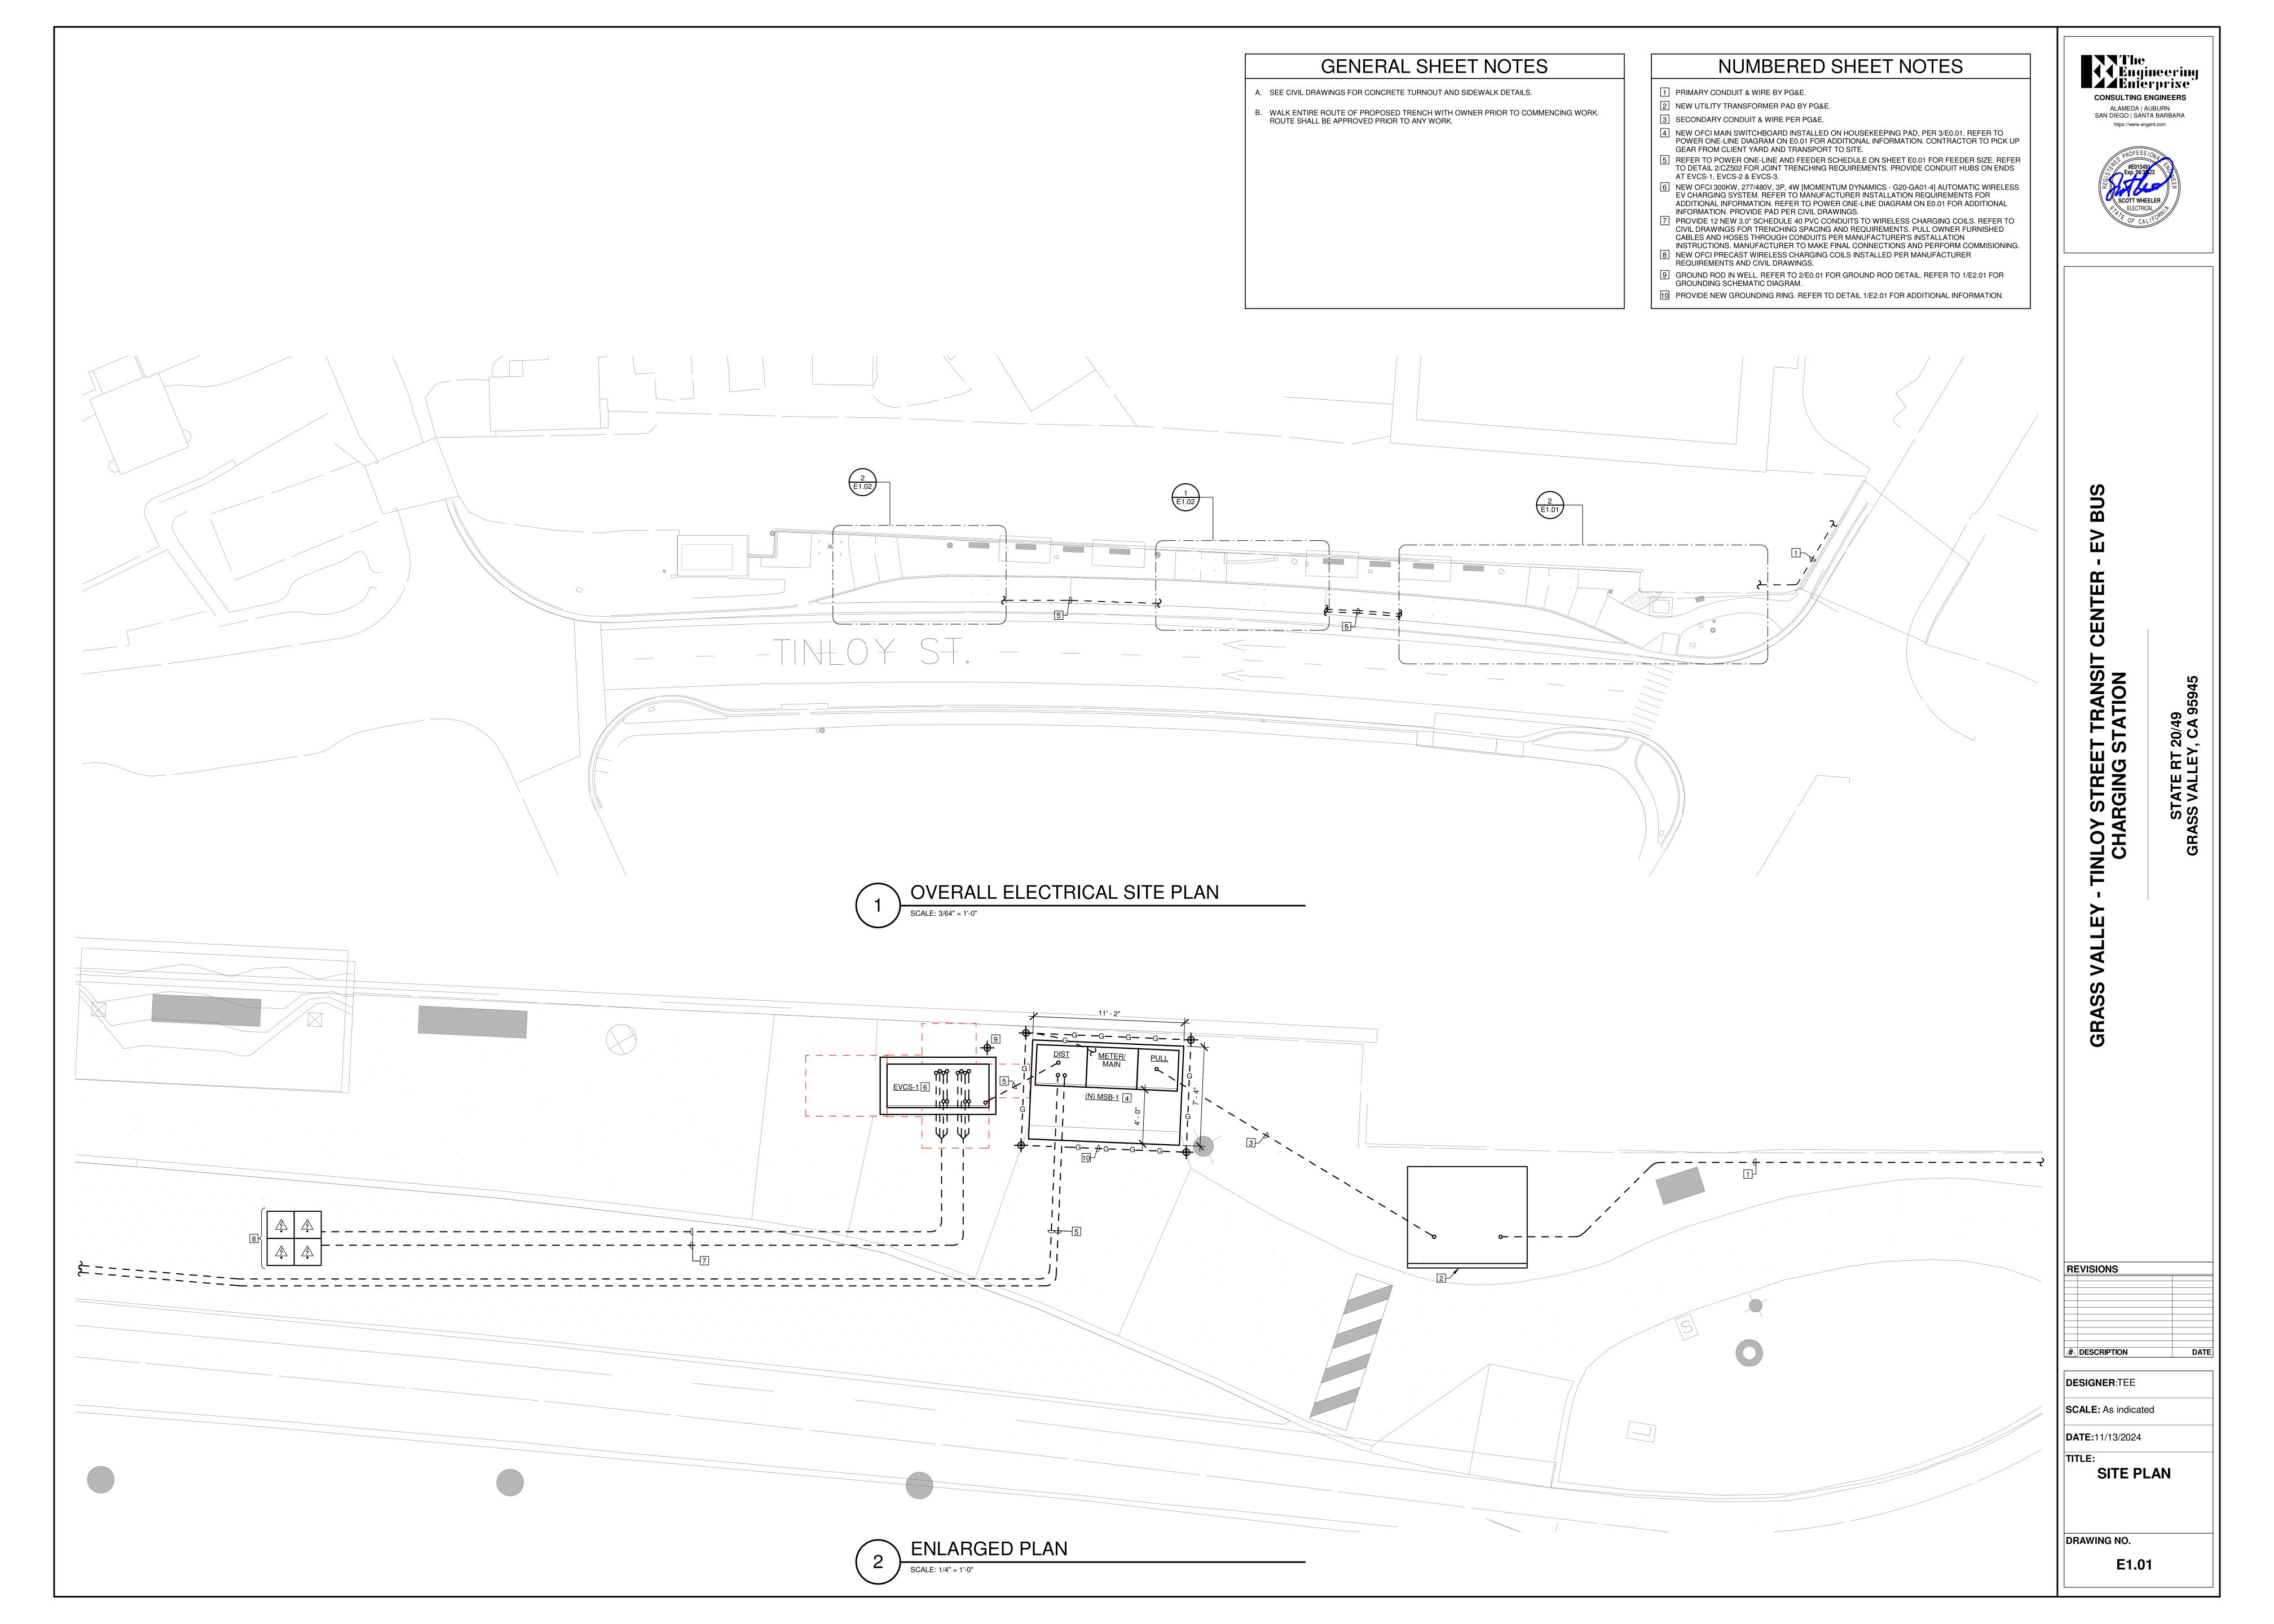

GENERAL SHEET NOTES

- A. SEE CIVIL DRAWINGS FOR CONCRETE TURNOUT AND SIDEWALK DETAILS.
- B. WALK ENTIRE ROUTE OF PROPOSED TRENCH WITH OWNER PRIOR TO COMMENCING WORK. ROUTE SHALL BE APPROVED PRIOR TO ANY WORK.


NUMBERED SHEET NOTES


- 1 REFER TO POWER ONE-LINE AND FEEDER SCHEDULE ON SHEET E0.01 FOR FEEDER SIZE. REFER TO DETAIL 2/CZ502 FOR JOINT TRENCHING REQUIREMENTS. PROVIDE CONDUIT HUBS ON ENDS
- AT EVCS-1, EVCS-2 & EVCS-3.


 2 NEW OFCI PRECAST WIRELESS CHARGING COILS INSTALLED PER MANUFACTURER REQUIREMENTS AND CIVIL DRAWINGS.
- PROVIDE 12 NEW 3.0" SCHEDULE 40 PVC CONDUITS TO WIRELESS CHARGING COILS. REFER TO CIVIL DRAWINGS FOR TRENCHING SPACING AND REQUIREMENTS. PULL OWNER FURNISHED CABLES AND HOSES THROUGH CONDUITS PER MANUFACTURER'S INSTALLATION INSTRUCTIONS. MANUFACTURER TO MAKE FINAL CONNECTIONS AND PERFORM COMMISIONING.

 1 NEW VAULT AND LID. REFER TO CIVIL DRAWING CP101 FOR ADDITIONAL INFORMATION.
- GROUND ROD IN WELL. REFER TO 2/E0.01 FOR GROUND ROD DETAIL. REFER TO 4/E0.01 FOR GROUNDING TO EQUIPMENT PAD. REFER TO 1/E2.01 FOR GROUNDING SCHEMATIC DIAGRAM.

 NEW OFCI 300KW, 277/480V, 3P, 4W [MOMENTUM DYNAMICS G20-GA01-4] AUTOMATIC WIRELESS EV CHARGING SYSTEM. REFER TO MANUFACTURER INSTALLATION REQUIREMENTS FOR ADDITIONAL INFORMATION. REFER TO POWER ONE-LINE DIAGRAM ON E0.01 FOR ADDITIONAL INFORMATION. PROVIDE PAD PER CIVIL DRAWINGS.

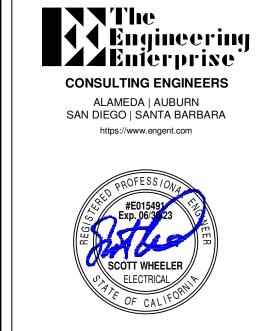

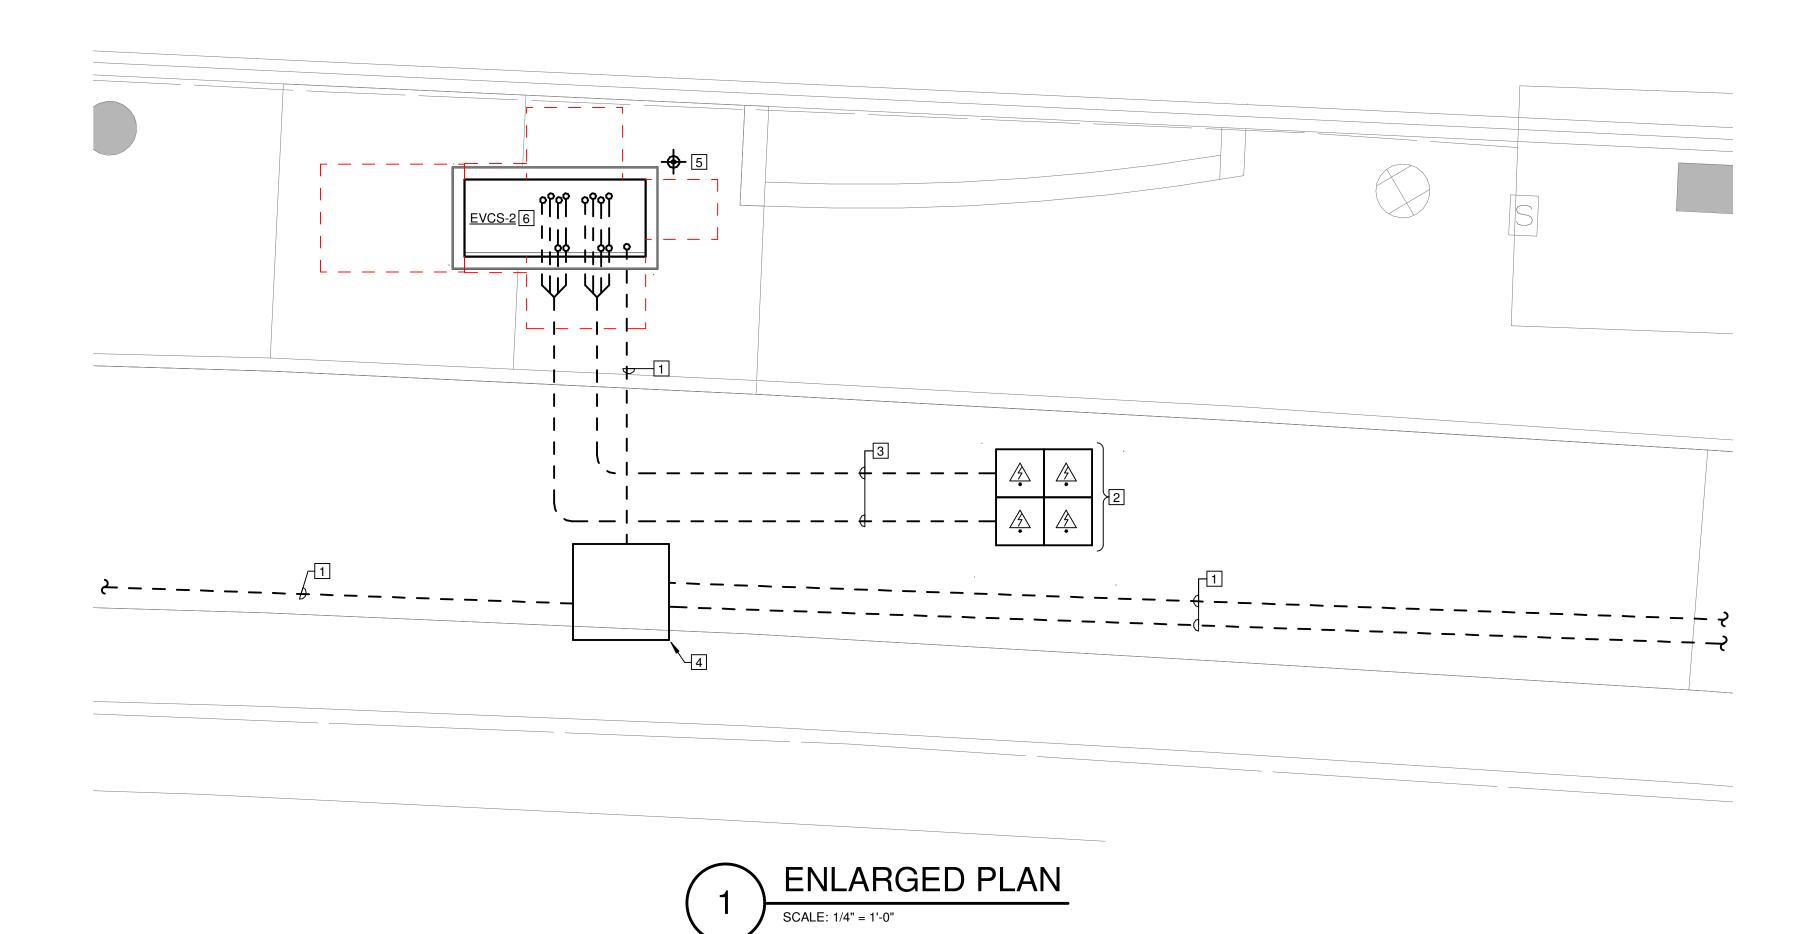

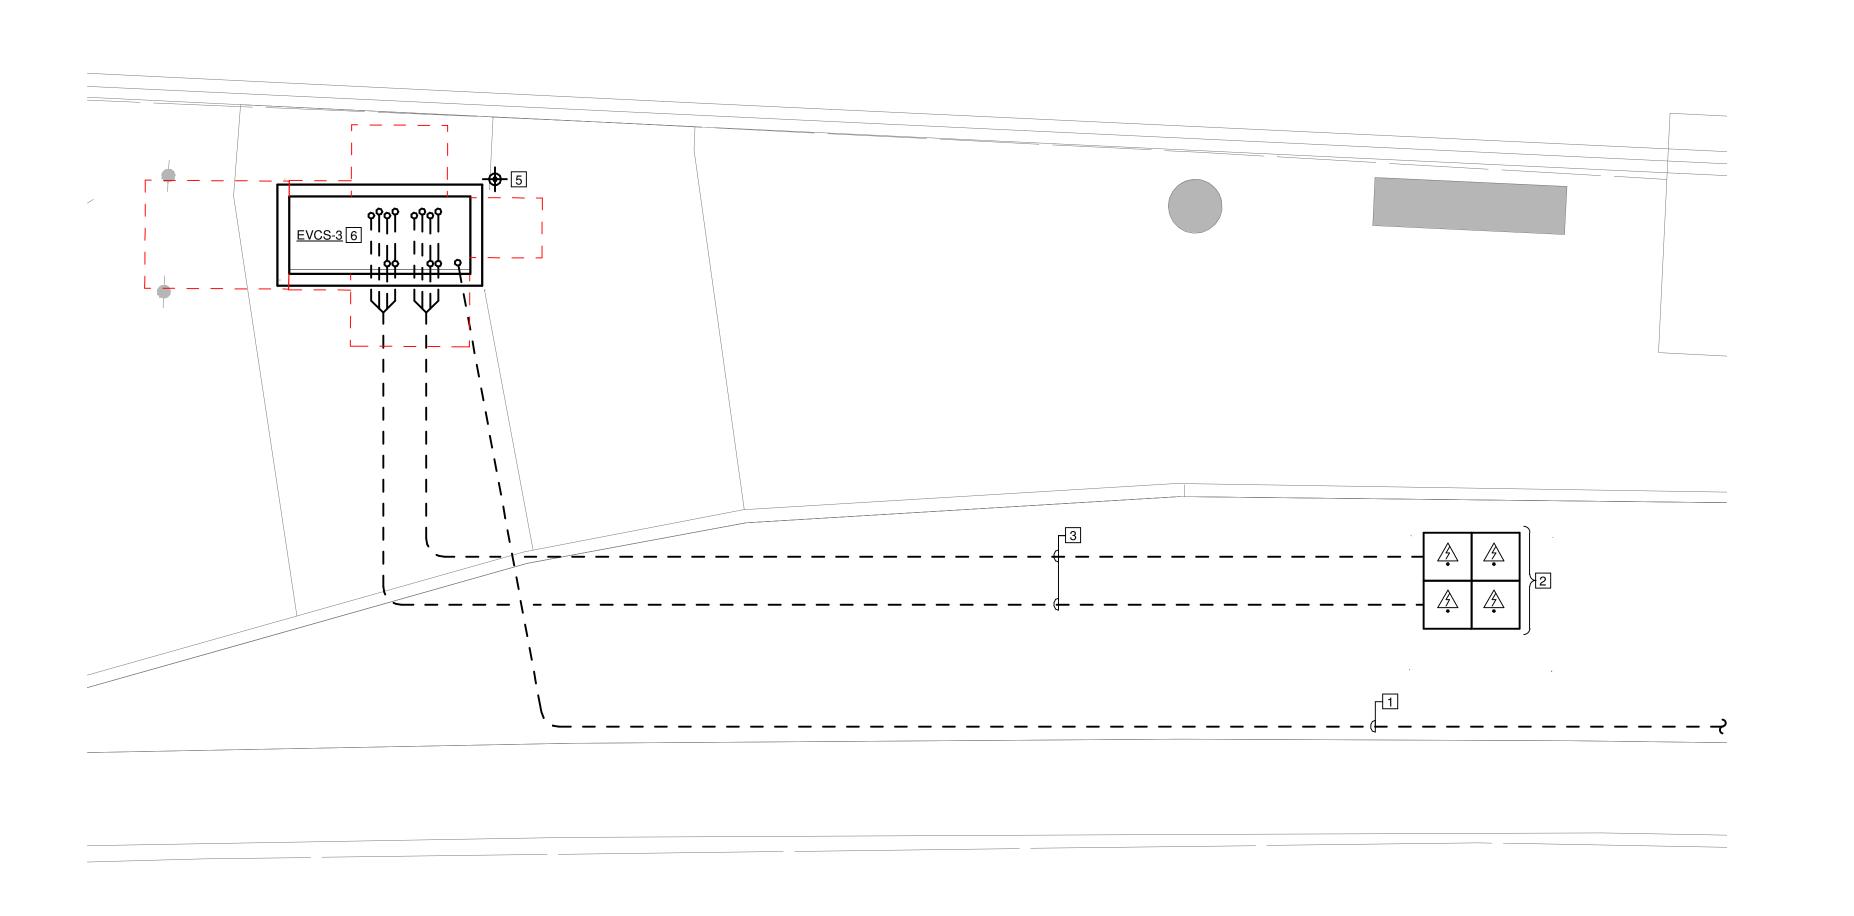



- TINLOY STREET TRANSIT CENTER -CHARGING STATION

REVISION

DESIGNER:Designer


SCALE: 1/4" = 1'-0"

DATE:11/13/2024

ENLARGED SITE
PLANS

DRAWING NO.

E1.02

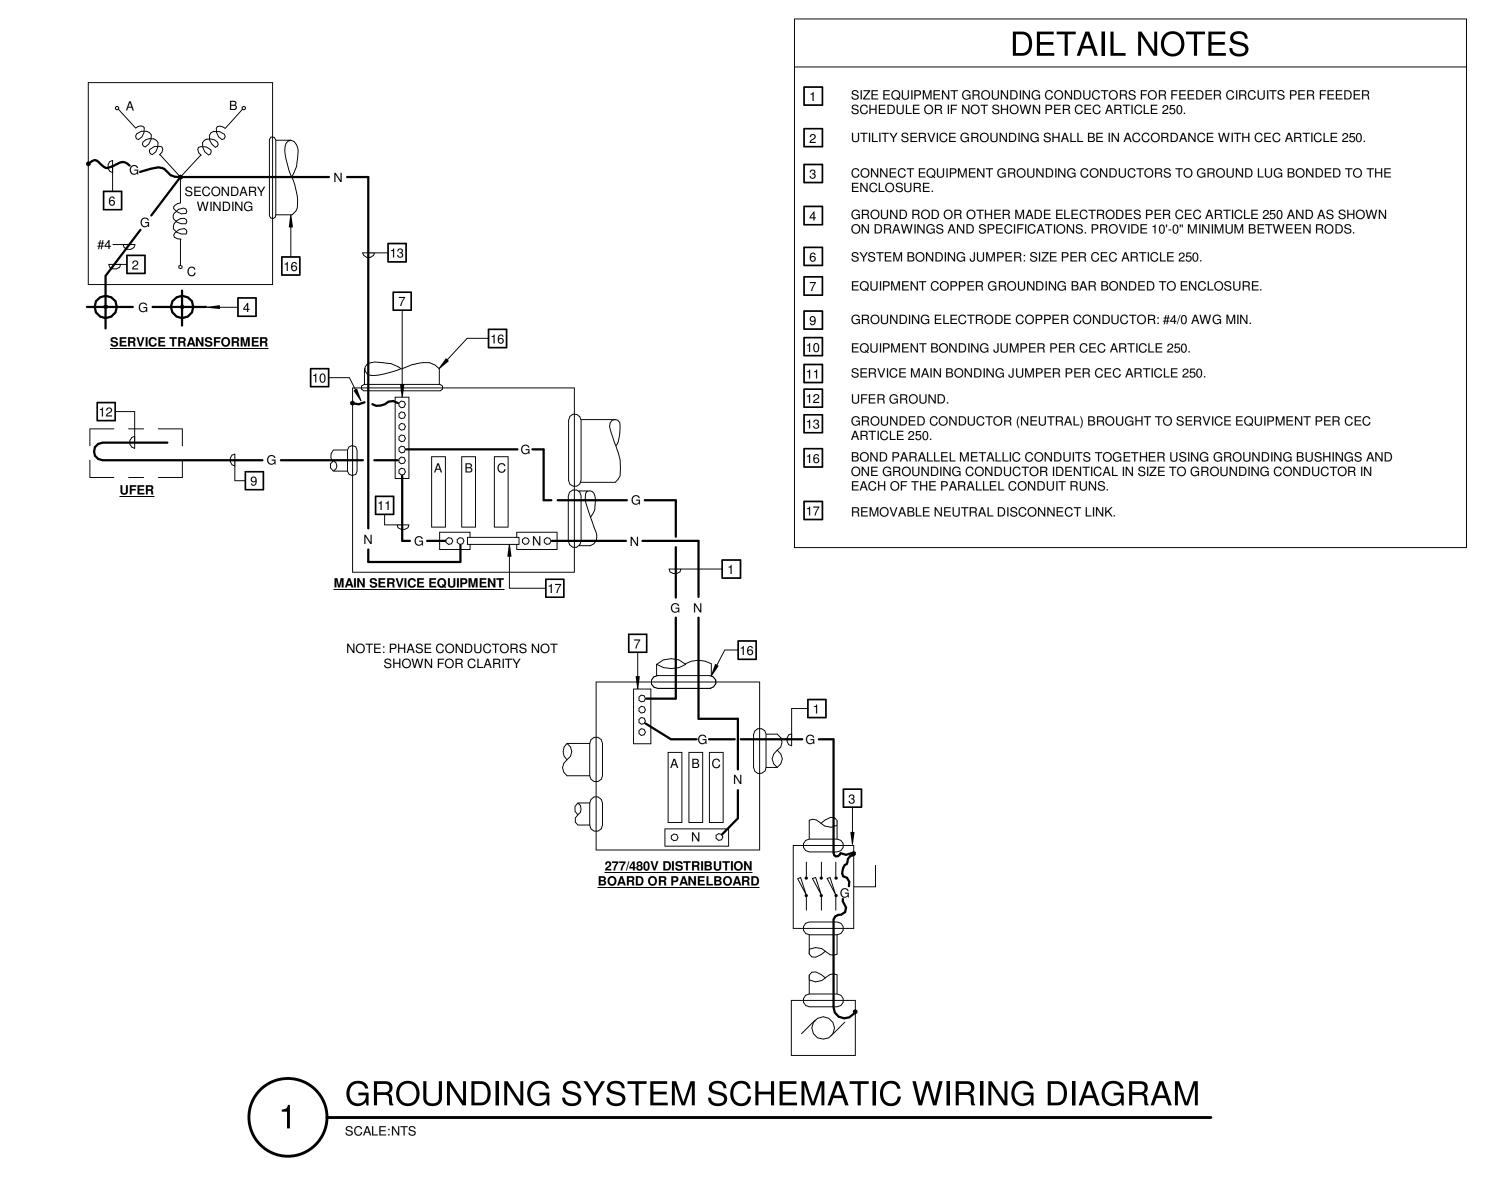

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C TINLOY STREET TRANS CHARGING STATION

STATE RT 20/49 GRASS VALLEY, CA 95945

DESIGNER:Designer

SCALE: NTS

DATE:11/13/2024

DIAGRAMS

DRAWING NO.

E2.01