



PROBATION DEPARTMENT



PUBLIC DEFENDER'S OFFICE


PUBLIC DEFENDER OFFICE & PROBATION DEPARTMENT

SITE MAP




SHEET INDEX

Table listing sheet numbers and titles under categories: General, Architectural, Structural, and Electrical.

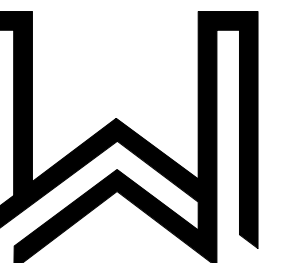

WALLIS DESIGN STUDIO ARCHITECTURE
149 Crown Point Ct., Suite C
Grass Valley, CA 95945
(530) 264-7010
WallisDesignStudio.com

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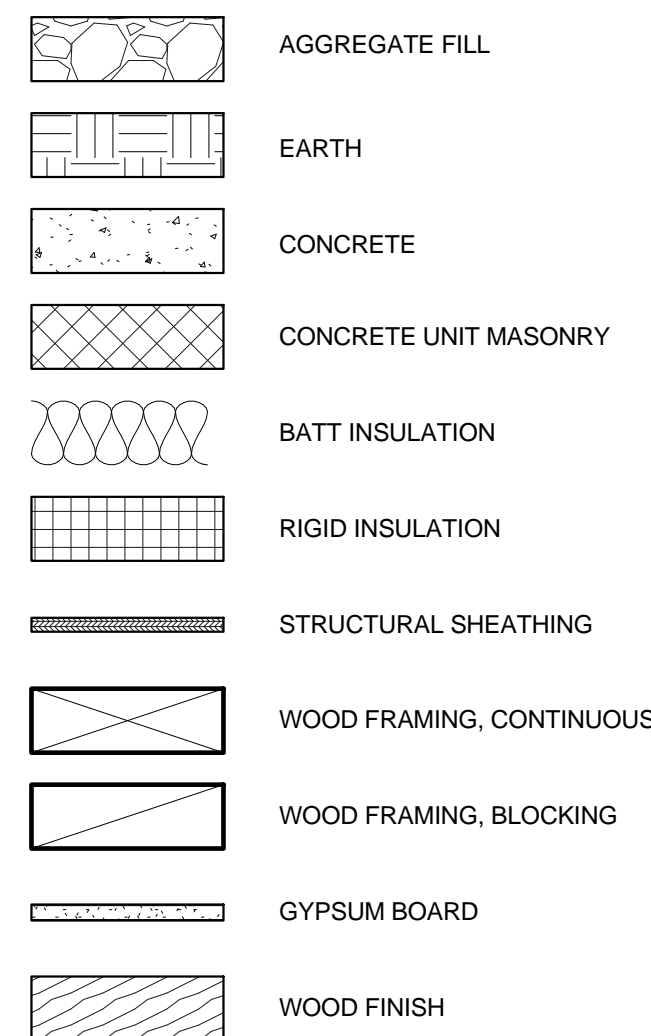


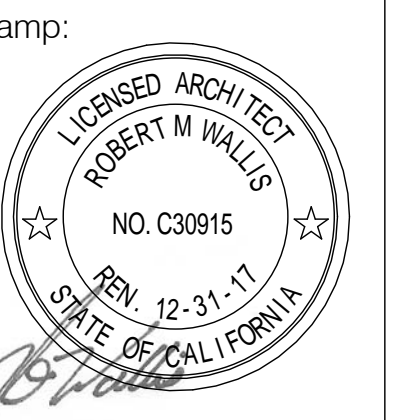Consultant:


CONSTRUCTION DOCUMENTS

Nevada County Facilities Department
NEVADA COUNTY PROBATION DEPARTMENT & PUBLIC DEFENDER
109 1/2 Pine Street
Nevada City, CA 95959
APN: 05-570-04

LEGEND



SYMBOLS

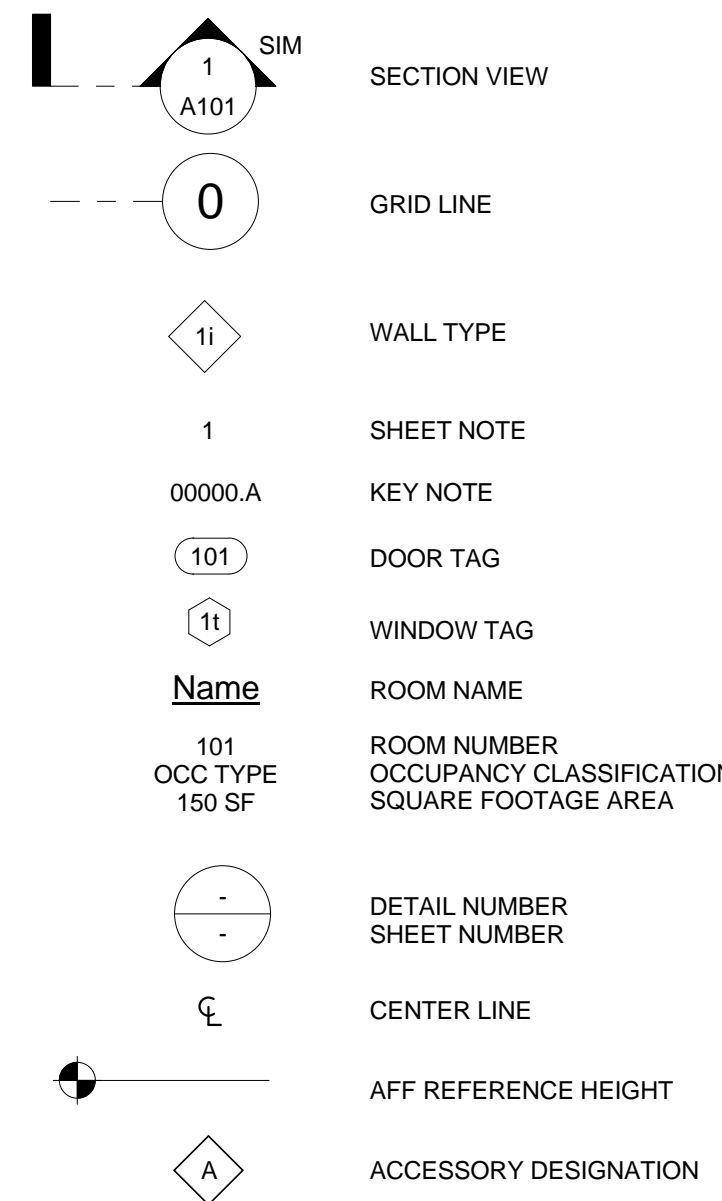


PROJECT INFORMATION

LOCATION: NEVADA COUNTY PROBATION DEPARTMENT
109 1/2 PINE STREET
NEVADA CITY, CA 95959
GENERAL SCOPE OF WORK: OFFICE TENANT IMPROVEMENT TO AN (E) OFFICE SPACE ON THE 2ND & 3RD FLOORS...
EXISTING BUILDING INFORMATION: TYPE V-B, 45'
EXISTING BUILDING FLOOR AREA: OFFICE AREA: 2ND FLOOR: 8,925 SF, 3RD FLOOR: 6,756 SF, TOTAL: 15,681 SF
TENANT IMPROVEMENT: 2ND & 3RD FLOORS (B OCCUPANCY): 3,600 SF
BUILDING CONSTRUCTION DESCRIPTION: THE EXISTING BUILDING STRUCTURAL SYSTEM CONSISTS OF DRILLED REINFORCED CONCRETE PIERS TO BEDROCK...

PROJECT TEAM

OWNER: NEVADA COUNTY FACILITIES DEPARTMENT
10014 NORTH BLOOMFIELD ROAD
NEVADA CITY, CA 95959
ARCHITECT: WALLIS DESIGN STUDIO
149 CROWN POINT COURT
NEVADA CITY, CA 95959
STRUCTURAL ENGINEER: DEL VALLE CONSULTING
11768 TAMMY WAY
GRASS VALLEY, CA 95949

PROJECT VICINITY MAP

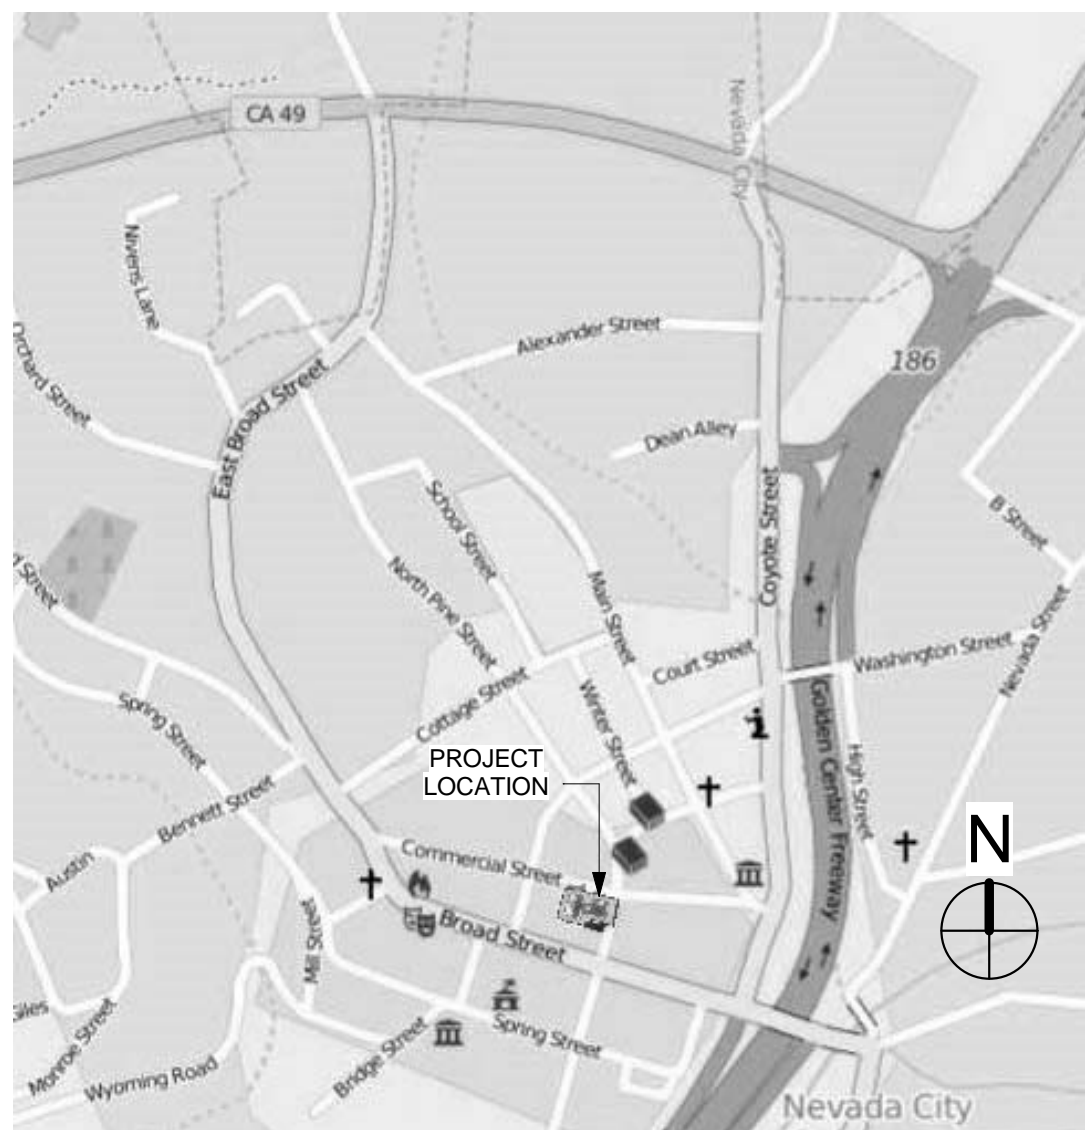

CODES AND STANDARDS

ALL WORK SHALL COMPLY WITH THE 2013 CALIFORNIA CODE OF REGULATIONS, TITLE-24, CALIFORNIA BUILDING STANDARDS COMMISSION (CBCS) - PARTS 1 THRU PART 12
PART 1 - CALIFORNIA ADMINISTRATIVE CODE
PART 2 - CALIFORNIA BUILDING CODE (CBC)
PART 2.5 - CALIFORNIA RESIDENTIAL CODE (CRC)
PART 3 - CALIFORNIA ELECTRICAL CODE (CEC)
PART 4 - CALIFORNIA MECHANICAL CODE (CMC)
PART 5 - CALIFORNIA PLUMBING CODE (CPC)
PART 6 - CALIFORNIA ENERGY CODE
PART 7 - CALIFORNIA ELEVATOR SAFETY CONSTRUCTION CODE
PART 8 - CALIFORNIA HISTORICAL BUILDING CODE
PART 9 - CALIFORNIA FIRE CODE
PART 10 - CALIFORNIA CODE FOR BUILDING CONSERVATION
PART 11 - CALIFORNIA GREEN BUILDING STANDARDS CODE
PART 12 - CALIFORNIA REFERENCED STANDARDS CODE (CALGreen)

AGENCIES & UTILITIES

CITY OF NEVADA CITY
317 Broad Street, Nevada City, California 95959
Fire Department: Sam Goodspeed, Fire Chief
Parks & Recreation: Dawn Zydonis, Parks & Recreation Supervisor
Planning Department: Amy Wolfson, City Planner
Police Department: Tim Foley, Police Chief
Public Works Department: Verne Taylor, Director of Public Works


ABBREVIATION

Table of abbreviations and their full names, including ACST, AC, ACC, ADJ, AFF, ALT, ALUM, APPROX, BOARD, BITUM, BLDG, BM, BO, CAB, CJ, CLG, CLR, CMU, COL, CONC, CPT, CSM, CT, DEMO, DIA, DIM, DN, DS, DW, DWIR, E, EA, EJC, ELEV, EQ, EQUIP, EXIST, EXP, EXT, etc.

Table with columns for Date, Description, and No.

Proj. No.: 2016015
Date: 08/03/2016
Scale: As indicated
Drawn By: JMT

A0.0
COVER SHEET

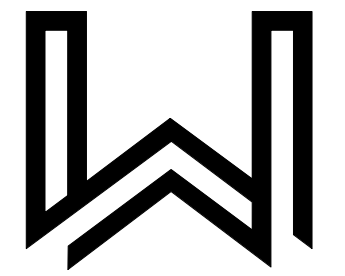


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CONSTRUCTION DOCUMENTS

Nevada County/Facilities Department
NEVADA COUNTY PROBATION DEPARTMENT & PUBLIC DEFENDER
109 1/2 Pine Street
Nevada City, CA 95959
APN: 05-570-04

No.	Description	Date

Proj. No.: 2016015
Date: 08/03/2016
Scale: 1" = 1'-0"
Drawn By: JMT
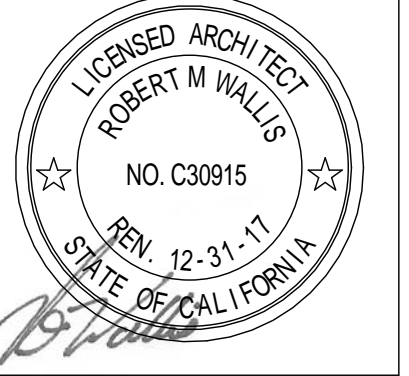
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GENERAL NOTES

COMPLIANCE WITH PLAN DOCUMENTS

- A. DIMENSIONS:
1. DIMENSIONS SHALL NOT BE SCALED FROM DRAWINGS.
2. ALL DIMENSIONS TO OPENINGS ARE TO THE ROUGH OPENING UNLESS NOTED OTHERWISE.
3. ALL DIMENSIONS TO STUD PARTITIONS ARE TO THE FACE OF FRAMING UNLESS NOTED OTHERWISE.
4. CEILING HEIGHT DIMENSIONS ARE FROM FINISH FLOOR TO FINISH FACE OF CEILING.
5. WHERE INDICATED, DIMENSIONS SHALL BE TO CENTER / GRID LINES.
6. ALL DIMENSIONS SHALL BE VERIFIED IN THE FIELD BEFORE PROCEEDING WITH THE WORK.
7. ACCESSIBILITY DIMENSIONS SHALL BE MEASURED TO FACE OF WALL FINISH, CLEAR OPENING AND AS INDICATED ON ENLARGED PLAN, MOUNTING HEIGHTS SHEET, TOILET ROOM ELEVATIONS AND STANDARD DETAILS DRAWING SHEET.
8. DIMENSIONING PROTOCOLS / HIERARCHY:
a. "ENLARGED PLAN" INCLUDE ALL DIMENSIONING ASSOCIATED WITH THE GRAPHICS SHOWN.
b. OVERALL PLANS SHOW DIMENSIONS NOT INDICATED ON "PARTIAL DIMENSIONING PLANS."
B. WHERE NO SPECIFIC DETAIL IS SHOWN, THE FRAMING OR CONSTRUCTION SHALL BE IDENTICAL OR SIMILAR TO THAT INDICATED FOR LIKE CASES OR CONSTRUCTIONS ON THE PROJECT AND IF NOT CLEAR AN REQUEST FOR INFORMATION (RFI) SHALL BE ISSUED TO ARCHITECT FOR CLARIFICATION.
C. CONCRETE CONSTRUCTION SHALL COMPLY WITH THE CALIFORNIA BUILDING CODE INCLUDING CHAPTERS 16, 17, 18 AND 19.
D. STEEL CONSTRUCTION SHALL COMPLY WITH THE CALIFORNIA BUILDING CODE INCLUDING CHAPTERS 16, 17 AND 22.
E. ALL INTERIOR FINISH MATERIALS SHALL HAVE A FLAME SPREAD CLASSIFICATION RATING PER CALIFORNIA BUILDING CODE INCLUDING CHAPTER 8.
F. ROOF COVERING AND ROOFING MATERIALS SHALL BE FIRE RETARDANT AND SHALL COMPLY WITH THE UNDERWRITERS LABORATORIES, INC. AND CLASSIFIED AS CLASS B U.L. FIRE HAZARD, MINIMUM UNLESS NOTED OTHERWISE ON DRAWINGS OR IN SPECIFICATIONS AND SHALL COMPLY WITH THE CALIFORNIA BUILDING CODE INCLUDING CHAPTER 15.
G. ALL EXIT ENCLOSURES AND SHAFT WALLS SHALL BE RATED CONSTRUCTION AND SHALL COMPLY WITH THE CALIFORNIA BUILDING CODE INCLUDING CHAPTER 7. REFER TO PLAN DOCUMENTS. ALL OPENINGS TO BE PROTECTED AS FOLLOWS:
1. ONE HOUR EXIT ENCLOSURE WALLS - 60 MINUTE RATED DOOR AND FRAME ASSEMBLY
2. ONE HOUR RATED SHAFT WALLS - 60 MINUTE LABELED DOOR AND FRAME ASSEMBLY
3. DOORS SHALL BE SELF CLOSING OR AUTOMATIC CLOSING BY ACTUATION OF A SMOKE DETECTOR
H. ALL REQUIRED EXITS SHALL BE OPENABLE FROM THE INSIDE AT ANY TIME BY TURNING OF THE LEVER OR DEPRESSING BAR OF PANIC EXIT DEVICE, WITHOUT THE USE OF A KEY OR ANY SPECIAL EFFORT OR KNOWLEDGE.
I. ILLUMINATED EXIT SIGNS SHALL BE INSTALLED WHERE INDICATED AND AT STAIR ENCLOSURES, HORIZONTAL EXITS, AND OTHER REQUIRED EXIT DOORWAYS IN ACCORDANCE WITH CALIFORNIA BUILDING CODE WHERE NECESSARY TO CLEARLY INDICATE THE DIRECTION OF EGRESS WHEN TWO OR MORE EXITS ARE REQUIRED AND AT ROOMS SERVING AN OCCUPANT LOAD OF MORE THAN 49.
J. DOOR SIZES INDICATED ON DOOR SCHEDULE ARE OPENING DIMENSIONS. ALLOWANCES FOR THRESHOLDS, FLOOR FINISHES, ETC. SHALL BE TAKEN OFF DOOR.
K. THE PRECISE DIMENSIONS AND LOCATIONS OF ALL DOORS, LOUVERS AND WINDOW OPENINGS SHALL BE DETERMINED BY ARCHITECTURAL PLANS AND DETAILS. OTHER WALL AND FLOOR OPENINGS AS REQUIRED BY MECHANICAL OR ELECTRICAL SHALL BE VERIFIED FROM SHOP DRAWINGS, EQUIPMENT DATA, ETC. AS REQUIRED, AND IF NOT CLEAR AN RFI SHALL BE ISSUED TO ARCHITECT FOR CLARIFICATION.
L. DOOR OPENINGS NOT LOCATED BY DIMENSIONS SHALL BE LOCATED 6 INCHES FROM FINISH WALL TO FINISH JAMB UNLESS OTHERWISE NOTED. IF DOOR CLEARANCE REQUIREMENTS AT PULL SIDE AND PUSH SIDE OF STRIKE ARE NOT ACHIEVABLE, THEN CONTRACTOR SHALL ISSUE A RFI FOR CLARIFICATION PRIOR TO PROCEEDING.
M. THERE SHALL BE A LEVEL FLOOR OR LEVEL LANDING ON EACH SIDE OF THE DOOR REGARDLESS OF THE OCCUPANT LOAD. THE FLOOR OR LANDING SHALL NOT BE MORE THAN ONE QUARTER INCH LOWER THAN THE THRESHOLD OR THE DOORWAY.
N. REFER TO ARCHITECTURAL REFLECTED CEILING PLANS FOR DIMENSIONS LOCATING LIGHT FIXTURES, DIFFUSERS AND WALL MOUNTED FIXTURES. REFER TO ELECTRICAL DRAWINGS FOR ALL LIGHTING FIXTURE TYPES, WIRING, ETC.
O. REFER TO ARCHITECTURAL INTERIOR ELEVATIONS FOR MOUNTING HEIGHTS. WALL FIXTURES THAT PROTRUDE BEYOND 4 INCHES OF WALL SURFACE SHALL BE LOCATED WITH BOTTOM OF FIXTURE 80 INCHES CLEAR OF FINISH FLOOR.
P. CEILING SUSPENSION SYSTEM SHALL PROVIDE FOR CEILING SYSTEM ONLY. ADDITIONAL INDEPENDENT FRAMING FOR LIGHTING FIXTURES, EXIT SIGNS, GRILLES AND AIR CONDITIONING DIFFUSERS SHALL BE REQUIRED. ATTACHMENT OF HANGERS OR FRAMING TO DUCTWORK IS PROHIBITED.
Q. PROVIDE ADEQUATE ANCHORAGE, BLOCKING, BACKING, AND FRAMING FOR FIRE SPRINKLERS, PIPING, LIGHT FIXTURES, ELECTRICAL UNITS, HVAC EQUIPMENT AND CEILING TRACKS AS REQUIRED FOR A COMPLETE INSTALLATION.
R. ALL CABINETS RECESSED INTO RATED WALLS SHALL BE BACKED WITH ONE HOUR FIRE RESISTIVE CONSTRUCTION AS REQUIRED. ELECTRICAL PANELS SHALL NOT BE LOCATED IN CORRIDOR OR SHAFT WALLS.
S. GYPSUM BOARD ON INTERIOR METAL STUDS SHALL BE "THICK TYPE "X", OR TYPE "C" UNLESS NOTED OTHERWISE AND IN COMPLIANCE WITH PLAN DOCUMENTS "WALL TYPES" REQUIREMENTS AND SPECIFICATIONS.
T. ACCESSIBLE TOILET STALL DOOR OPENINGS SHALL BE 32 INCHES CLEAR WIDE FOR END DOORS AND 34 INCHES CLEAR WIDE FOR SIDE DOORS.
U. PROVIDE 48 INCHES CLEARANCE IN TOILET COMPARTMENT FROM FRONT OF WATER CLOSET TO OPPOSITE FINISH WALL - END DOOR OPENING.
V. PROVIDE 60 INCHES CLEARANCE IN TOILET COMPARTMENTS FROM FRONT OF WATER CLOSET TO OPPOSITE FINISH WALL - SIDE DOOR OPENINGS.
W. PROVIDE 36 INCHES MAXIMUM UNOBSTRUCTED WORKING SPACE IN FRONT OF ALL PANEL BOARDS AND CONTROL EQUIPMENT.

BUILDING SECURITY STANDARDS

- A. ALL WORK SHALL COMPLY WITH THE FOLLOWING BUILDING SECURITY STANDARDS:
1. GENERAL REQUIREMENTS
a. SECURITY AND LOCKING DEVICES SHALL NOT CREATE HAZARDS TO LIFE BY OBSTRUCTING:
1. EXITWAYS OR MEANS OF EGRESS.
2. EXIT DOORS EQUIPPED WITH PANIC HARDWARE.
B. ASSEMBLIES AND SECURITY HARDWARE INSTALLED SHALL BE LABELED AND CERTIFIED AS MEETING UL (UNDERWRITERS LABORATORY) STANDARDS, OR OTHER APPROVED PERFORMANCE TESTING CRITERIA AS APPROVED BY AGENCY HAVING JURISDICTION.
C. REQUIRED AREA LIGHTING AND ADDRESS IDENTIFICATION SHALL BE INSTALLED BEFORE FINAL INSPECTION IS CALLED FOR.
D. ILLUMINATION PER CODE REQUIREMENTS SHALL BE PROVIDED ADJACENT TO ALL EXTERIOR DOORS DURING ALL HOURS OF DARKNESS TO PROVIDE MINIMUM REQUIRED FOOT CANDLE LEVEL AT PAVING.
E. WINDOW PROVISIONS:
1. GLAZING IN EXTERIOR DOORS OR WITHIN A 24 INCH ARC OF EITHER VERTICAL EDGE OF A DOOR IN THE CLOSED POSITION SHALL BE TEMPERED SAFETY GLAZING.
2. GLAZING AND GLAZED ASSEMBLIES FOR ACCESSIBLE OPENINGS SHALL BE CERTIFIED AS MEETING TEST PROVISIONS OF UL (UNDERWRITERS LABORATORY).
3. ALL GLAZING INSTALLED IN A HAZARDOUS LOCATION SHALL BE TEMPERED SAFETY GLASS.
4. GLAZING AND INSTALLATION SHALL BE IN COMPLIANCE WITH THE CALIFORNIA BUILDING CODE INCLUDING CHAPTER 24.
5. GLAZING SHALL BE TEMPERED SAFETY GLAZING WHERE INDICATED.

DEMOLITION NOTES

- A. THE OWNER SHALL OBTAIN A DEMOLITION PERMIT AND ANY OTHER REQUIRED APPROVALS PRIOR TO THE EXECUTION OF ANY DEMOLITION. THE CONTRACTOR SHALL FURNISH ALL LABOR AND MATERIALS REQUIRED TO COMPLETE THE DEMOLITION, RECYCLING, STORAGE AND PROTECTION OF ALL ITEMS WITHIN THE PROJECT AREA.
B. DEMOLITION WORK SHALL COMPLY WITH LOCAL ORDINANCES AND SAFETY CODES OF STATE OF CALIFORNIA AND RULES AND REGULATIONS OF INDUSTRIAL ACCIDENT COMMISSION OF STATE OF CALIFORNIA APPLICABLE TO DEMOLITION WORK.
C. THE CONTRACTOR SHALL COORDINATE DEMOLITION WITH THE OWNER AND AGENCIES HAVING JURISDICTION.
D. CONTRACTOR IS ADVISED THAT THERE MAY BE UNDERGROUND OR OTHERWISE CONCEALED PIPE LINES, ELECTRICAL/TELEPHONE WIRES, COLUMNS, BEAMS, FOOTINGS OR OTHER STRUCTURAL, MECHANICAL OR ELECTRICAL ITEMS. ALTHOUGH THE DRAWINGS PRODUCED BY THE ARCHITECT AND HIS CONSULTANTS ARE BELIEVED TO BE SUBSTANTIALLY CORRECT, THE ARCHITECT AND OWNER DO NOT GUARANTEE THE LOCATION OR EXISTENCE OR CONDITION OF ANY CONCEALED ITEMS. CONTRACTORS MUST PROCEED WITH CAUTION DURING DEMOLITION AND CONSTRUCTION AND MUST MAKE THEIR OWN DETERMINATION, MEASUREMENTS, AND EVALUATION OF THE WORKING CONDITION OF EXISTING CONCEALED ITEMS.
E. IF ANY HAZARDOUS MATERIALS ARE ENCOUNTERED DURING DEMOLITION, CONTRACTOR SHALL NOTIFY OWNER IN WRITING IMMEDIATELY. CONTRACTOR SHALL COMPLY WITH APPLICABLE REGULATIONS, LAWS AND ORDINANCES RELATIVE TO REMOVAL, HANDLING, AND PROTECTION AGAINST EXPOSURE OR ENVIRONMENTAL POLLUTION.
F. ANY INTERRUPTION TO BUILDING UTILITIES SHALL BE CLEARED WITH OWNER 72 HOURS PRIOR TO PROPOSED INTERRUPTION.
G. GENERAL CONTRACTOR SHALL BE RESPONSIBLE FOR MAINTAINING CONTAINERIZED DEBRIS REMOVAL AND RECYCLING SERVICE OF ALL DEBRIS FROM ALL TRADES AND ALL WORK RELATING TO THE PROJECT. THE CONTRACTOR SHALL COORDINATE THE CONSTRUCTION DUMPSTER AND/OR CHUTE LOCATION WITH OWNER PRIOR TO PLACEMENT.
H. CONTRACTOR IS TO USE ADEQUATE MEANS AND METHODS OF DEMOLITION AND REMOVAL FOR THE TYPE OF WORK PERFORMED.
I. PERFORM DEMOLITION WORK IN SUCH A MANNER AS TO PREVENT DAMAGE TO EXISTING FACILITIES TO REMAIN OR TO BE SALVAGED, AND TO PREVENT INJURY TO PUBLIC AND WORKMEN ENGAGED ON SITE UNDER THIS OR OTHER CONTRACTS.
J. THE CONTRACTOR SHALL PROTECT THE BUILDING EXTERIOR, ROADWAY AND LANDSCAPE FROM DAMAGE DURING THE DEMOLITION. ALL DAMAGE SHALL BE REPAIRED BY CONTRACTOR AT THEIR EXPENSE AND APPROVED BY OWNER.
K. THE CONTRACTOR SHALL NOTIFY OWNER AND ARCHITECT AT LEAST 48 HOURS IN ADVANCE OF DEMOLISHING ITEMS NOT SPECIFIED ON THE PLANS.

CONTRACTOR RESPONSIBILITIES

- A. THE CONTRACTOR SHALL EXAMINE THE DRAWINGS AND SPECIFICATIONS AND SHALL NOTIFY THE ARCHITECT OF ANY DISCREPANCIES FOUND PRIOR TO PROCEEDING WITH THE WORK IN UNCERTAINTY.
B. THE CONTRACTOR SHALL VERIFY CONDITIONS AT THE SITE AND REPORT ANY DISCREPANCIES TO THE ARCHITECT BEFORE PROCEEDING WITH THE WORK IN UNCERTAINTY.
C. THE CONTRACTOR SHALL NOTIFY UNDERGROUND SERVICE ALERT PRIOR TO ANY EXCAVATING.
D. THE CONTRACTOR SHALL COORDINATE THE REMOVAL, ABANDONMENT AND/OR LOCATIONS OF EXISTING UTILITIES ABOVE OR BELOW GRADE WITH THE RESPECTIVE UTILITY COMPANIES.
E. THE CONTRACTOR SHALL PERFORM ALL WORK WITHIN STREET RIGHT-OF-WAYS ACCORDING TO THE APPROVED STANDARD PLANS AND SPECIFICATIONS OF THE AGENCY HAVING JURISDICTION.
F. THE CONTRACTOR SHALL OBTAIN AN ENCROACHMENT PERMIT FOR ALL WORK IN CITY ROAD.
G. THE CONTRACTOR SHALL PROVIDE TEMPORARY BRACES, SHORES, AND GUYS REQUIRED TO SUPPORT ALL LOADS TO WHICH THE BUILDING STRUCTURES AND COMPONENTS, ADJACENT SOILS AND STRUCTURES, UTILITIES AND RIGHT-OF-WAYS MAY BE SUBJECT DURING CONSTRUCTIONS.
H. FLOOR AND WALL OPENINGS, SLEEVES, VARIATIONS IN THE STRUCTURAL SLAB ELEVATIONS, DEPRESSED AREAS AND ALL OTHER ARCHITECTURAL, STRUCTURAL, MECHANICAL, ELECTRICAL, AND/OR CIVIL REQUIREMENTS MUST BE COORDINATED BEFORE THE CONTRACTOR PROCEEDS WITH THE WORK.

TYPICAL NOTES

- A. SIMILAR - MEANS COMPARABLE CHARACTERISTICS FOR THE CONDITIONS NOTES. VERIFY DIMENSIONS AND/OR ORIENTATIONS ON PLANS AND/OR ELEVATIONS.
B. DIMENSIONS ARE NOT ADJUSTABLE WITHOUT APPROVAL OF ARCHITECT IN WRITING.
C. IT SHALL BE THE RESPONSIBILITY OF THE CONTRACTOR TO NOTIFY THE ARCHITECT OF ANY CONFLICTS HEREIN, EITHER APPARENT OR OBVIOUS, PRIOR TO START OF WORK ON THAT ITEM OR BEAR THE RESPONSIBILITY OF CORRECTING SUCH WORK AS DIRECTED BY THE ARCHITECT AND AT NO ADDITIONAL COST AND NO TIME EXTENSION OF THE PROJECT.
D. UNDERCUT ALL DOORS TO CLEAR TOP OF FLOOR FINISH AND/OR THRESHOLD 25 INCHES MAXIMUM AND IN COMPLIANCE WITH RATED DOOR/FRAME GUIDELINES.
E. PREPARE DOORS FOR HARDWARE SPECIFIED. TEST AND ADJUST DOORS FOR SMOOTH, QUIET OPERATION BEFORE FINAL INSPECTIONS TO CONFIRM MAXIMUM PRESSURE TO OPEN DOOR IS NOT EXCEEDED.
F. USE WATER RESISTANT / GLASS FIBER FACED GYPSUM WALLBOARD ON ALL WALL FACES WHICH ARE EXPOSED TO WATER OR MOISTURE AS WELL AS THOSE USED FOR JANITOR AND TOILET WALLS. COORDINATE WITH SPECIFICATIONS.
G. ALL EXTERIOR WALLS SHALL BE INSULATED AND IN COMPLIANCE WITH SPECIFICATIONS AND PLAN DOCUMENTS AND SHALL NOT FALL BELOW MINIMUM TITLE 24 REQUIREMENTS WHERE NOT INDICATED.
H. SEE DRAWINGS AND DETAILS FOR TYPICAL NOTES.
I. DEPRESS FLOOR SLABS AS REQUIRED FOR FLOOR CLOSURES.
J. PROVIDE ADEQUATE BLOCKING AND ANCHORAGE FOR CEILING AND WALL MOUNTED EQUIPMENT - I.E. WATER COOLERS, FIRE EXTINGUISHER CABINETS, HANDRAILS AND GUARDRAILS, ETC.
K. INTERIOR PARTITION FINISHES TERMINATE 8 INCHES ABOVE THE HIGHEST ADJACENT CEILING UNLESS NOTED OTHERWISE.
L. ALL CEILING CONSTRUCTIONS SHALL COMPLY WITH CBC CHAPTER 25 (MAXIMUM 12" JOIST SPACING AT CEILINGS) AND AS INDICATED IN DRAWINGS.
M. ALL OPENINGS INTO 1 HOUR STAIR ENCLOSURES SHALL BE PROTECTED BY LABELED CLASS B FIRE ASSEMBLY - 60 MINUTE RATING.

FIRE PROTECTION NOTES

- A. INTERIOR:
1. THE BUILDING IS PROVIDED WITH AN AUTOMATIC FIRE EXTINGUISHING SYSTEM THROUGHOUT AND THE PRE-ACTION DRY FIRE SPRINKLER SYSTEM WHERE INDICATED. SYSTEMS SHALL CONFORM TO THE CALIFORNIA BUILDING CODE, FIRE DEPARTMENT HAVING JURISDICTION AND SPECIFICATIONS. NO WORK TO THE EXISTING FIRE SPRINKLER IS ANTICIPATED.
2. ALL AUTOMATIC FIRE SPRINKLER SYSTEM WORK INCLUDING THE FIRE ALARM SYSTEM IS TO BE ENGINEERED, FURNISHED AND INSTALLED BY A LICENSED FIRE SPRINKLER CONTRACTOR.
3. FIRE SPRINKLER CONTRACTOR SHALL SUBMIT FIRE SPRINKLER DRAWINGS AND CALCULATIONS TO THE LOCAL FIRE CHIEF AND LOCAL BUILDING DEPARTMENT AS A DEFERRED SUBMITTAL FOR APPROVAL AND PERMIT PRIOR TO COMMENCING THE WORK.
B. PORTABLE FIRE EXTINGUISHERS
1. PORTABLE FIRE EXTINGUISHERS SHALL BE INSTALLED IN OCCUPANCIES AND LOCATIONS AS INDICATED ON DRAWINGS, AS HEREIN INDICATED AND SET FORTH IN THE CODE AND AS REQUIRED BY THE FIRE DEPARTMENT. THE MAXIMUM TRAVEL DISTANCE TO THE FIRE EXTINGUISHER SHALL NOT EXCEED 75 FEET ALONG AN UNOBSTRUCTED PATH OF TRAVEL, CFC TABLE 906.3(1). ALL PORTABLE FIRE EXTINGUISHERS SHALL HAVE A SERVICE TAG AFFIXED TO THEM SHOWING THAT THE EXTINGUISHER HAS BEEN SERVICED BY A CALIFORNIA STATE LICENSED FIRE EXTINGUISHER CONCERN. ALL FIRE EXTINGUISHERS SHALL BE ATTACHED TO A BRACKET OR WITHIN AN APPROVED CABINET, REFER TO DRAWINGS AND SPECIFICATIONS. MAXIMUM DISTANCE FROM THE FLOOR SHALL NOT EXCEED THE REQUIREMENTS OF CFC SECTION 906.9 AND ADA.
2. REFER TO DRAWINGS AND SPECIFICATIONS FOR ADDITIONAL INFORMATION.
C. APPROVALS:
1. SEPARATE DEFERRED SUBMITTAL REQUIRED FOR THE DESIGN, INSTALLATION AND MONITORING OF THE FIRE SPRINKLER SYSTEM. CONTRACTOR SHALL SUBMIT PLANS AND CALCULATIONS TO THE FIRE DEPARTMENT FOR PLAN CHECK REVIEW AND APPROVALS PRIOR TO SYSTEM INSTALLATION.

BUILDING CODE ANALYSIS

SITE ACCESSIBILITY

AT HAZARDOUS VEHICLE LOCATIONS:	A. CONFIRM WITH CITY AGENCY HAVING JURISDICTION.
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USE AND OCCUPANCY CLASSIFICATION

(CBC CHAPTER 3) 303.1, 303.1.2, 303.3, 303.4, 304.1	A. OCC TYPE B SECTION 304.1 - MAIN OCCUPANCY B. OCC TYPE S1 SECTION 311.1 - ACCESSORY OCCUPANCY
	SMALL ASSEMBLY SPACES • ROOMS USED FOR ASSEMBLY PURPOSES WITH AN OCCUPANT LOAD LESS THAN 50 SHALL BE CLASSIFIED AS A 'B' OCCUPANCY.

SPECIAL REQUIREMENTS BASED ON USE AND OCCUPANCY

(CBC CHAPTER 4)	A. NONE
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BASIC ALLOWABLE AREA, HEIGHT & STORIES

(CBC CHAPTER 5) TABLE 503, 504, 504.2, 506.3	TYPE II A (B OCC)
	AUTOMATIC SPRINKLER SYSTEM INCREASE: • BUILDING AREA INCREASED PER STORY BY 200% • BUILDING HEIGHT INCREASED BY 20'
	BUILDING AREA MODIFICATION: • 9000(2)=18,000 PER STORY
	A. ALLOWABLE BUILDING HEIGHT = 65'-0" ACTUAL = 35'-0" B. ALLOWABLE BUILDING AREA PER STORY= 37,500 SF ACTUAL = 16,775 SF C. ALLOWABLE NUMBER OF STORIES = 5 ACTUAL = 2

MIXED USE AND OCCUPANCY

(CBC CHAPTER 5) 508, 508.3.3	TYPE VB (B OCC)
	NO SEPERATION IS REQUIRED AT NON SEPERATED OCCUPANCIES

TYPES OF CONSTRUCTION

(CBC CHAPTER 6,7) 602, TABLE 601, TABLE 602, TABLE 705.8, TABLE 715.4	FIRE RESISTIVE RATING REQUIREMENTS: TYPE II A • BEARING WALLS - EXT = 1 HOUR (5≤10) = 1 HOUR (X≤5) • NON BEARING WALLS - EXT = NON-RATED (X ≤ -30'-0") = 1 HOUR (X≤30'-0") • BEARING WALLS - INT = NON-RATED • NON BEARING WALLS - INT = NON-RATED • STRUCTURAL FRAME = NON-RATED • PARTITIONS PERMANENT = NON-RATED • FLOOR AND FLOOR/CEILING = NON-RATED • ROOFS AND ROOF/CEILING = NON-RATED • EXTERIOR DOORS & WINDOWS = NON RATED • INTERIOR DOORS & WINDOWS = 3/4 HOUR @ 1-HOUR = 1/3 HOUR ELSEWHERE • EXIT PASSAGEWAYS = 1 HOUR
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FIRE ALARM AND DETECTION SYSTEMS

(CBC CHAPTER 9) 907.2.2.2 (EXCEPTION) 907.2.7 (EXCEPTION 2)	A. MANUAL FIRE ALARM SYSTEM • MANUAL FIRE ALARM BOXES ARE NOT REQUIRED THROUGHOUT BUILDING WHEN AN AUTOMATIC SPRINKLER SYSTEM IS INSTALLED IN ACCORDANCE WITH SECTION 903.3.1.1 • OCCUPANT NOTIFICATION APPLIANCES WILL ACTIVATE THROUGHOUT THE NOTIFICATION ZONES UPON SPRINKLER WATERFLOW. • AT LEAST ONE MANUAL FIRE ALARM BOX IS INSTALLED IN AN APPROVED LOCATION.
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CONCEALED SPACES

(CBC CHAPTER 7) 718.4 718.4.3	A. DRAFTSTOPPING IN ATTICS IN BUILDING WITH FIRE SPRINKLER THROUGHOUT NOT REQUIRED IN GROUPS B, AND S
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COMMON PATH OF EGRESS

(CBC CHAPTER 10) TABLE 1014.3	A. B AND S OCCUPANCY WITH APPROVED SPRINKLER SYSTEM • 100 FT OF TRAVEL DISTANCE ALLOWED
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EXITS

(CBC CHAPTER 10) TABLE 1015.1 TABLE 1016.1 1008.1.9.1 1008.1.9.2	A. MIN TWO EXITS REQUIRED BASED ON OCCUPANT LOAD B OCC ≥ 50 OCCUPANTS
	B. MAX EXIT TRAVEL DISTANCE A OCC = 250 FEET B OCC = 300 FEET
	C. HARDWARE • NO SPECIAL KNOWLEDGE HARDWARE TYPE • SHALL BE INSTALLED BETWEEN 34" MIN AND 44" FFF

ROOF CONSTRUCTION

(CBC CHAPTER 15) TABLE 1505.1	A. CONSTRUCTION TYPE VB • "CLASS C" MIN ROOF COVERING CLASSIFICATION
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INTERIOR WALL AND CEILING FINISH MATERIAL

(CBC CHAPTER 8) TABLE 803.9	B.OCC - FLAME SPREAD AND SMOKE DEVELOPED INDEX • EXITS, ENCLOSURES AND PASSAGEWAYS - CLASS 'B' • CORRIDORS - CLASS 'C' • ROOMS AND ENCLOSED SPACES - CLASS 'C'
	S.OCC - FLAME SPREAD AND SMOKE DEVELOPED INDEX • EXITS, ENCLOSURES AND PASSAGEWAYS - CLASS 'C' • CORRIDORS - CLASS 'C' • ROOMS AND ENCLOSED SPACES - CLASS 'C'

PORTABLE FIRE EXTINGUISHERS

(CFC CHAPTER 9) SECTION 906 TABLE 906.3(1)	A. EXTINGUISHER LOCATIONS • MAXIMUM FLOOR AREA 3,000 SF (3,600/3000=1.2 2 REQUIRED) • MAXIMUM TRAVEL DISTANCE 75 FEET
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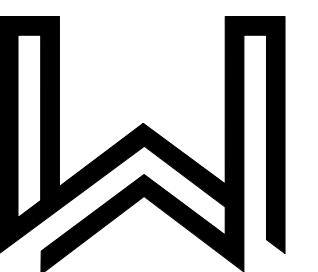
PLUMBING FIXTURE CALCULATION

(CPC CHAPTER 4) TABLE 422.1 EXCEPTION 3 TABLE A: OCCUPANT LOAD FACTOR	B OCCUPANCY - 2ND FLOOR TOTAL AREA = 4,217 SF CALCULATION = 4217/200 = 21.2 = 11 MALES AND 11 FEMALES
	B OCCUPANCY - 3RD FLOOR TOTAL AREA = 5,860 SF CALCULATION = 5860/200 = 29.2 = 15 MALES AND 15 FEMALES
	MINIMUM PLUMBING FIXTURES FOR MALE USE: (SEE NOTE #1) • 1 WATER CLOSET (1: 1-50) • 1 URINAL (1:1-100) • 1 LAVATORY (1: 1-75)
	MINIMUM PLUMBING FIXTURES FOR FEMALE USE: (SEE NOTE #1) • 1 WATER CLOSET (1: 1-15) • 1 LAVATORY (1: 1-50)
	MINIMUM DRINKING FOUNTAIN: • 1 DRINKING FOUNTAIN (1 PER 150)
	MINIMUM SERVICE SINK: • 1 SERVICE SINK (1 PER 150)
	SUMMARY
	NOTE: 1. TABLE 422.1 EXCEPTION 3 ALLOWS FOR BUSINESS OCCUPANCIES WITH AN OCCUPANT LOAD OF 50 OR LESS TO PROVIDED ACCOMODATIONS IN RESTROOM DESIGNED FOR A SINGLE OCCUPANT FOR USE BY BOTH SEXES.
	MINIMUM REQUIRED SERVICE SINK: 1 TOTAL PROVIDED SERVICE SINK: 1 OK

NOTE: Accessory Area's have been excluded from Calculations.

Schedule - CPC Area Totals 2ND						
Level	Room Number	Room Name	Occupancy	Area	Load Factor	Accessory Area
2ND FLOOR	202	OFFICE	B	194 SF	200	
2ND FLOOR	203	OFFICE	B	155 SF	200	
2ND FLOOR	206	STAFF LOUNGE	B	266 SF	200	
2ND FLOOR	211	OFFICE	B	83 SF	200	
2ND FLOOR	212	OFFICE	B	91 SF	200	
2ND FLOOR	213	Room	B	43 SF	200	
2ND FLOOR	214	INTERVIEW	B	67 SF	200	
2ND FLOOR	215	INTERVIEW	B	62 SF	200	
2ND FLOOR	216	INTERVIEW	B	74 SF	200	
2ND FLOOR	217	INTERVIEW	B	88 SF	200	
2ND FLOOR	218	INTERVIEW	B	94 SF	200	
2ND FLOOR	224	OFFICE	B	106 SF	200	
2ND FLOOR	225	OFFICE	B	112 SF	200	
2ND FLOOR	226	OFFICE	B	111 SF	200	
2ND FLOOR	227	OFFICE	B	113 SF	200	
2ND FLOOR	N-200	PD WAITING	B	235 SF	200	
2ND FLOOR	N-201	CONFERENCE	B	593 SF	200	
2ND FLOOR	N-213	PROBATION WAITING	B	579 SF	200	
2ND FLOOR	N-216	OFFICE	B	127 SF	200	
2ND FLOOR	N-217	OFFICE	B	99 SF	200	
2ND FLOOR	N-223	OPEN OFFICE	B	573 SF	200	
2ND FLOOR	N-226	CONFERENCE	B	264 SF	200	
2ND FLOOR	N-232	PD RECEPTION	B	88 SF	200	
TOTAL: 4,217 SF						

Schedule - CPC Area Totals 3RD						
Level	Room Number	Room Name	Occupancy	Area	Load Factor	Accessory Area
3RD FLOOR	301	OFFICE	B	269 SF	200	
3RD FLOOR	302	OFFICE	B	125 SF	200	
3RD FLOOR	303	OFFICE	B	119 SF	200	
3RD FLOOR	304	OFFICE	B	158 SF	200	
3RD FLOOR	305	OFFICE	B	140 SF	200	
3RD FLOOR	309	OFFICE	B	110 SF	200	
3RD FLOOR	310	OFFICE	B	109 SF	200	
3RD FLOOR	311	OFFICE	B	114 SF	200	
3RD FLOOR	312	OFFICE	B	93 SF	200	
3RD FLOOR	313	OFFICE	B	120 SF	200	
3RD FLOOR	314	OFFICE	B	288 SF	200	
3RD FLOOR	315	OFFICE	B	110 SF	200	
3RD FLOOR	316	OFFICE	B	110 SF	200	
3RD FLOOR	317	OFFICE	B	110 SF	200	
3RD FLOOR	318	OFFICE	B	110 SF	200	
3RD FLOOR	321	OFFICE	B	129 SF	200	
3RD FLOOR	322	OFFICE	B	123 SF	200	
3RD FLOOR	324	OFFICE	B	117 SF	200	
3RD FLOOR	325	OFFICE	B	111 SF	200	
3RD FLOOR	326	OFFICE	B	112 SF	200	
3RD FLOOR	327	OFFICE	B	111 SF	200	
3RD FLOOR	328	LOBBY	B	91 SF	200	
3RD FLOOR	329	OFFICE	B	128 SF	200	
3RD FLOOR	330	OFFICE	B	121 SF	200	
3RD FLOOR	331	OFFICE	B	132 SF	200	
3RD FLOOR	N-301	OFFICE	B	98 SF	200	
3RD FLOOR	N-302	OFFICE	B	98 SF	200	
3RD FLOOR	N-303	OFFICE	B	97 SF	200	
3RD FLOOR	N-323	OPEN OFFICE	B	2307 SF	200	
TOTAL: 5,860 SF						




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Nevada City, CA 95959
APN: 05-570-04

No.	Description	Date

Proj. No.: 2016015
Date: 08/03/2016
Scale: 1" = 1'-0"
Drawn By: JMT


A0.2

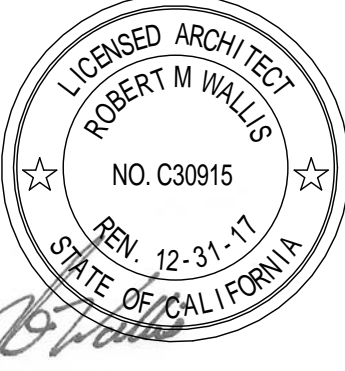CODE ANALYSIS



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No.	Revision	Description	Date
1			

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A0.3
EXITING & SIGNAGE

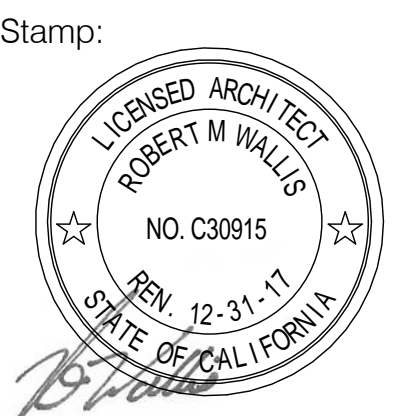LEGEND

- ROOM SYMBOLS**
- NAME ROOM NAME
 - 101 ROOM NUMBER
 - 150 SF SQUARE FOOTAGE
 - OCCUPANCY OCCUPANCY TYPE
- EXISTING ANALYSIS SYMBOLS**
- OCCUPANT LOAD OF SPECIFIC ROOM
 - SF / FLOOR AREA ALLOWANCE PER OCCUPANT = OCCUPANT LOAD
 - ARROW SHOWS DIRECTION OF TRAVEL
 - ESTIMATED OCCUPANT LOAD TO EXIT FROM MAIN AREA, TYPICALLY 1/2 OR 1/3 THE MAIN AREA OCCUPANT LOAD
 - ARROW SHOWS DIRECTION OF TRAVEL
 - COMBINED OCCUPANT LOAD WHEN MULTIPLE LOADS DUMP INTO A SINGLE AREA
 - OCCUPANT LOAD AT EXTERIOR DOOR USED FOR MINIMUM CLEAR DOOR WIDTH CALCULATION
 - OCCUPANT LOAD AT STAIR USED FOR MINIMUM STAIR WIDTH CALCULATION
 - AU ACCESSORY USE = 0 OCCUPANT LOAD
 - AL PORTABLE ASSISTED LISTENING SYSTEM
 - COMMON PATH OF TRAVEL
 - ACCESSIBLE PATH OF TRAVEL, REFER TO SITE PLAN
- HARDWARE**
- TYPICAL NON LATCHING HARDWARE AT EXIT DOORS.
 - PANIC DEVICE (EXIT DEVICE) AT LATCHING DOORS.
- SIGNAGE**
- REFER TO SIGNAGE LEGEND
 - (N) NEW FIXTURE/SIGNAGE
- EXIT SIGNS (ILLUMINATED)**
- ILLUMINATED EXIT SIGN
 - ILLUMINATED DIRECTIONAL EXIT SIGN
- FIRE EXTINGUISHERS**
- FIRE EXTINGUISHER AND BRACKET: SURFACE WITH SIGNAGE
 - FIRE EXTINGUISHER: FULLY RECESSED WITH SIGNAGE
 - FIRE EXTINGUISHER: SEMI RECESSED WITH SIGNAGE
- CONCEALED SPACES**
- EXISTING DRAFTSTOP LOCATION ABOVE CEILING
- FIRE RATINGS**
- 1-H 1 - HOUR FIRE RATED WALL LOCATION


GENERAL NOTES

- FOR SIGNAGE REFER TO SPECIFICATION SECTION 10440, DETAILS AND THIS SHEET. VERIFY ALL LETTER SIGNAGE WITH ARCHITECT PRIOR TO FABRICATION.
- COORDINATE THIS PLAN WITH DOCUMENTS INCLUDING BUT NOT LIMITED TO SITE PLAN, FLOOR PLANS, ELEVATIONS, AND CEILING PLANS FOR ALL DISCIPLINES.
- INSTALL BLANK SIGN ON OPPOSITE SIDE OF SIGN WHEN INSTALLING ON GLASS.
- MOUNT SIGNS BACK TO BACK AT GLAZING.
- ALL SIGNAGE IS EXISTING, UNO.


SIGNAGE LEGEND

- SIGN IDENTIFICATION**
- TACTILE EXIT SIGN: "EXIT" (CBC 1011.1.1011-4) EACH GRADE LEVEL EXTERIOR DOOR WHICH LEADS DIRECTLY TO EXTERIOR.
 - TACTILE EXIT SIGN: "EXIT ROUTE" (CBC 1011.1.1011-4) EACH EXIT DOOR OR EXIT PATH WHICH INCLUDES AN EXIT SIGN THAT LEADS DIRECTLY TO A GRADE LEVEL EXIT BY MEANS OF AN EXIT ENCLOSURE OR AN EXIT PASSAGEWAY SHALL BE IDENTIFIED BY A TACTILE EXIT SIGN. EACH EXIT ACCESS DOOR FROM AN INTERIOR ROOM OR AREA TO A CORRIDOR OR HALLWAY THAT IS REQUIRED TO HAVE A VISUAL EXIT SIGN SHALL BE IDENTIFIED BY A TACTILE EXIT SIGN.
 - TACTILE SIGN "NOT AN EXIT"
 - RESTROOM DOOR MOUNTED IDENTIFICATION SIGN: "MEN" OR "WOMEN" WITH WHEELCHAIR (1 A3.2)
 - RESTROOM WALL MOUNTED IDENTIFICATION SIGN: "MEN" OR "WOMEN" WITH WHEELCHAIR (1 A3.2)
 - PERMANENT AND TACTILE ROOM IDENTIFICATION SIGN (1 A3.2)
- BUILDING ENTRANCE AND ACCESSIBILITY SIGNAGE**
- ACCESSIBLE ENTRANCE SIGN: "INTERNATIONAL SYMBOL OF ACCESSIBILITY" (13 A0.5)
- SITE ENTRANCE AND ACCESSIBILITY SIGNAGE**
- SITE ACCESSIBLE ENTRANCE SIGN (19 A0.5)
- ACCESSORY SIGNAGE**
- FIRE EXTINGUISHER SIGNAGE.
- OCCUPANCY**
- MAXIMUM OCCUPANCY SIGNAGE: "MAXIMUM OCCUPANCY SHALL NOT EXCEED [FILL IN]" WHICH READS MAXIMUM NUMBER OF PEOPLE PER CBC SECTION 1004.3 AND QUANTITY AS NOTED ON PLAN. MOUNT SIGN ON WALL AT 8'-0" AFF TO TOP OF SIGN.
- NOTE: REFER TO SITE PLAN AND DETAILS FOR SITE SIGNAGE NOT ATTACHED TO BUILDING OR LOCATED WITHIN BUILDING.


DOOR EXIT WIDTH:
37 X 0.2 = 7.4' < 36"

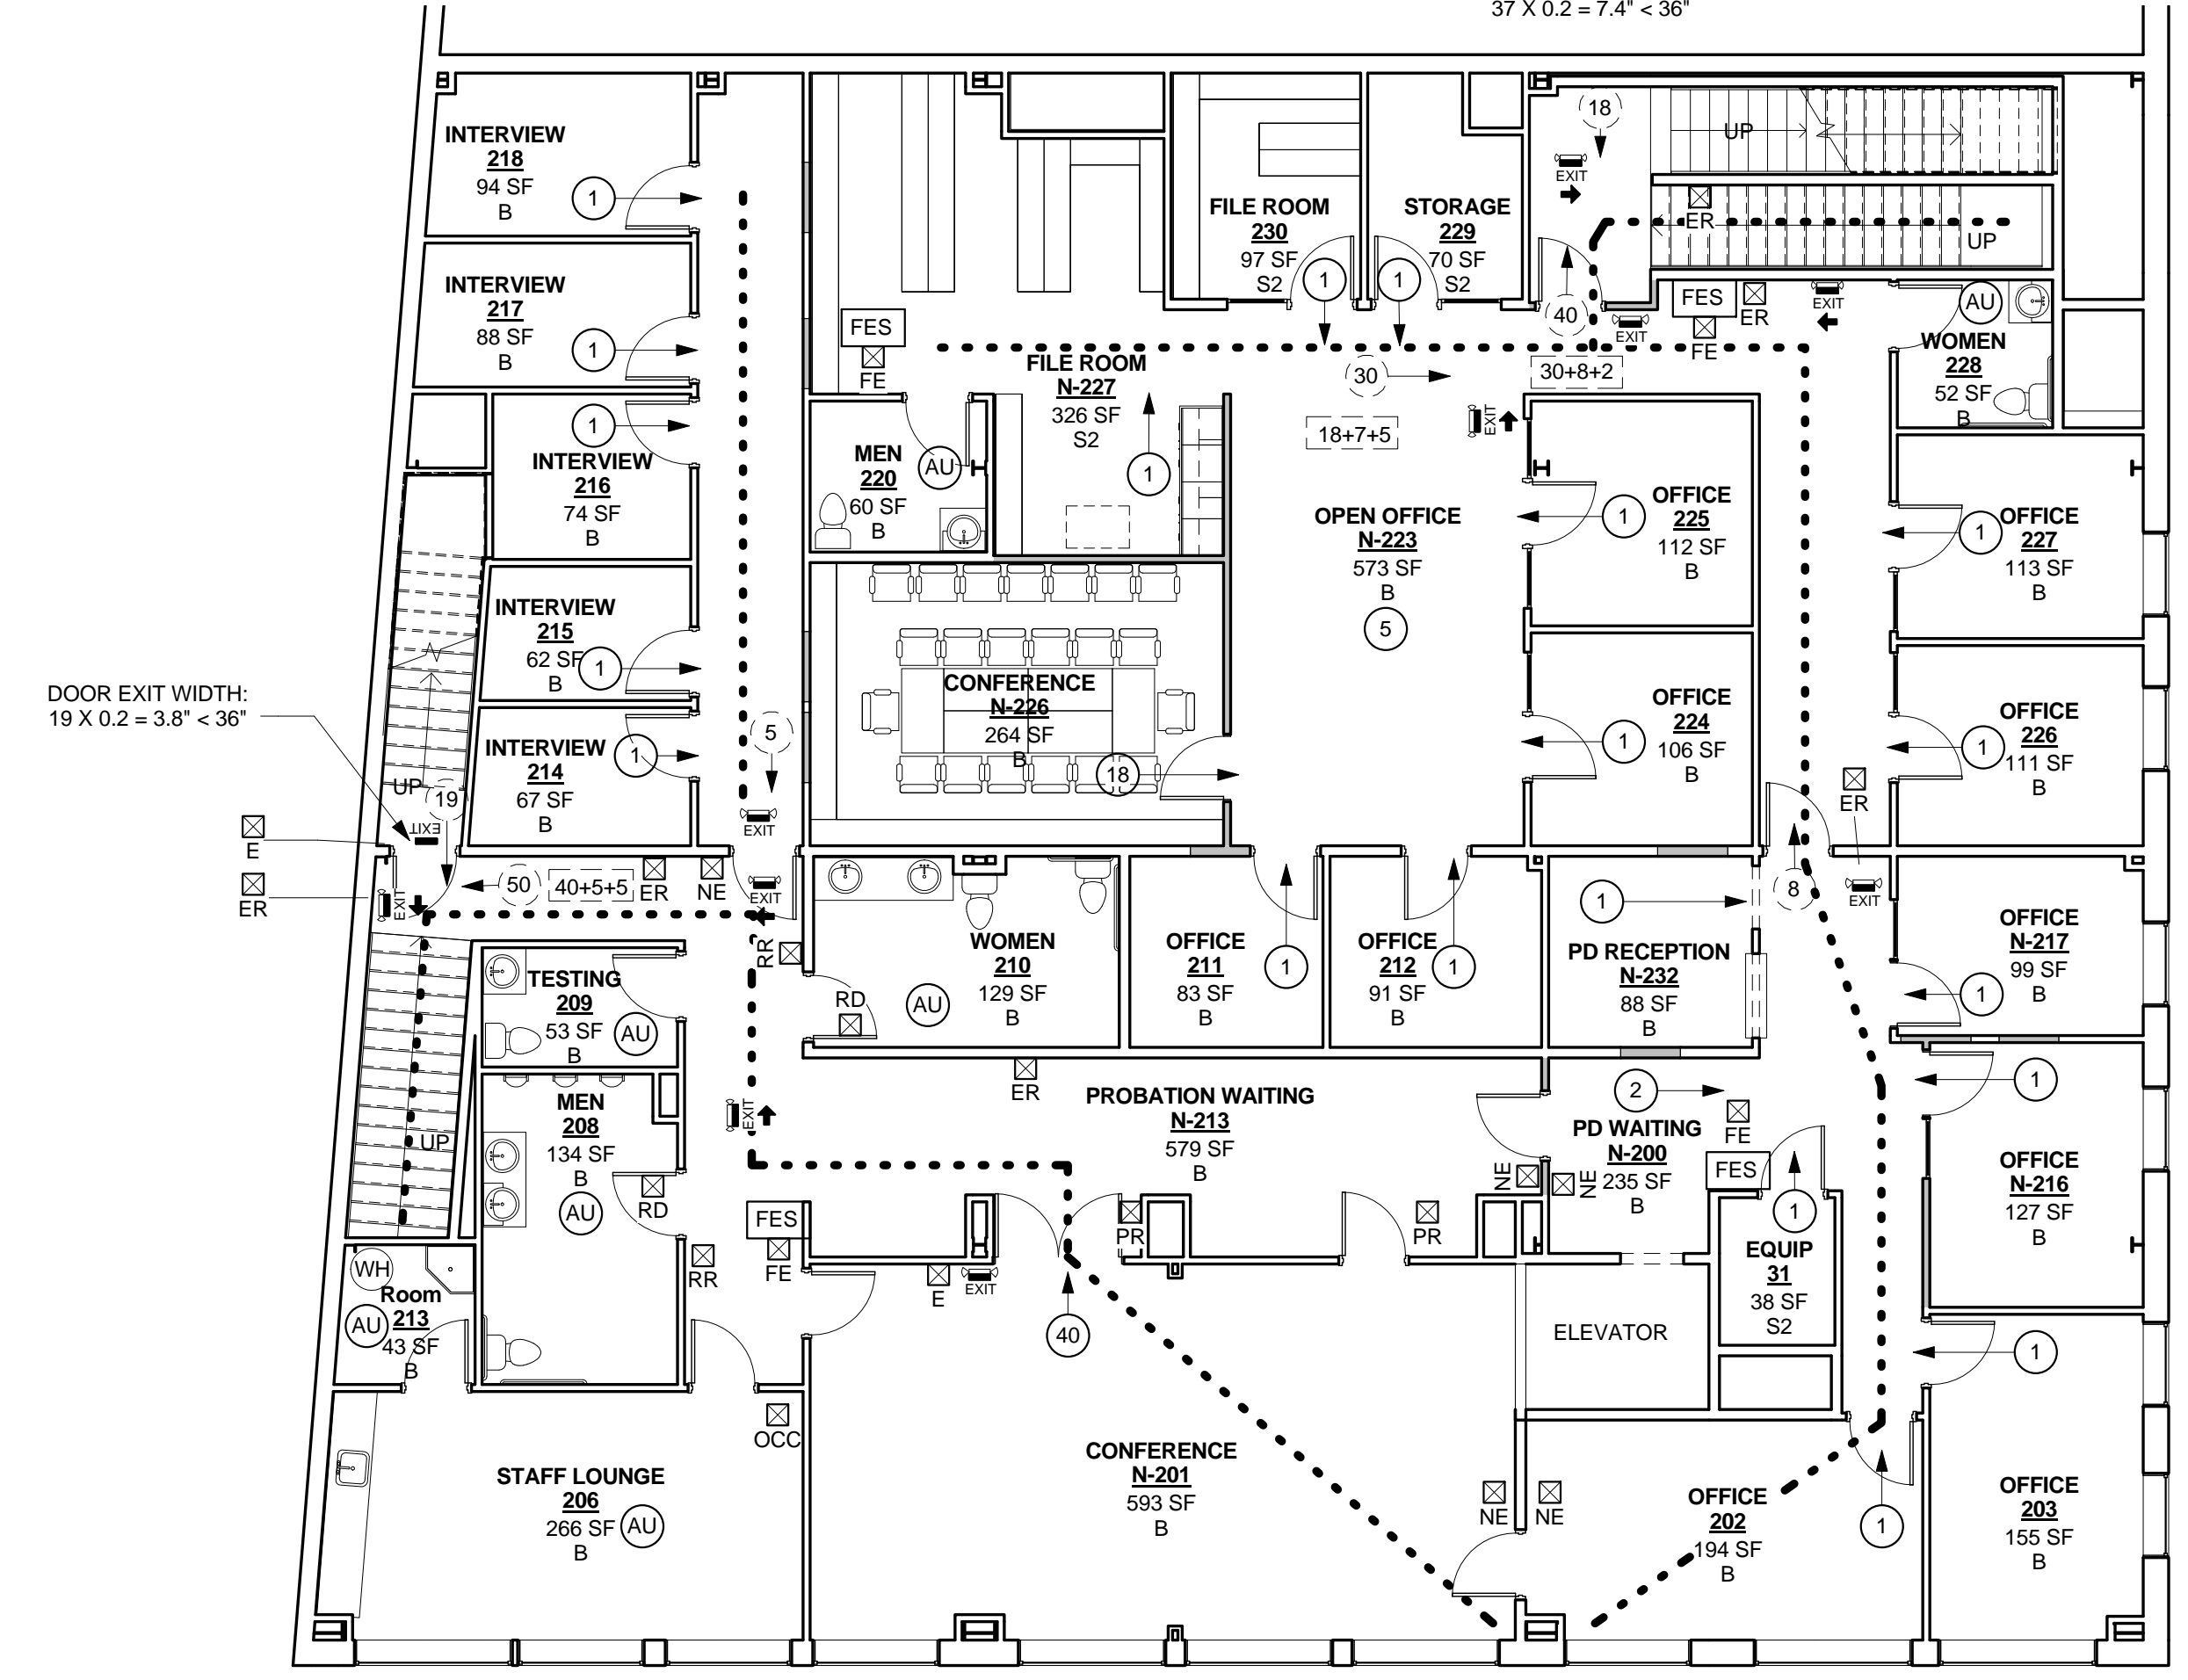

2 2ND FLOOR - EXIT PLAN
1/8" = 1'-0"

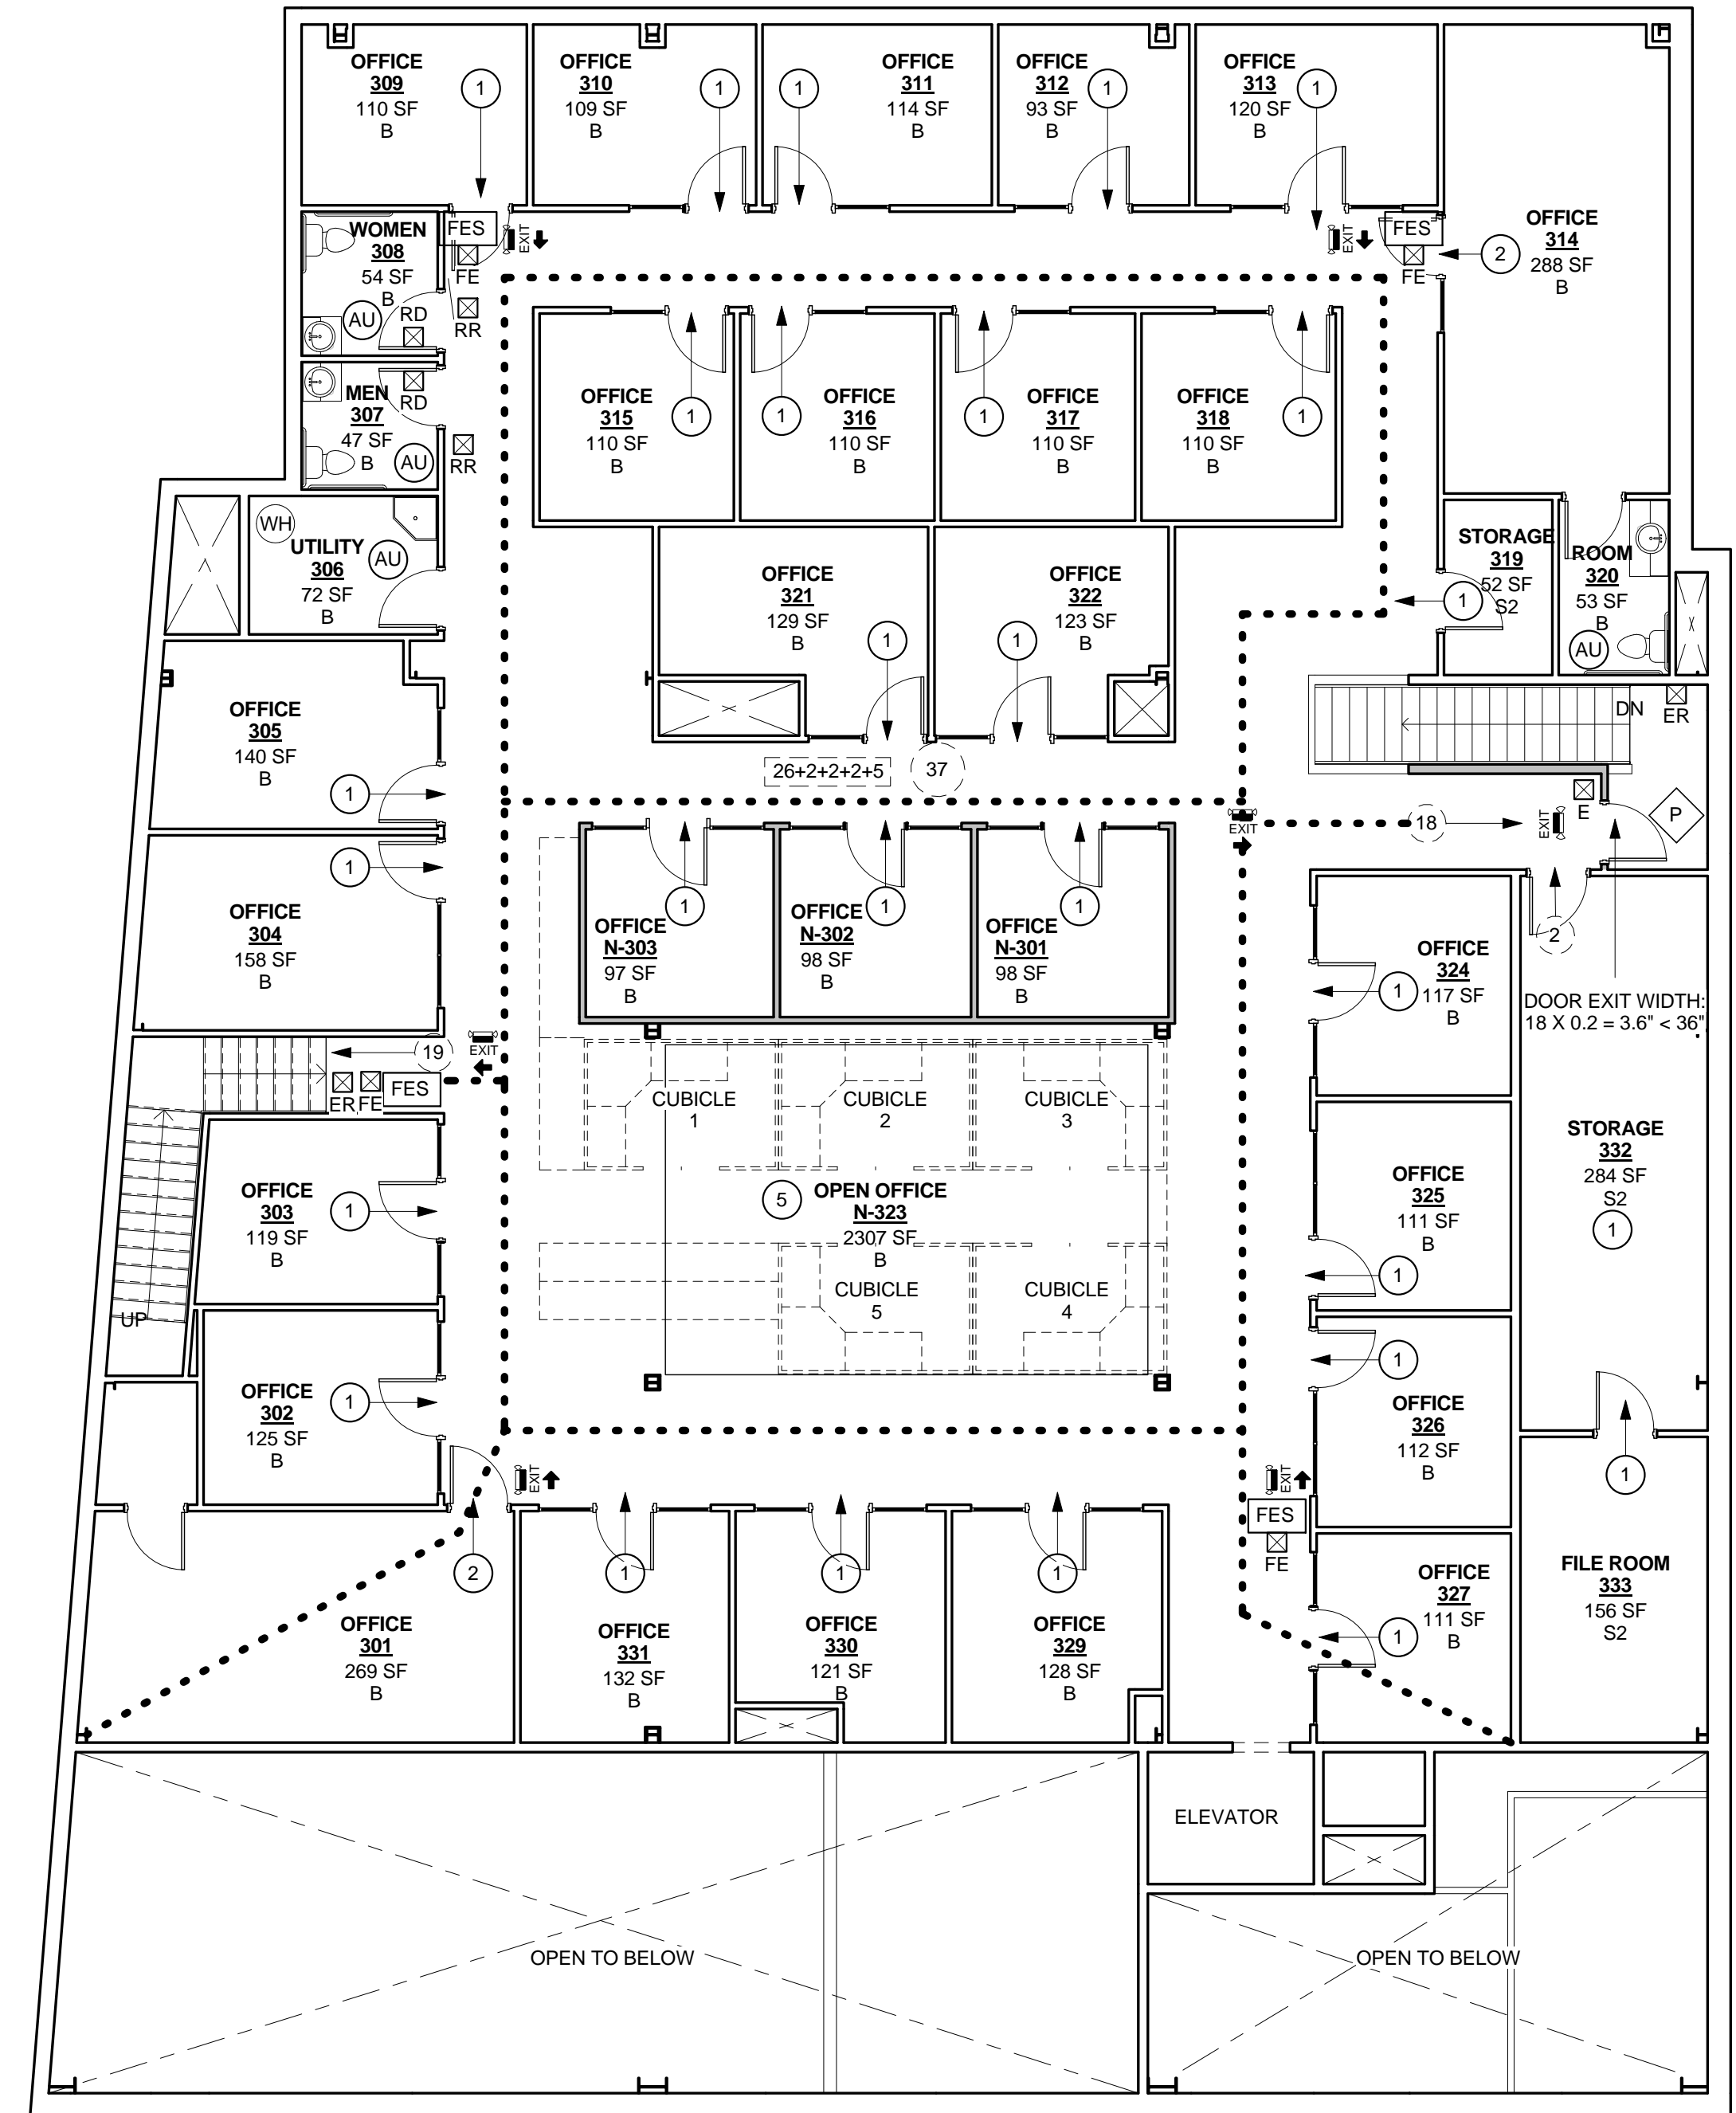

3 3RD FLOOR - EXIT PLAN
1/8" = 1'-0"

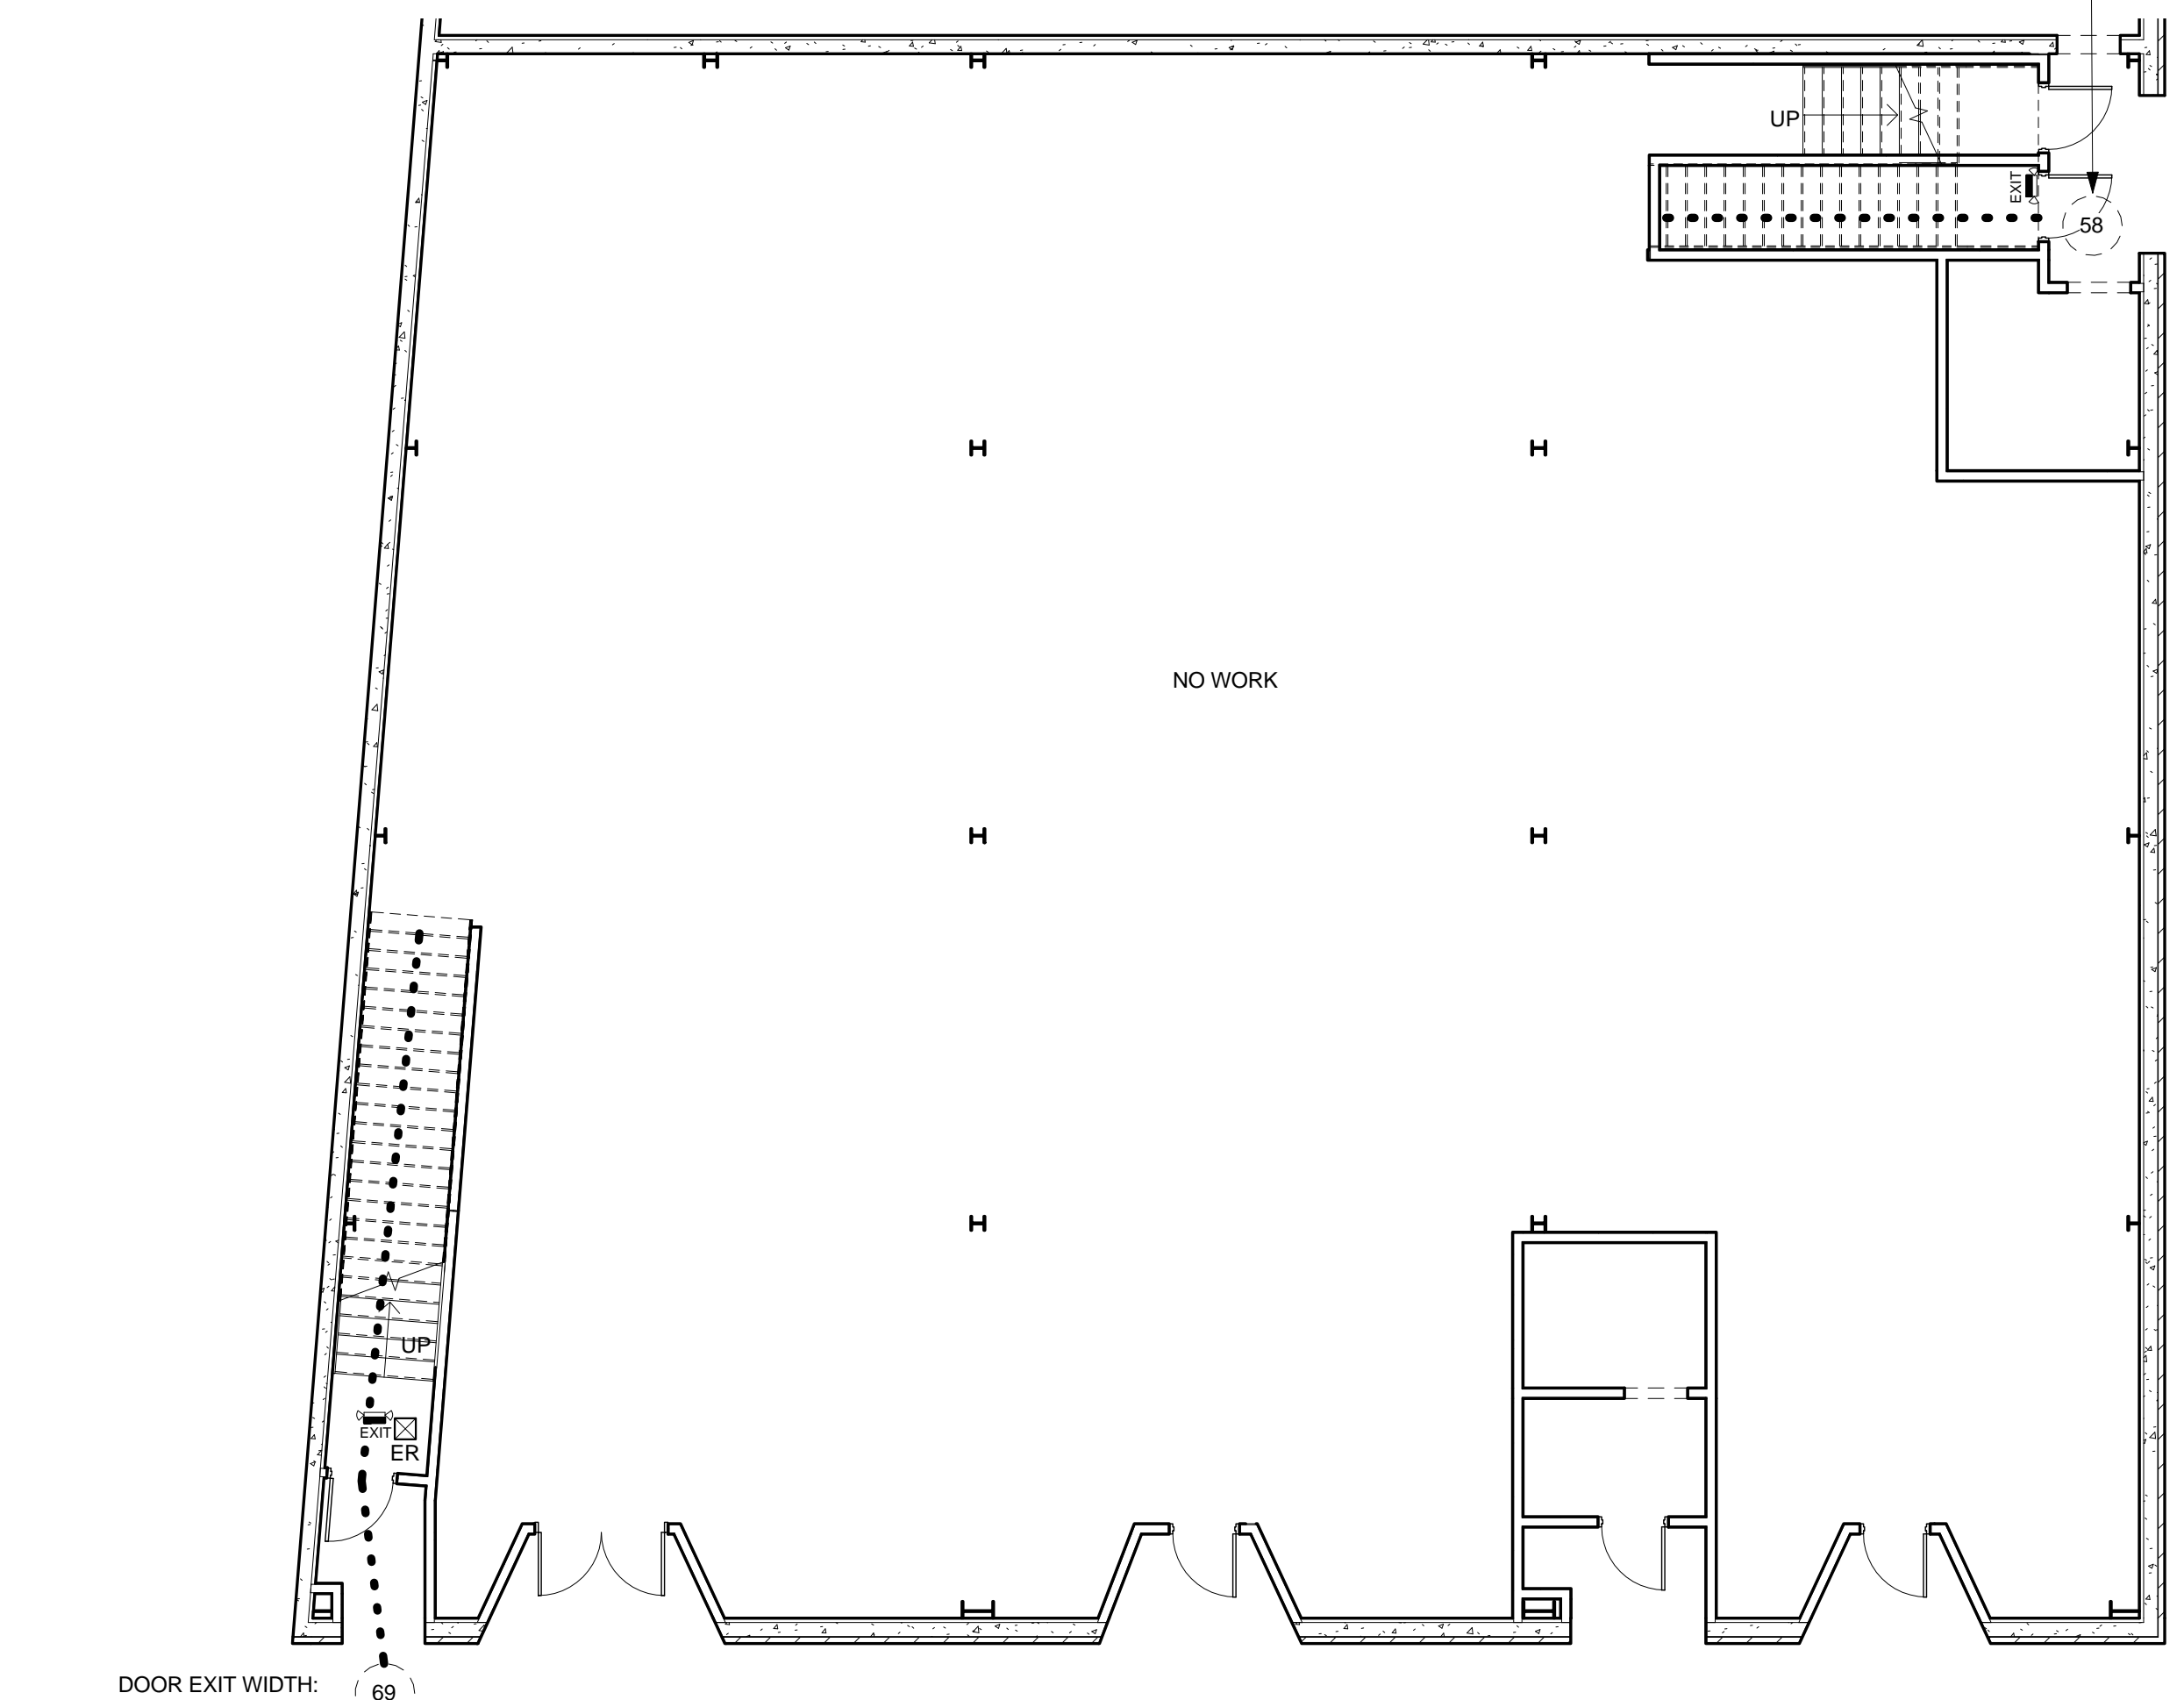

1 1ST FLOOR - EXIT PLAN
1/8" = 1'-0"

LEGEND

- (E) NON-BEARING WALL TO REMAIN
- (E) NON-BEARING WALL TO BE REMOVED

GENERAL NOTES


- A. REFER TO DEMOLITION NOTES ON SHEET A0.1 FOR ADDITIONAL INFORMATION.
- B. ALL DOORS, WINDOWS, SIGNAGE, APPLIANCES AND LIGHT FIXTURES TO BE SALVAGED AND STORED PER OWNER'S INSTRUCTIONS.
- C. WHERE FLOORING IS REMOVED, CONCRETE SLAB TO BE PREPARED FOR INSTALLATION OF NEW FLOORING MATERIAL, PER MANUFACTURER'S REQUIREMENTS.
- D. ABANDONED PLUMBING PIPING & UTILITY CONDUITS TO BE DISCONNECTED & SEALED.

DEMOLITION NOTICE REQUIRED

- A. THE ASBESTOS NESHAP REGULATION, 40 CFR, SUBPART M SECTION 61.145 REQUIRES WRITTEN NOTIFICATION OF DEMOLITION OR RENOVATION OPERATIONS.
- B. CONTRACTOR SHALL MAKE ALL REQUIRED NOTIFICATIONS.
- C. CALIFORNIA AIR BOARD ASBESTOS FORM CAN BE DOWNLOADED AT: <http://www.arb.ca.gov/enf/asbestos/asbestosform.pdf>

KEYNOTES

- 024119.C17 DOOR AND FRAME TO BE REMOVED
- 024119.C18 WINDOW AND FRAME TO BE REMOVED
- 024119.C22 WALL TO BE REMOVED
- 024119.C24 PARTITION TO BE REMOVED
- 024119.C27 GYPSUM BOARD AND STUDS TO BE REMOVED

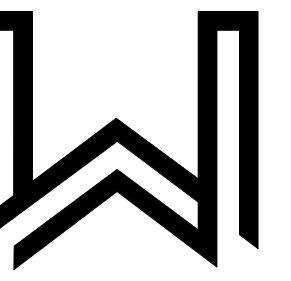


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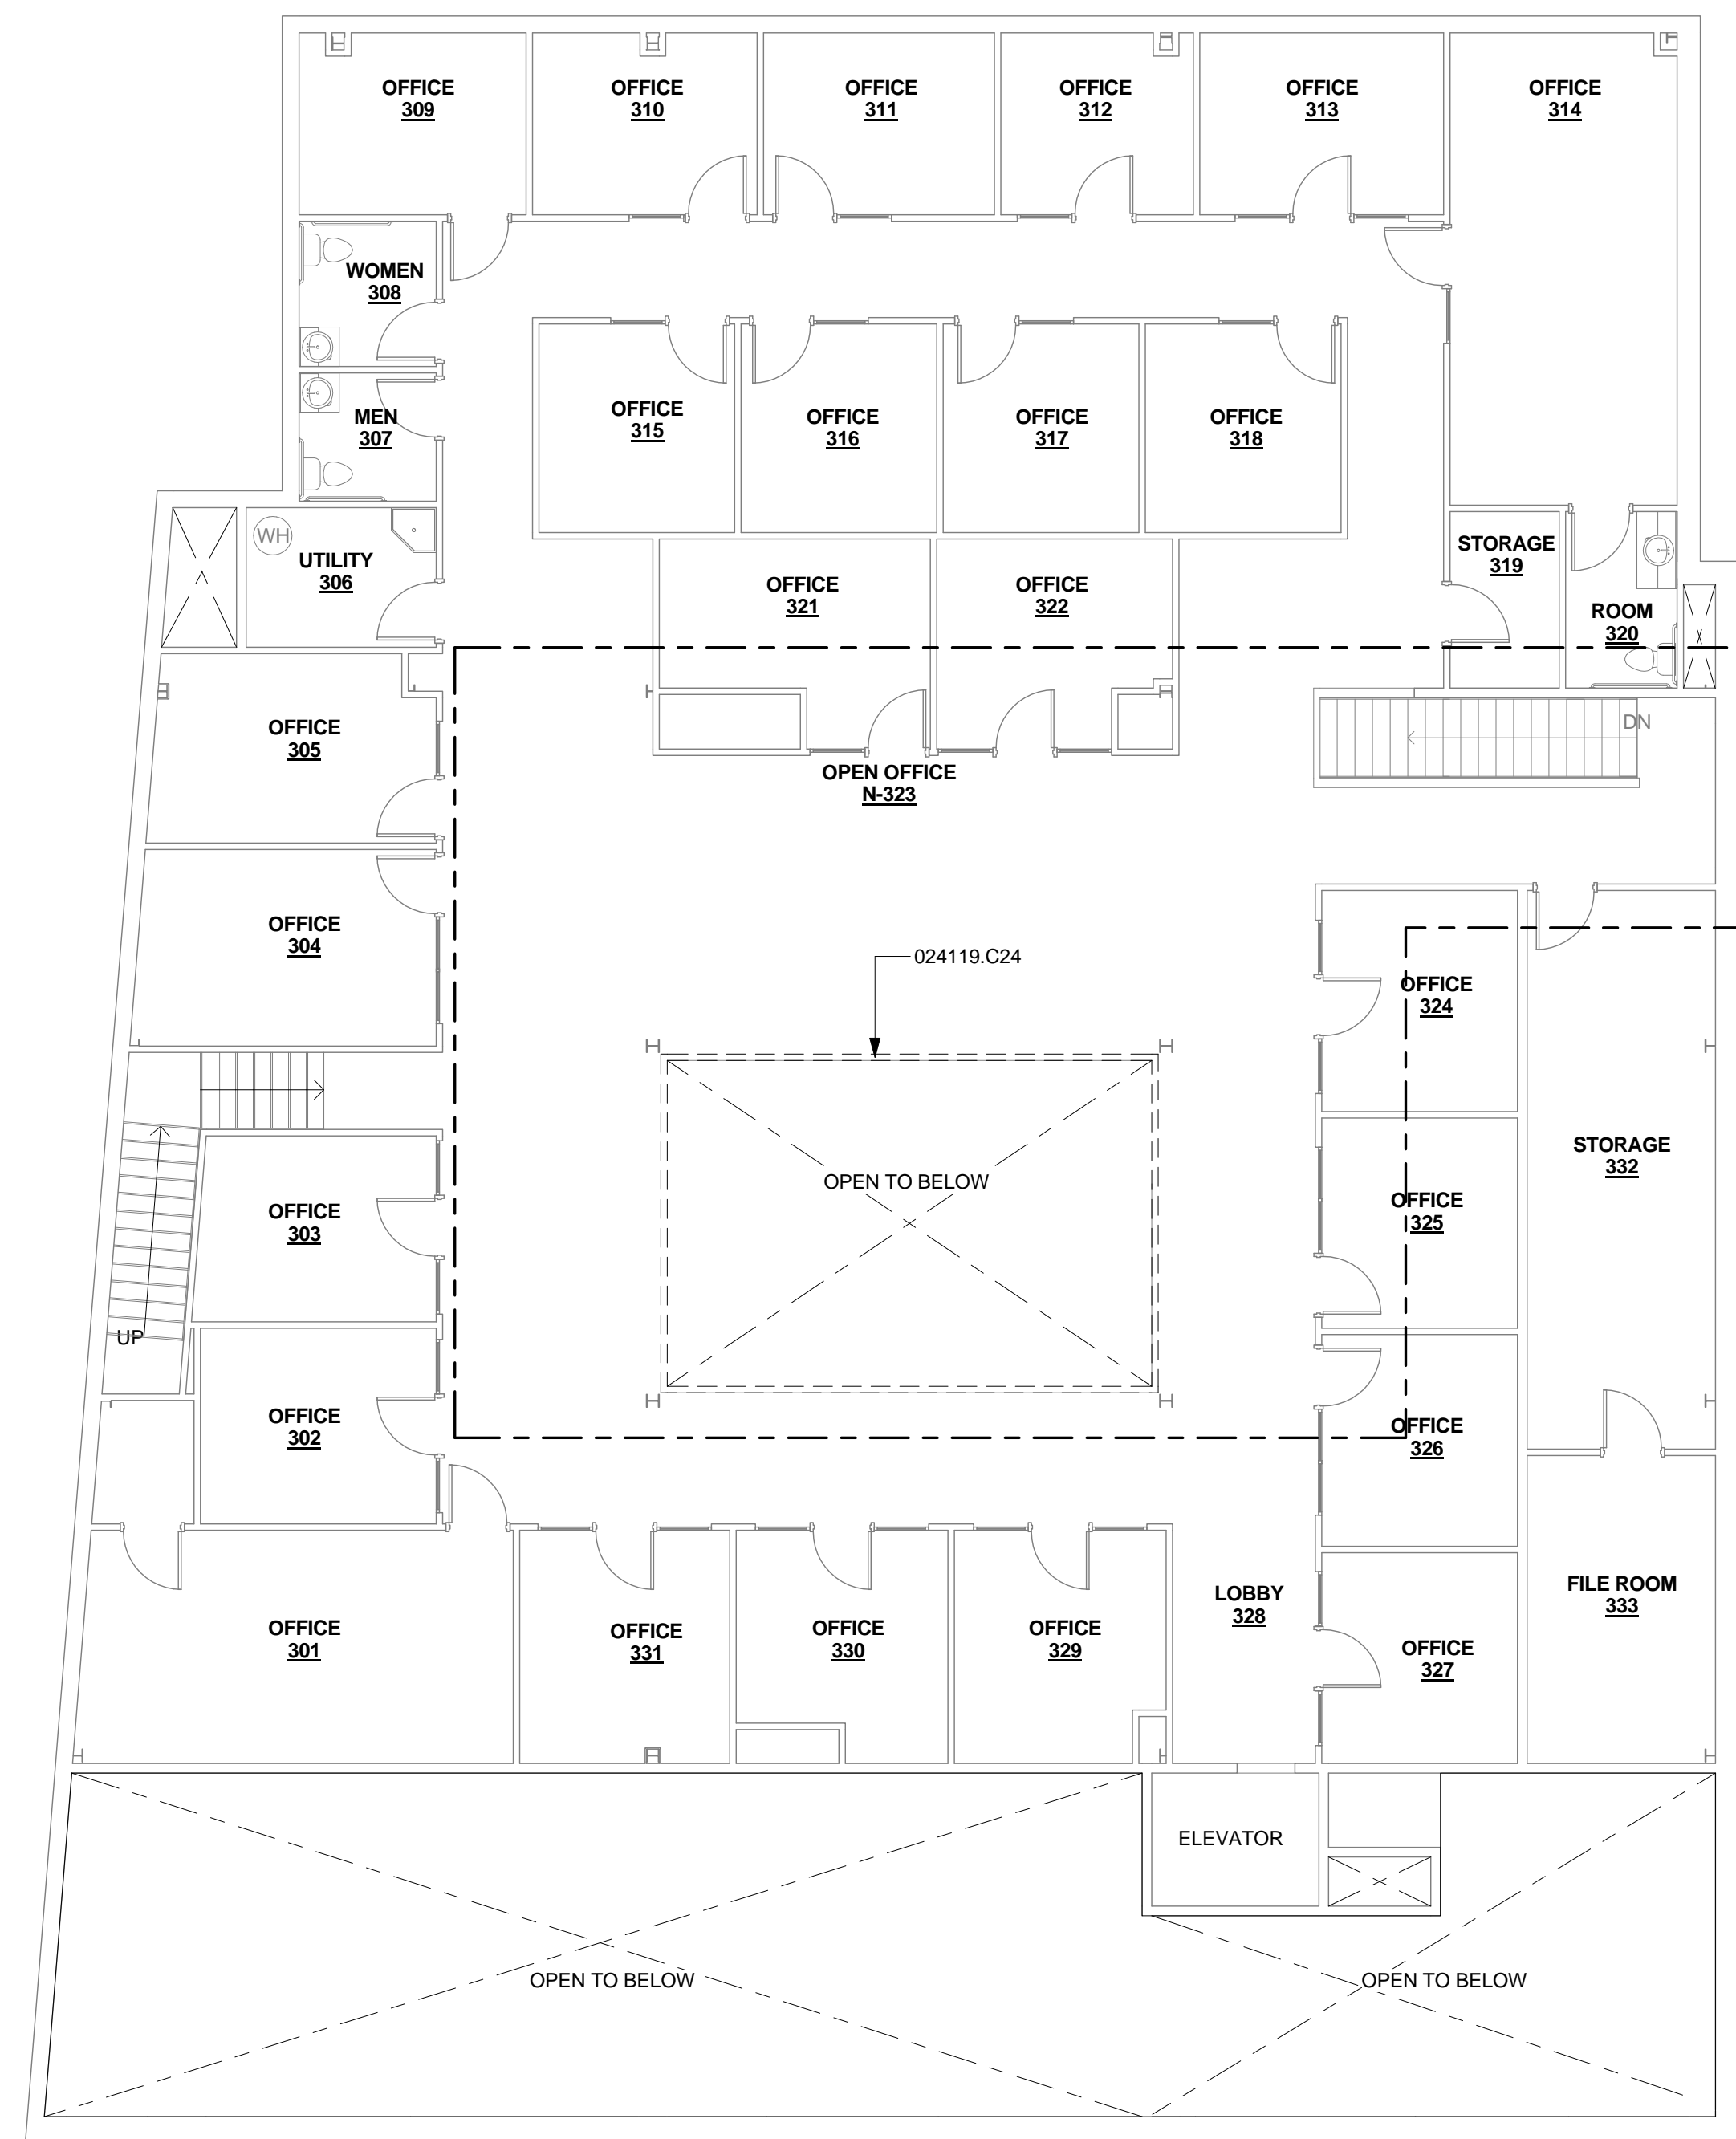
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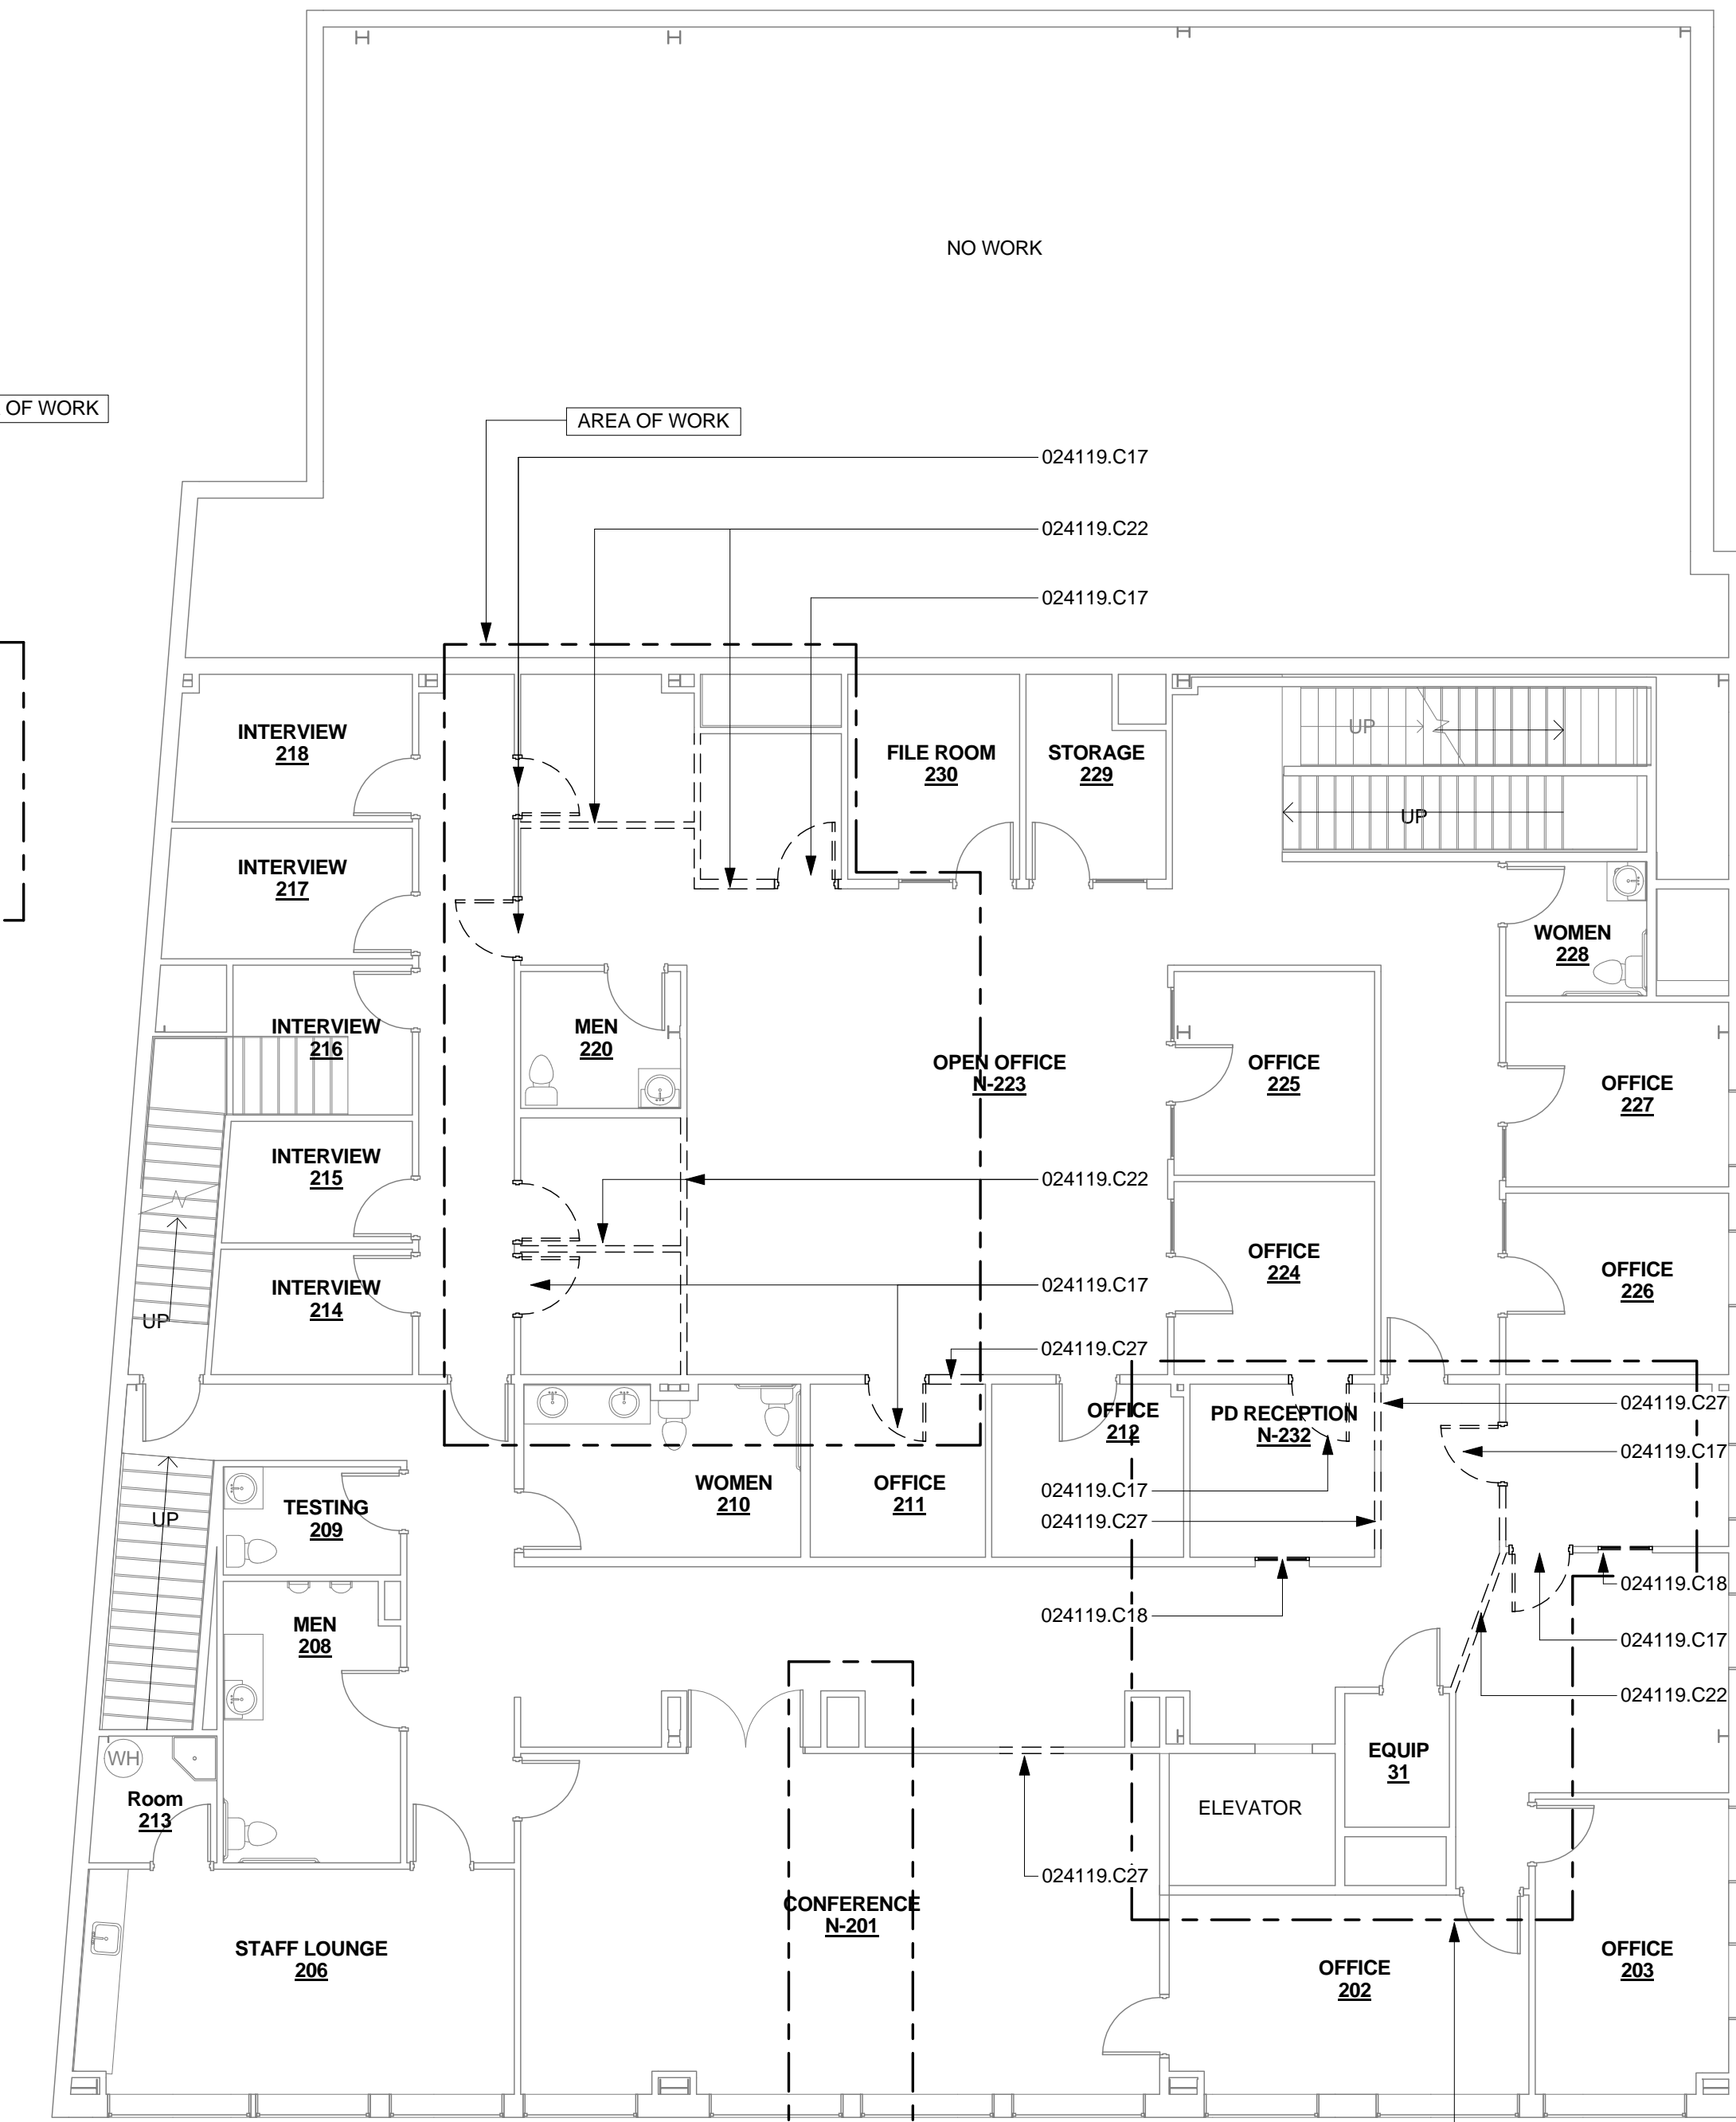
No.	Description	Date

Proj. No.: 2016015
Date: 08/03/2016
Scale: As indicated
Drawn By: S.A.M.

A2.0
2ND & 3RD FLOOR EXISTING & DEMO PLAN
8/4/2016 8:39:33 AM

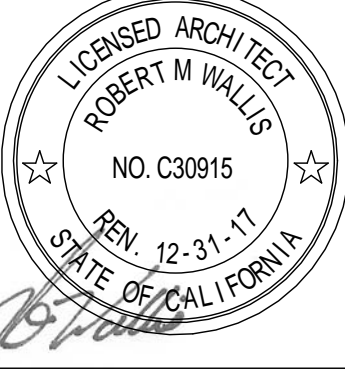


LIGHTING FIXTURES:
(E) TOTAL = 61




2 3RD FLOOR - EXISTING + DEMO PLAN
1/8" = 1'-0"

1 2ND FLOOR - EXISTING + DEMO PLAN
1/8" = 1'-0"

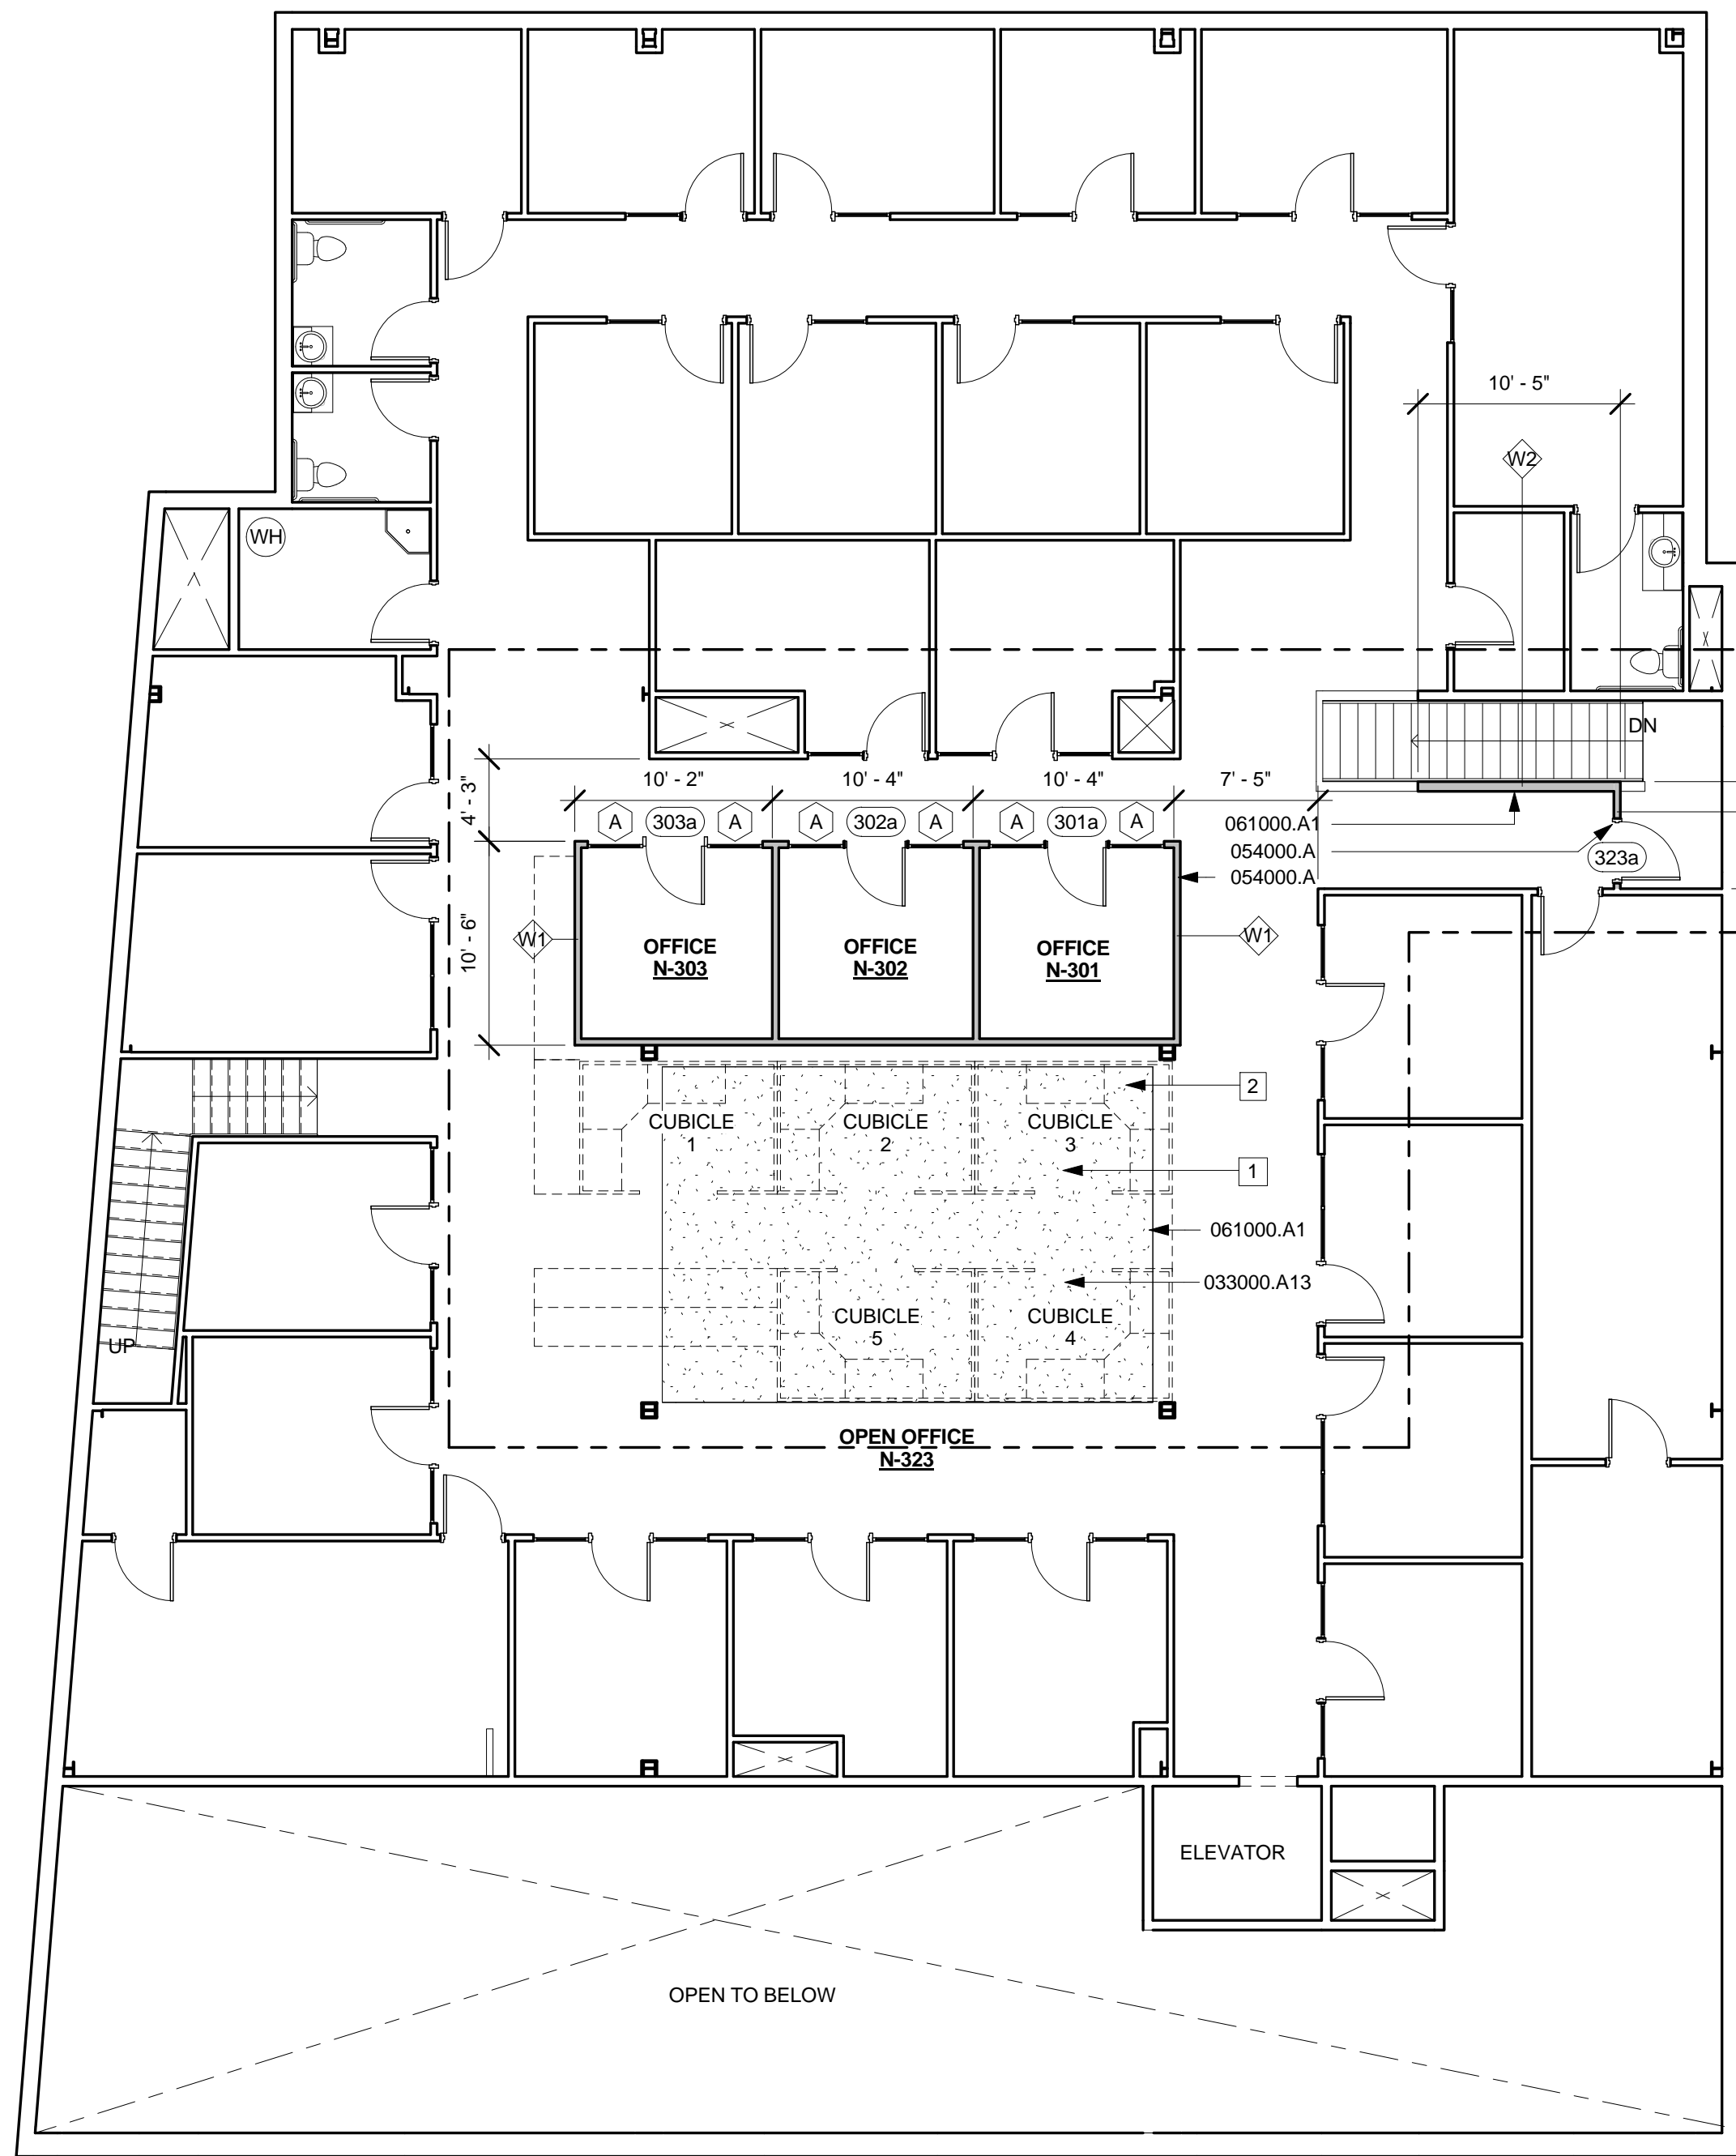

2 3RD FLOOR - OVERALL FLOOR PLAN
1/8" = 1'-0"

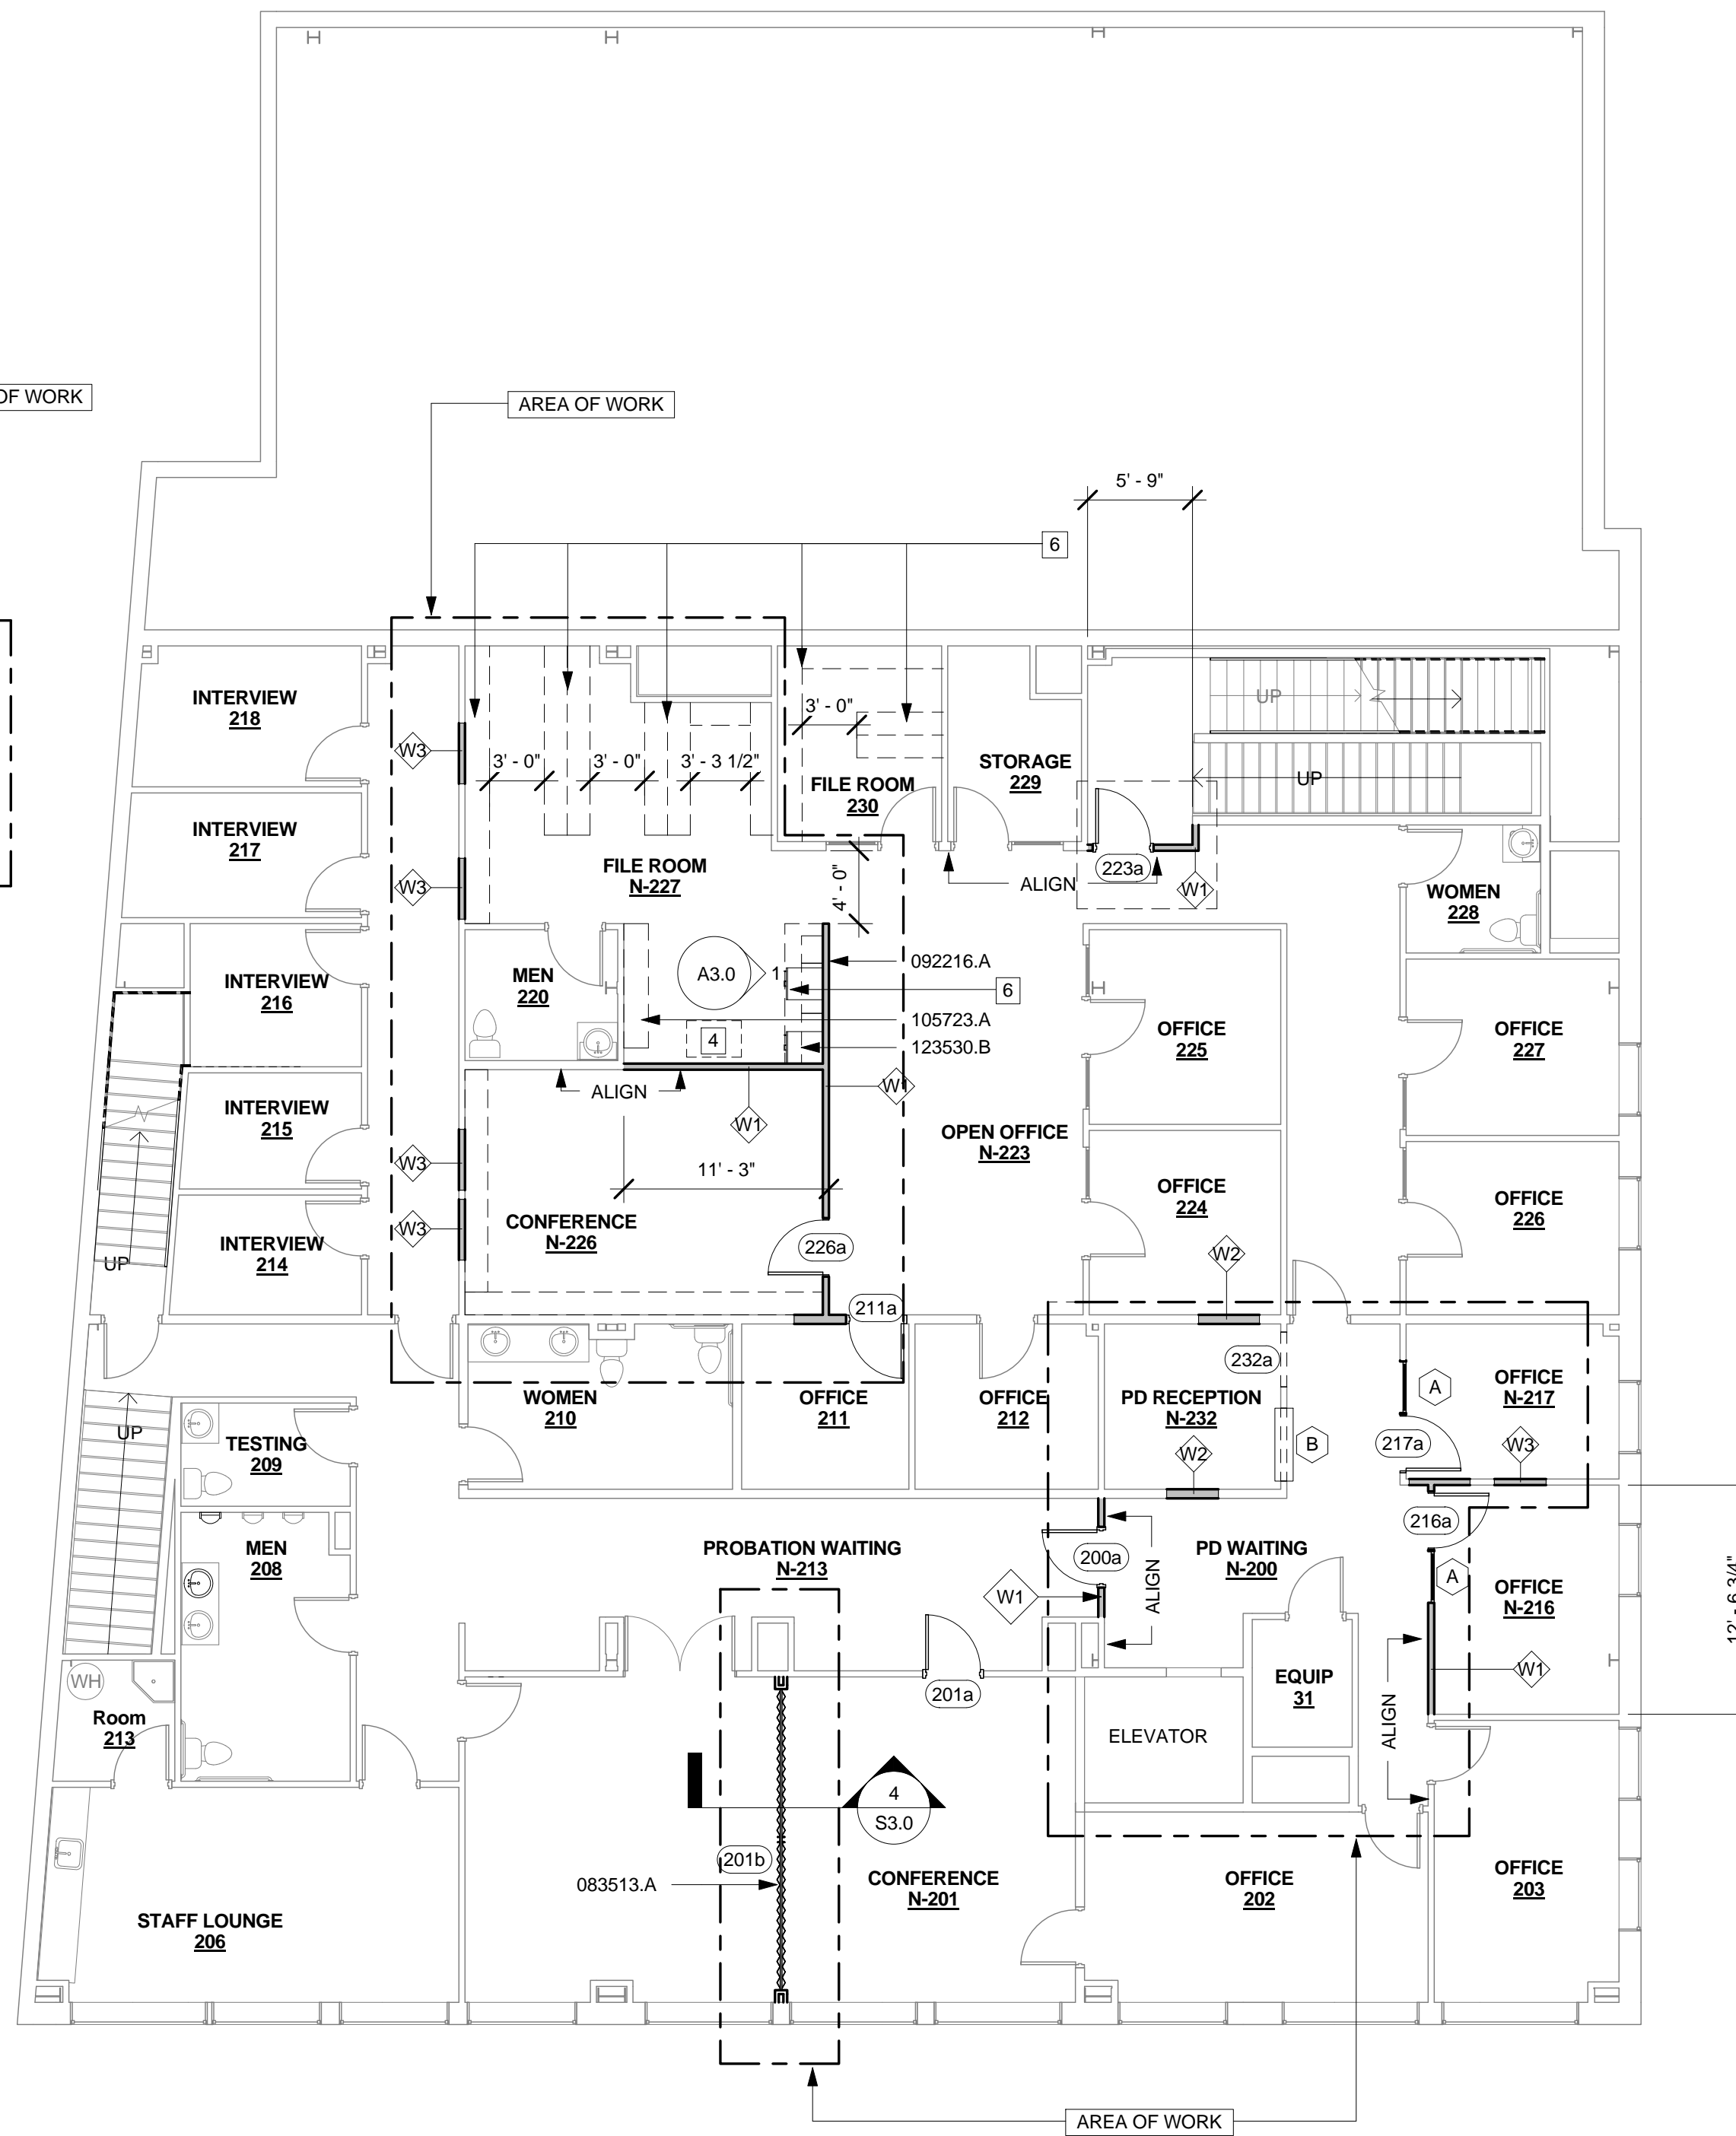

1 2ND FLOOR - OVERALL FLOOR PLAN
1/8" = 1'-0"

LEGEND

- (N) WALL LOCATION
- (E) WALL LOCATION
- ALIGN FACE OF WALL FINISHES.
- DOOR TYPE, REFER TO DOOR SCHEDULE FOR ADDITIONAL INFORMATION.
- AREA OF WORK

WALL TYPES:

- FRAMING: 3 5/8 INCH METAL STUD @ 24" O.C.
SUBSTRATE: 5/8" TYPE 'X' GYP BOARD (BOTH SIDES)
HEIGHT: 9'
INSULATION: ACOUSTICAL BATT INSULATION
SHEET NOTE:
- FRAMING: 6 INCH METAL STUD @ 24" O.C.
SUBSTRATE: 5/8" TYPE 'X' GYP BOARD (BOTH SIDES)
HEIGHT: 9'
INSULATION: ACOUSTICAL BATT INSULATION
SHEET NOTE: 3
- FRAMING: 6 INCH METAL STUD @ 24" O.C.
SUBSTRATE: 5/8" TYPE 'X' GYP BOARD (BOTH SIDES)
HEIGHT: 9'
INSULATION: ACOUSTICAL BATT INSULATION
SHEET NOTE: 5

GENERAL NOTES

- A. INSTALLATION OF FRAMING SHALL BE WIDTHS HEREIN LISTED IN WALL TYPES UNLESS SPECIFIED DIFFERENTLY BY STRUCTURAL DOCUMENTS. CONTRACTOR SHALL NOTIFY ARCHITECT OF DISCREPANCIES PRIOR TO INSTALLATION. REFER TO PLANS, SECTIONS AND DETAILS FOR STUD SIZE CHANGES FROM HEREIN SCHEDULED.
- B. REFER TO INTERIOR FINISH SCHEDULE AND LEGEND FOR FLOOR, WALL AND CEILING FINISHES.
- C. REFER TO GLAZING AND FRAME SCHEDULE ON SHEET A3.0 FOR INTERIOR AND EXTERIOR WINDOW INFORMATION.
- D. REFER TO DOOR SCHEDULE ON SHEET A3.0 FOR INTERIOR AND EXTERIOR DOOR INFORMATION.
- E. REFER TO SPECIFICATION FOR ADDITIONAL KEYNOTE SECTION INFORMATION.

DIMENSION NOTES

- A. EXTERIOR DIMENSIONS ARE MEASURED TO FACE OF STRUCTURAL SHEATHING / SLAB EDGE OR CENTERLINE OF STRUCTURE UNO
- B. INTERIOR DIMENSIONS ARE MEASURED TO FACE OF STUD, UNO
- C. DOORS AND WINDOWS ARE MEASURED TO CENTERLINE OF OPENINGS.
- D. ALL ANGLED WALLS ARE AT 45 DEGREES UNLESS NOTED OTHERWISE.
- E. SET JAMB AT HINGE SIDE OF INTERIOR DOORS @ 4" UNO

SHEET NOTES

1. NEW FLOOR INFILL AT (E) OPENING: TJI @ 12" - 16" OC W/ 1 1/8" SHEATHING, 1 1/2" LIGHTWEIGHT CONCRETE FINISH TO MATCH (E) FLOOR LEVEL.
2. FURNITURE PROVIDED BY TENANT.
3. MATCH (E) WOOD FRAMED WALL.
4. COPY MACHINE LOCATION, OWNER PROVIDED.
5. INFILL WALL TO MATCH (E)
6. SHELVES PROVIDED BY TENANT. INSTALLED BY CONTRACTOR.

KEYNOTES


- 033000.A13 CAST-IN-PLACE CONCRETE LIGHTWEIGHT
- 054000.A COLD FORM METAL FRAMING
- 061000.A1 WOOD FRAMING
- 083513.A FOLDING DOORS: ACCORDIAN DOOR
- 092216.A NON-LOAD BEARING METAL FRAMING ASSEMBLY
- 105723.A WIRE CLOSET SHELF ASSEMBLY
- 123530.B BASE CABINET



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No.	Description	Date
1	Revision 1	

Proj. No.: 2016015
Date: 08/03/2016
Scale: As indicated
Drawn By: JMT

A2.1
2ND & 3RD FLOOR
OVERALL PLANS

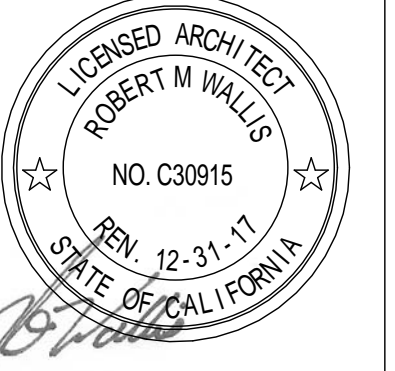WINDOW NOTES

- A. FIELD VERIFY ALL OPENINGS & DIMENSIONS PRIOR TO SHOP DRAWINGS AND FABRICATION.
- B. GLAZING WITHIN 18" OF FLOOR, OR GLAZING WITHIN 24" OF A DOOR AND LESS THAN 60" ABOVE WALKING SURFACE SHALL BE TEMPERED SAFETY GLAZING.
- C. ALL EXTERIOR GLAZING SHALL BE INSULATED GLASS UNITS WITH A MIN. OF ONE TEMPERED PANE PER 2013 CBC CHAPTER 7A.

SCHEDULE NOTE:

1. WINDOW TYPE A
2. WINDOW TYPE B
3. CASED OPENING

DOOR NOTES

- A. FIELD VERIFY ALL OPENINGS & DIMENSIONS PRIOR TO SHOP DRAWINGS AND FABRICATION.
- B. GLAZING IN DOORS SHALL BE TEMPERED SAFETY GLAZING
- C. NEW DOOR LOCKS WITH LEVER HANDLES ON ALL DOORS
- D. INSTALL NEW 10" STRIKE PLATES ON ALL DOOR JAMBS WITH DAMAGED STRIKE PLATE.

SCHEDULE NOTE:

1. DOOR TYPE A
2. SCHLAGE LEVER HANDLES - ALL NEW TO RECEIVE NEW LEVER HANDLES.
3. TM COBB OR EQUAL: FRENCH DOOR, SINGLE LITE, PAINTED
4. TM COBB OR EQUAL: FLAT PANEL SOLID WOOD, 1 3/8" THICK
5. ACCORDIAN PARTITION - MODERNFOLD OR EQUAL, VERIFY WIDTH OF OPENING

EQUIPMENT/PLUMBING NOTES

- A. N/A

SCHEDULE NOTE:

1. N/A

FINISH NOTES

- A. PROVIDE TRANSITION STRIPS AT ALL FLOORING MATERIAL CHANGES.
- B. SET FLOORING TRANSITIONS CENTERED BELOW DOOR IN CLOSED POSITION AT DOOR FRAME OPENINGS.
- C. FLOOR FINISH IS CONTINUOUS UNDER ALL COUNTERTOPS AND FIXTURES, TYPICAL.
- D. REFER TO EXTERIOR ELEVATIONS FOR EXTERIOR FINISH INFORMATION.
- E. REFER TO REFLECTIVE CEILING PLAN FOR CEILING FINISH INFORMATION.
- F. 4" RUBBER COVE BASE THROUGHOUT

SCHEDULE NOTE:

1. INSTALL THRESHOLD FULL DEPTH OF JAMB.
2. FURNISH AND INSTALL 4 INCH BACK SPLASH AT COUNTERTOPS, TYPICAL
3. "WET" WALLS TO BE COVERED WITH 48" TALL FRP U.N.O.
4. CARPET RUNNER AT STAIR #1& #2 INSTALLED IN MIDDLE OF TREADS TO MATCH (E) TREADS.
5. INCLUDE FLOOR PREP AT CARPET FLOOR TILES PER MANUFACTURER'S RECOMMENDATIONS. USE MANUFACTURER'S RECOMMENDED CARPET FLOOR TILE ADHESIVE.
6. STANDARD FLOOR PREP: CLEAN & FLOAT OUT AREAS TO PROVIDE SMOOTH TRANSITIONS. NO UNDERLAYMENT REQUIRED, USE MANUFACTURER'S RECOMMENDATIONS.
7. KITCHEN & BATHROOMS
8. ALL INTERIOR WALL SURFACES U.N.O.
9. INSTALL AT (E) BASEBOARD, U.N.O.

CASEWORK NOTES

- A. MATCH (E) CABINET WORK



SCHEDULE NOTE:

1. x

Schedule - Windows							
Window Mark	Style	Size	Detail			Refer to Sched. Note:	
			Head	Jamb	Sill		
A	Sidelights 1	3068				1	
B	Window-Square Opening	40310				1	

FRAME TYPES

- BASIS OF DESIGN - KNOCK DOWN FRAME
TIMELY A DIVISION OF S.D.S INDUSTRIES, INC
1. WINDOW & DOOR FRAME
 2. CASING

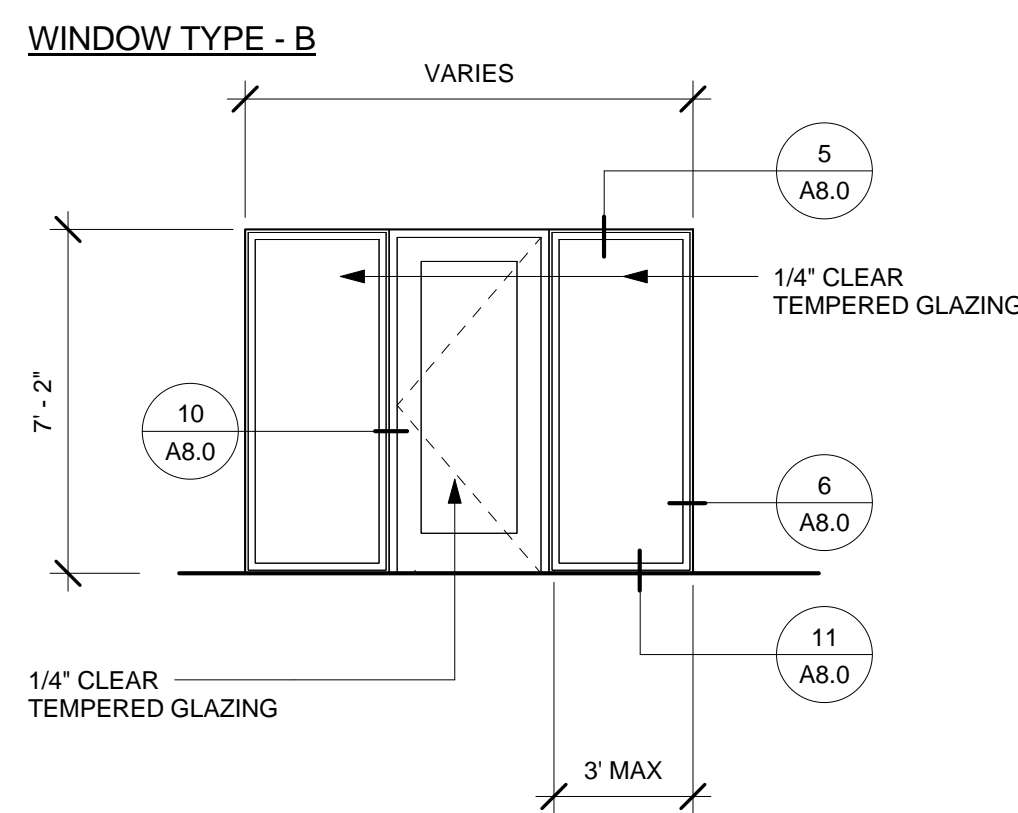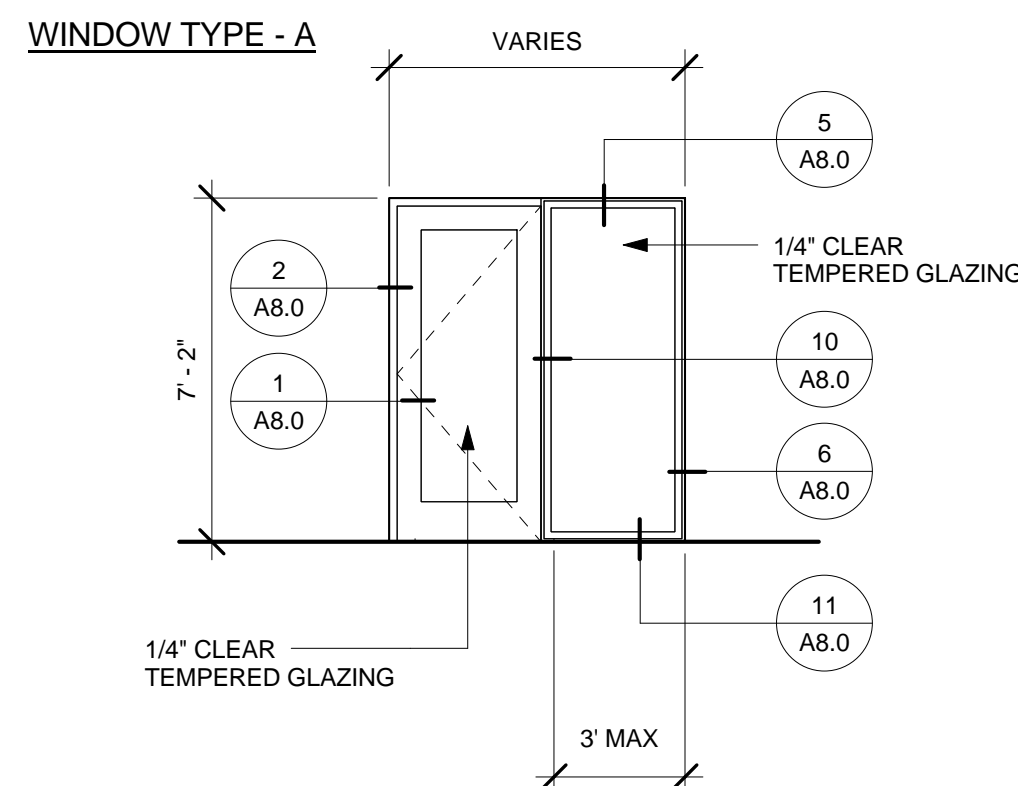


Schedule - Doors							
Door #	Family	Door Size	Material	Details			Refer to Sched Note:
				Head	Jamb	Sill	
200a	Single Door	3068	wd	1/A8.0	2/A8.0	3/A8.0	1,2,4
201a	Single Door	3068	wd	1/A8.0	2/A8.0	3/A8.0	1,2,4
201b	Accordion Partition	Paired 9' tall					5
211a	Single Door	3068	wd	1/A8.0	2/A8.0	3/A8.0	1,2,4
216a	Single Full Lite	3068	wd	1/A8.0	2/A8.0	3/A8.0	1,2,3
217a	Single Full Lite	3068	wd	1/A8.0	2/A8.0	3/A8.0	1,2,3
223a	Single Full Lite	3068	wd	1/A8.0	2/A8.0	3/A8.0	1,2,4
226a	Single Full Lite	3068	wd	1/A8.0	2/A8.0	3/A8.0	1,2,3
232a	Opening	3068					
301a	Single Full Lite	3068	wd	1/A8.0	2/A8.0	3/A8.0	1,2,3
302a	Single Full Lite	3068	wd	1/A8.0	2/A8.0	3/A8.0	1,2,3
303a	Single Full Lite	3068	wd	1/A8.0	2/A8.0	3/A8.0	1,2,3
323a	Single Door	3068	wd	1/A8.0	2/A8.0	3/A8.0	1,2,4

FRAME TYPES

- BASIS OF DESIGN - KNOCK DOWN FRAME
TIMELY A DIVISION OF S.D.S INDUSTRIES, INC
1. WINDOW & DOOR FRAME
 2. CASING

DOOR TYPE - A

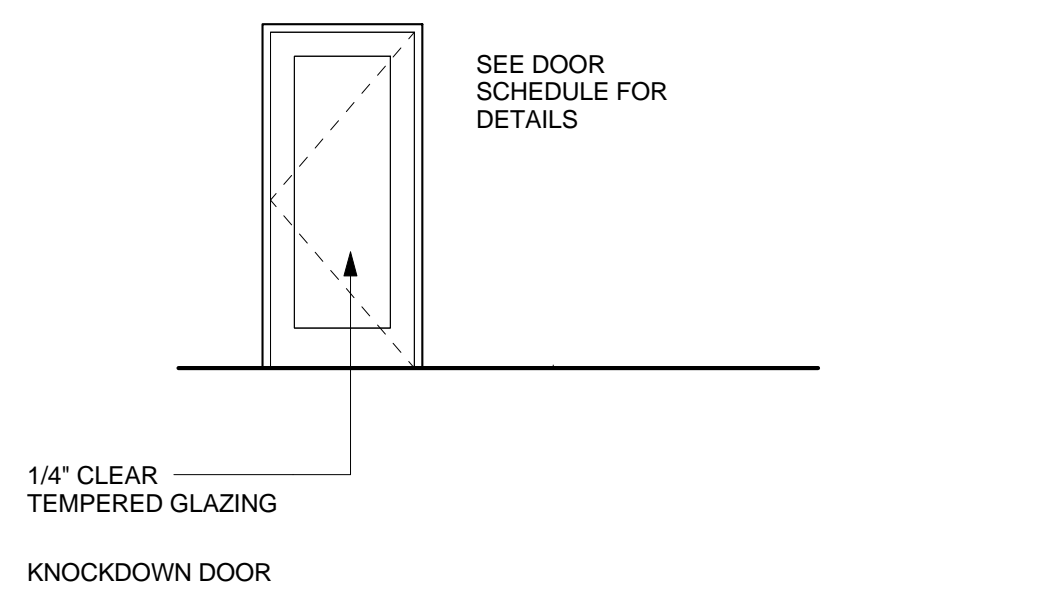

KNOCKDOWN DOOR

Schedule - Room Finishes							
Room Name	Room #	Finish				Refer to Sheets Notes:	
		Floor	Base	Wall	Ceiling		
PD WAITING	N-200	F2	B1	P1			
CONFERENCE	N-201	F1	B1	P1			
PROBATION WAITING	N-213	F2	B1	P1			
OFFICE	N-216	F1	B1	P1			
OFFICE	N-217	F1	B1	P1			
OPEN OFFICE	N-223	F1	B1	P1			
CONFERENCE	N-226	F1	B1	P1			
FILE ROOM	N-227	F1	B1	P1			
PD RECEPTION	N-232	F2	B1	P1			
OFFICE	N-301	F1	B1	P1			
OFFICE	N-302	F1	B1	P1			
OFFICE	N-303	F1	B1	P1			
OPEN OFFICE	N-323	F1	B1	P1			



FINISH LEGEND

FLOORING:

- F1 MANUFACTURE: MATCH (E)
PRODUCT: CARPET MATCH (E)
COLOR: TBD
SIZE: TBD
PATTERN: TBD
SCHED NOTES:

- F2 MANUFACTURE: MATCH (E)
PRODUCT: VINYL MATCH (E)
COLOR: TBD
SIZE: TBD
PATTERN: TBD
SCHED NOTES:

PAINT:

- P1 MANUFACTURE: PITTSBURGH PAINTS
PRODUCT: MANOR HALL
COLOR: TBD
FINISH: SATIN SHEEN
SCHED NOTES:
- P2 MANUFACTURE: PITTSBURGH PAINTS
PRODUCT: MANOR HALL
COLOR: TBD
FINISH: SEMIGLOSS
SCHED NOTES:


BASE:

- B1 MANUFACTURE: MATCH (E)
PRODUCT: 4" RUBBER COVE, MATCH (E) BASE
COLOR: TBD
SIZE: 4"
FINISH: TBD
SCHED NOTES:


COUNTERTOPS/CABINETS:

- L1 MANUFACTURE: TBD
PRODUCT: PLASTIC LAMINATE
COLOR: TBD
SIZE: TBD
SCHED NOTES: 2

Schedule - Casework							
Mark	Description	Width	Height	Depth	CDS	Finish	Sheet Notes
02	Base Cabinet w/ Drawers	1' - 9"	2' - 10 1/2"	2' - 0"	211	L1	
03	Base Cabinet w/ Drawers	1' - 9"	2' - 10 1/2"	2' - 0"	211	L1	
04	Base Cabinet w/ Drawers	1' - 9"	2' - 10 1/2"	2' - 0"	211	L1	
05	Wall Hung Cabinet	1' - 6"	3' - 0"	1' - 2"	301	L1	
06	Wall Hung Cabinet	2' - 9"	3' - 0"	1' - 2"	302	L1	
07	Wall Hung Cabinet	2' - 9"	3' - 0"	1' - 2"	302	L1	

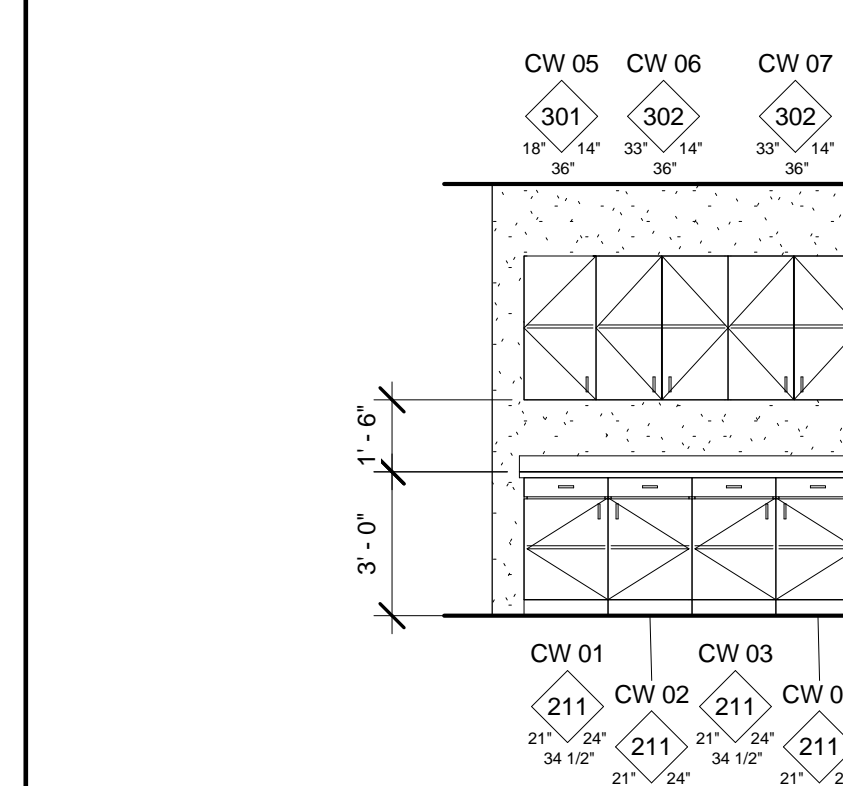

- 1 FILE ROOM
1/4" = 1'-0"

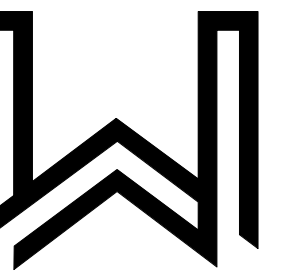


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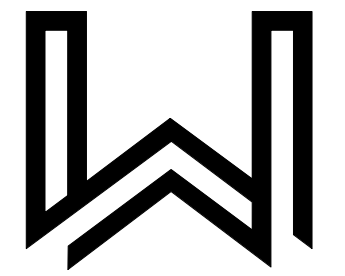
Nevada County Facilities Department
NEVADA COUNTY PROBATION DEPARTMENT & PUBLIC DEFENDER
109 1/2 Pine Street
Nevada City, CA 95959
APN: 05-570-04

No.	Date	Description

Proj. No.: 2016015
Date: 08/03/2016
Scale: As indicated
Drawn By: JMT

A3.0

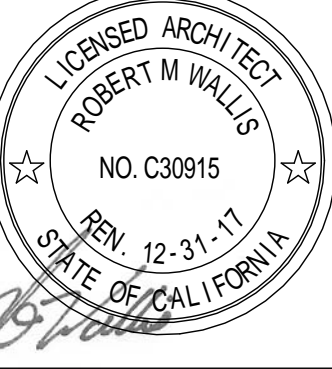SCHEDULES




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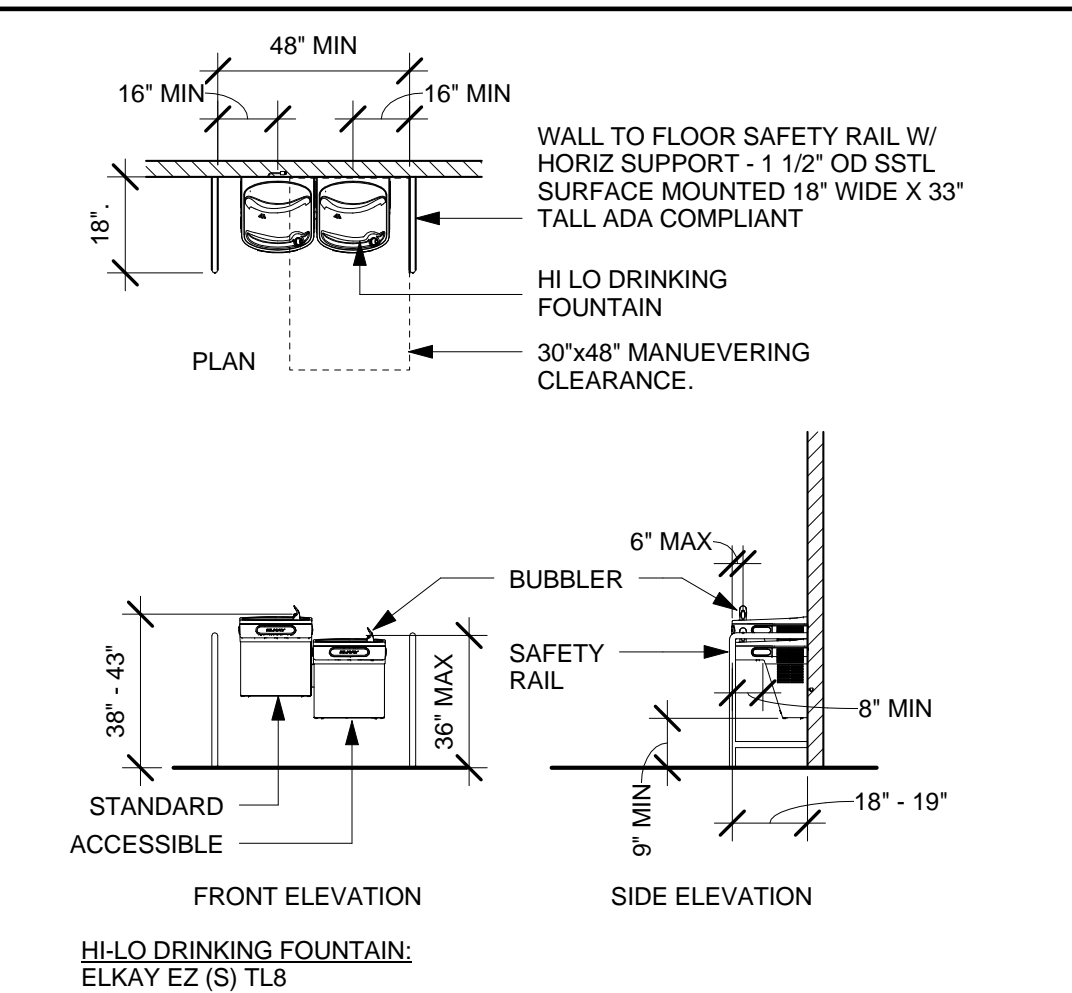
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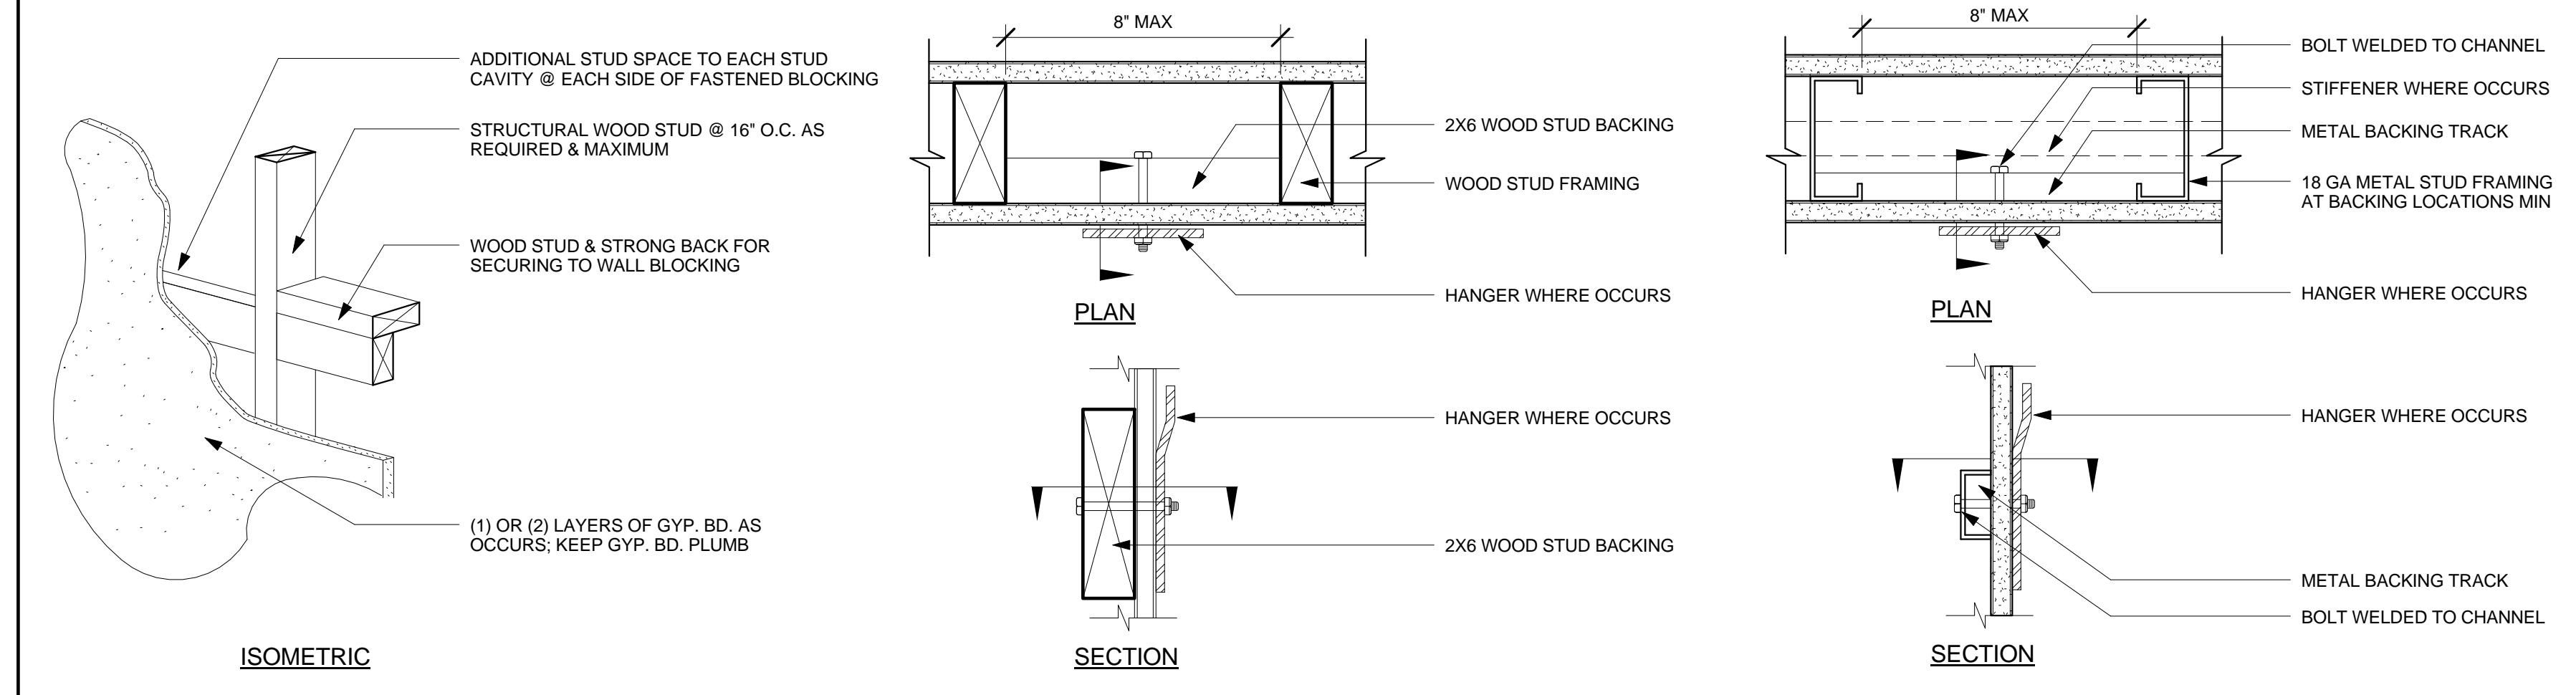
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CONSTRUCTION DOCUMENTS



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1 MOUNTING HEIGHTS AND ACCESSORIES
1/4" = 1'-0"




10 BACKING DETAILS
3\"/>

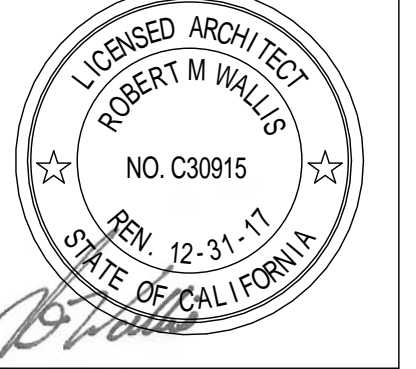


12 MOUNTING HEIGHTS AND ACCESSORIES
1/4\"/>

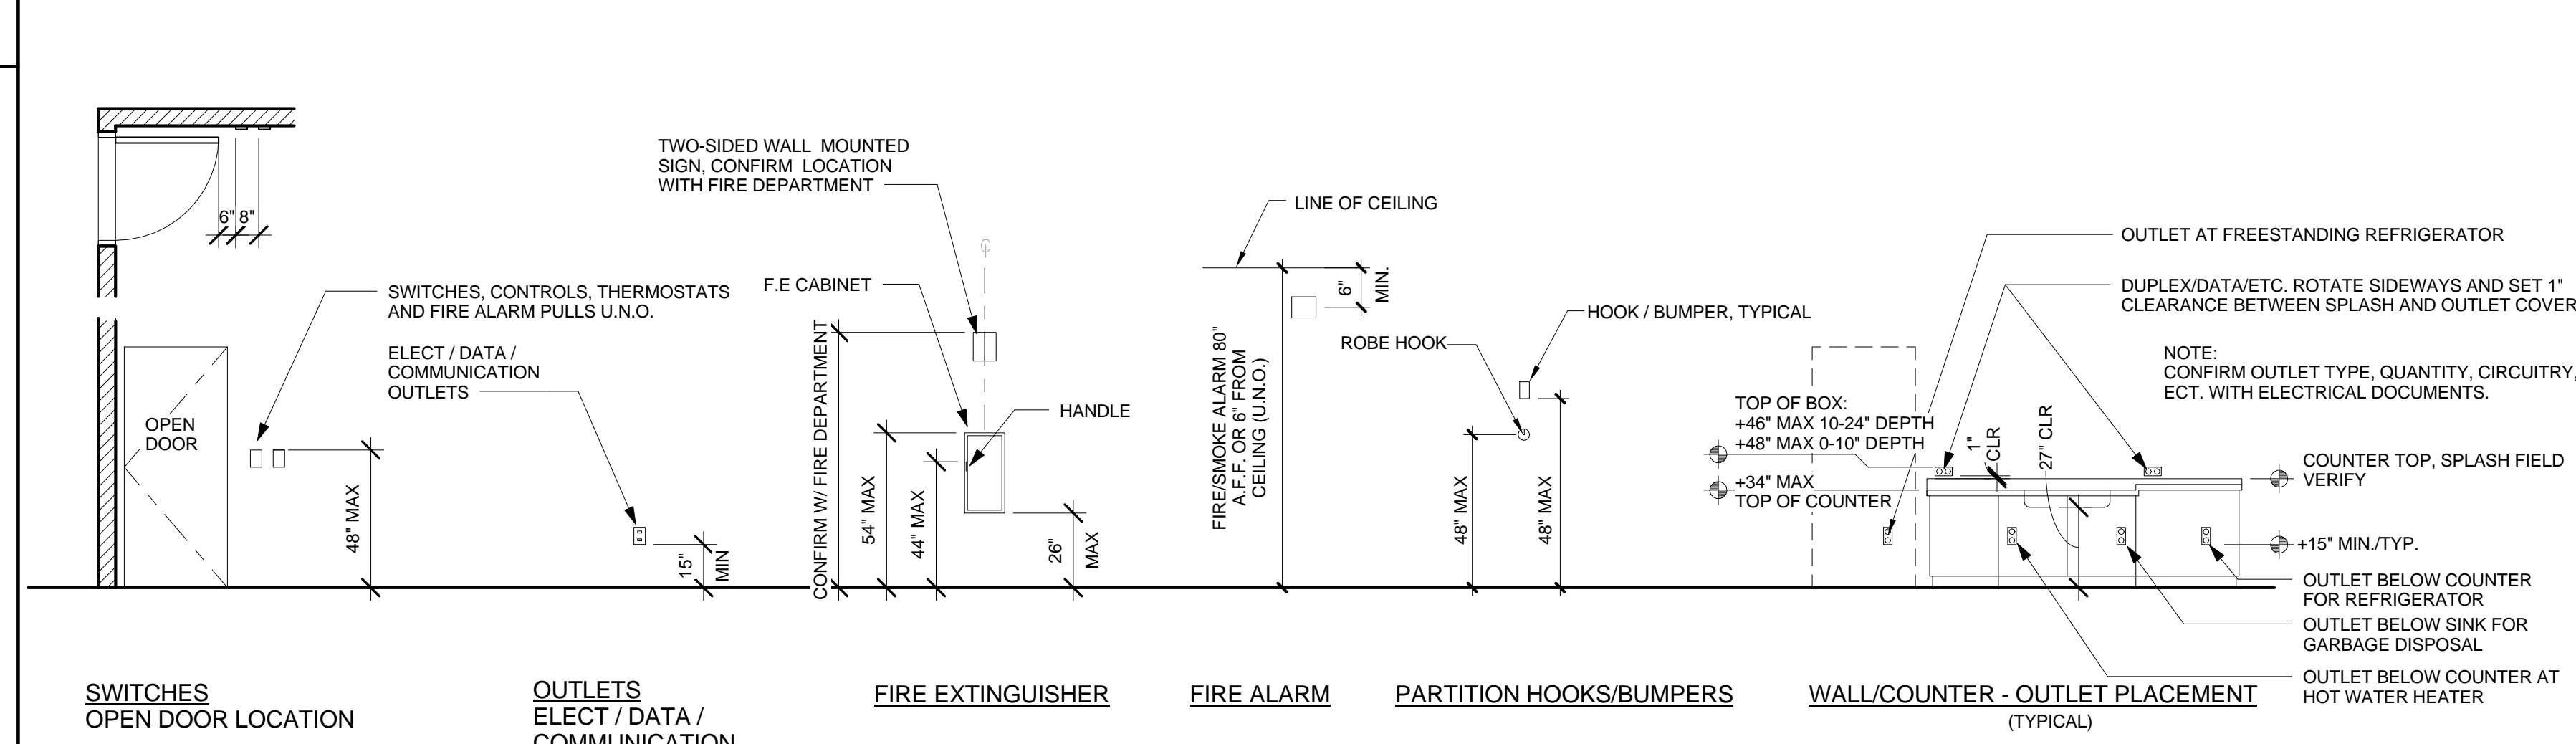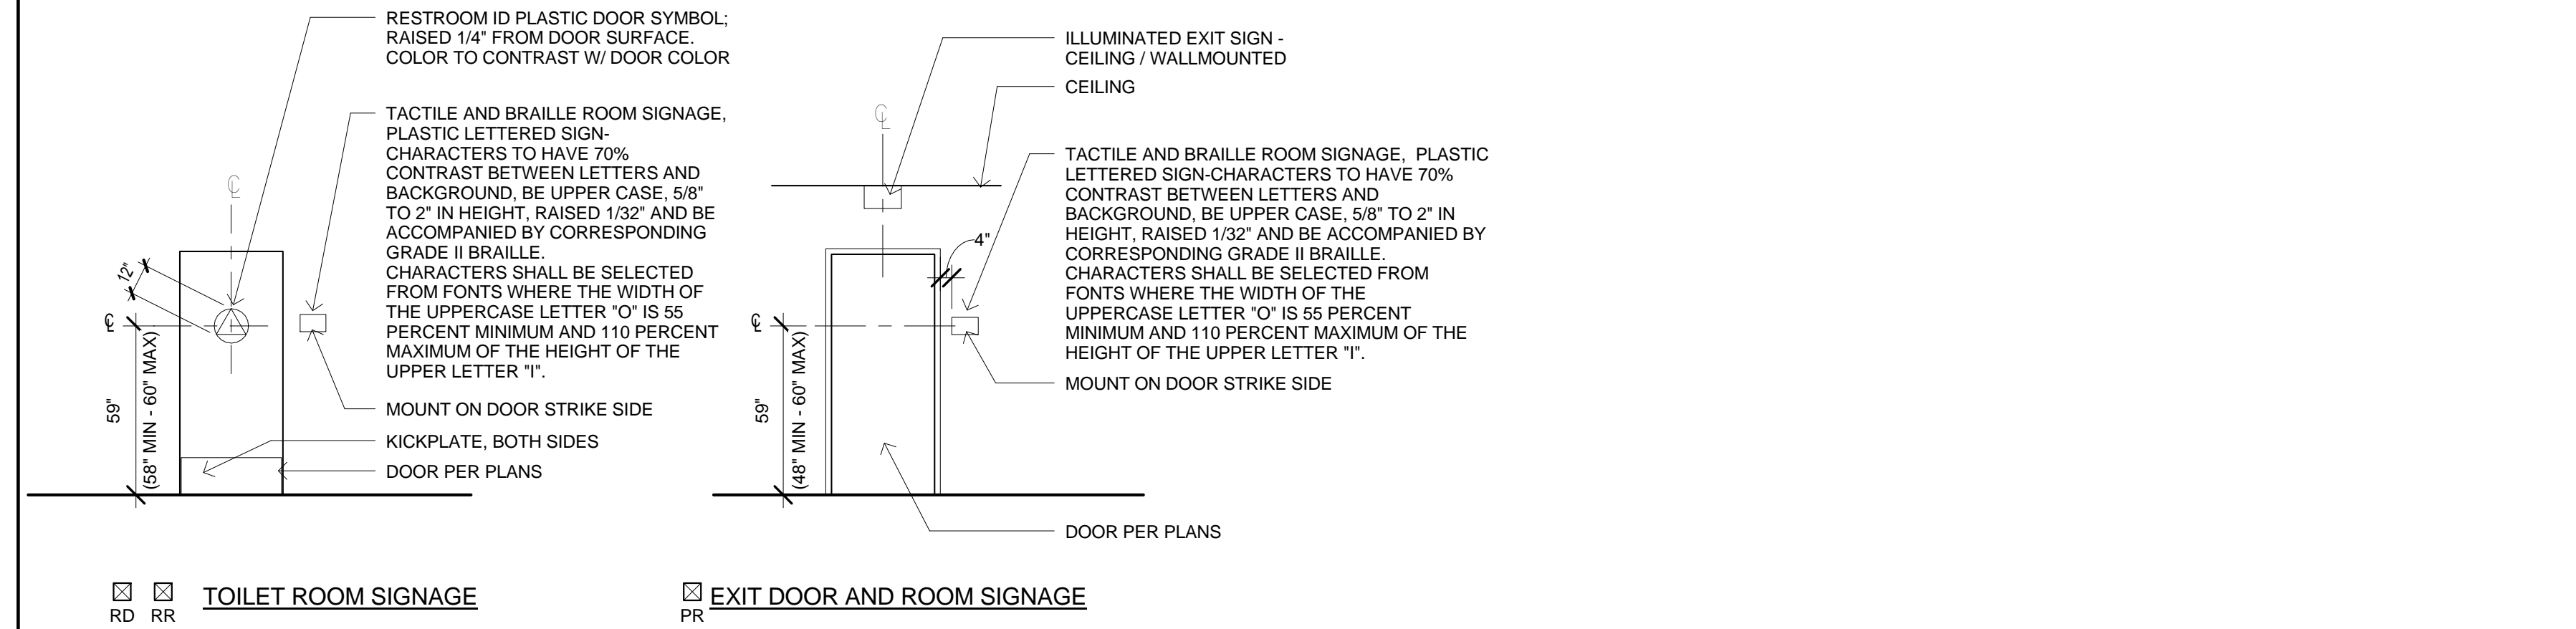No.	Date	Description

Proj. No.: 2016015
Date: 08/03/2016
Scale: As indicated
Drawn By: JMT

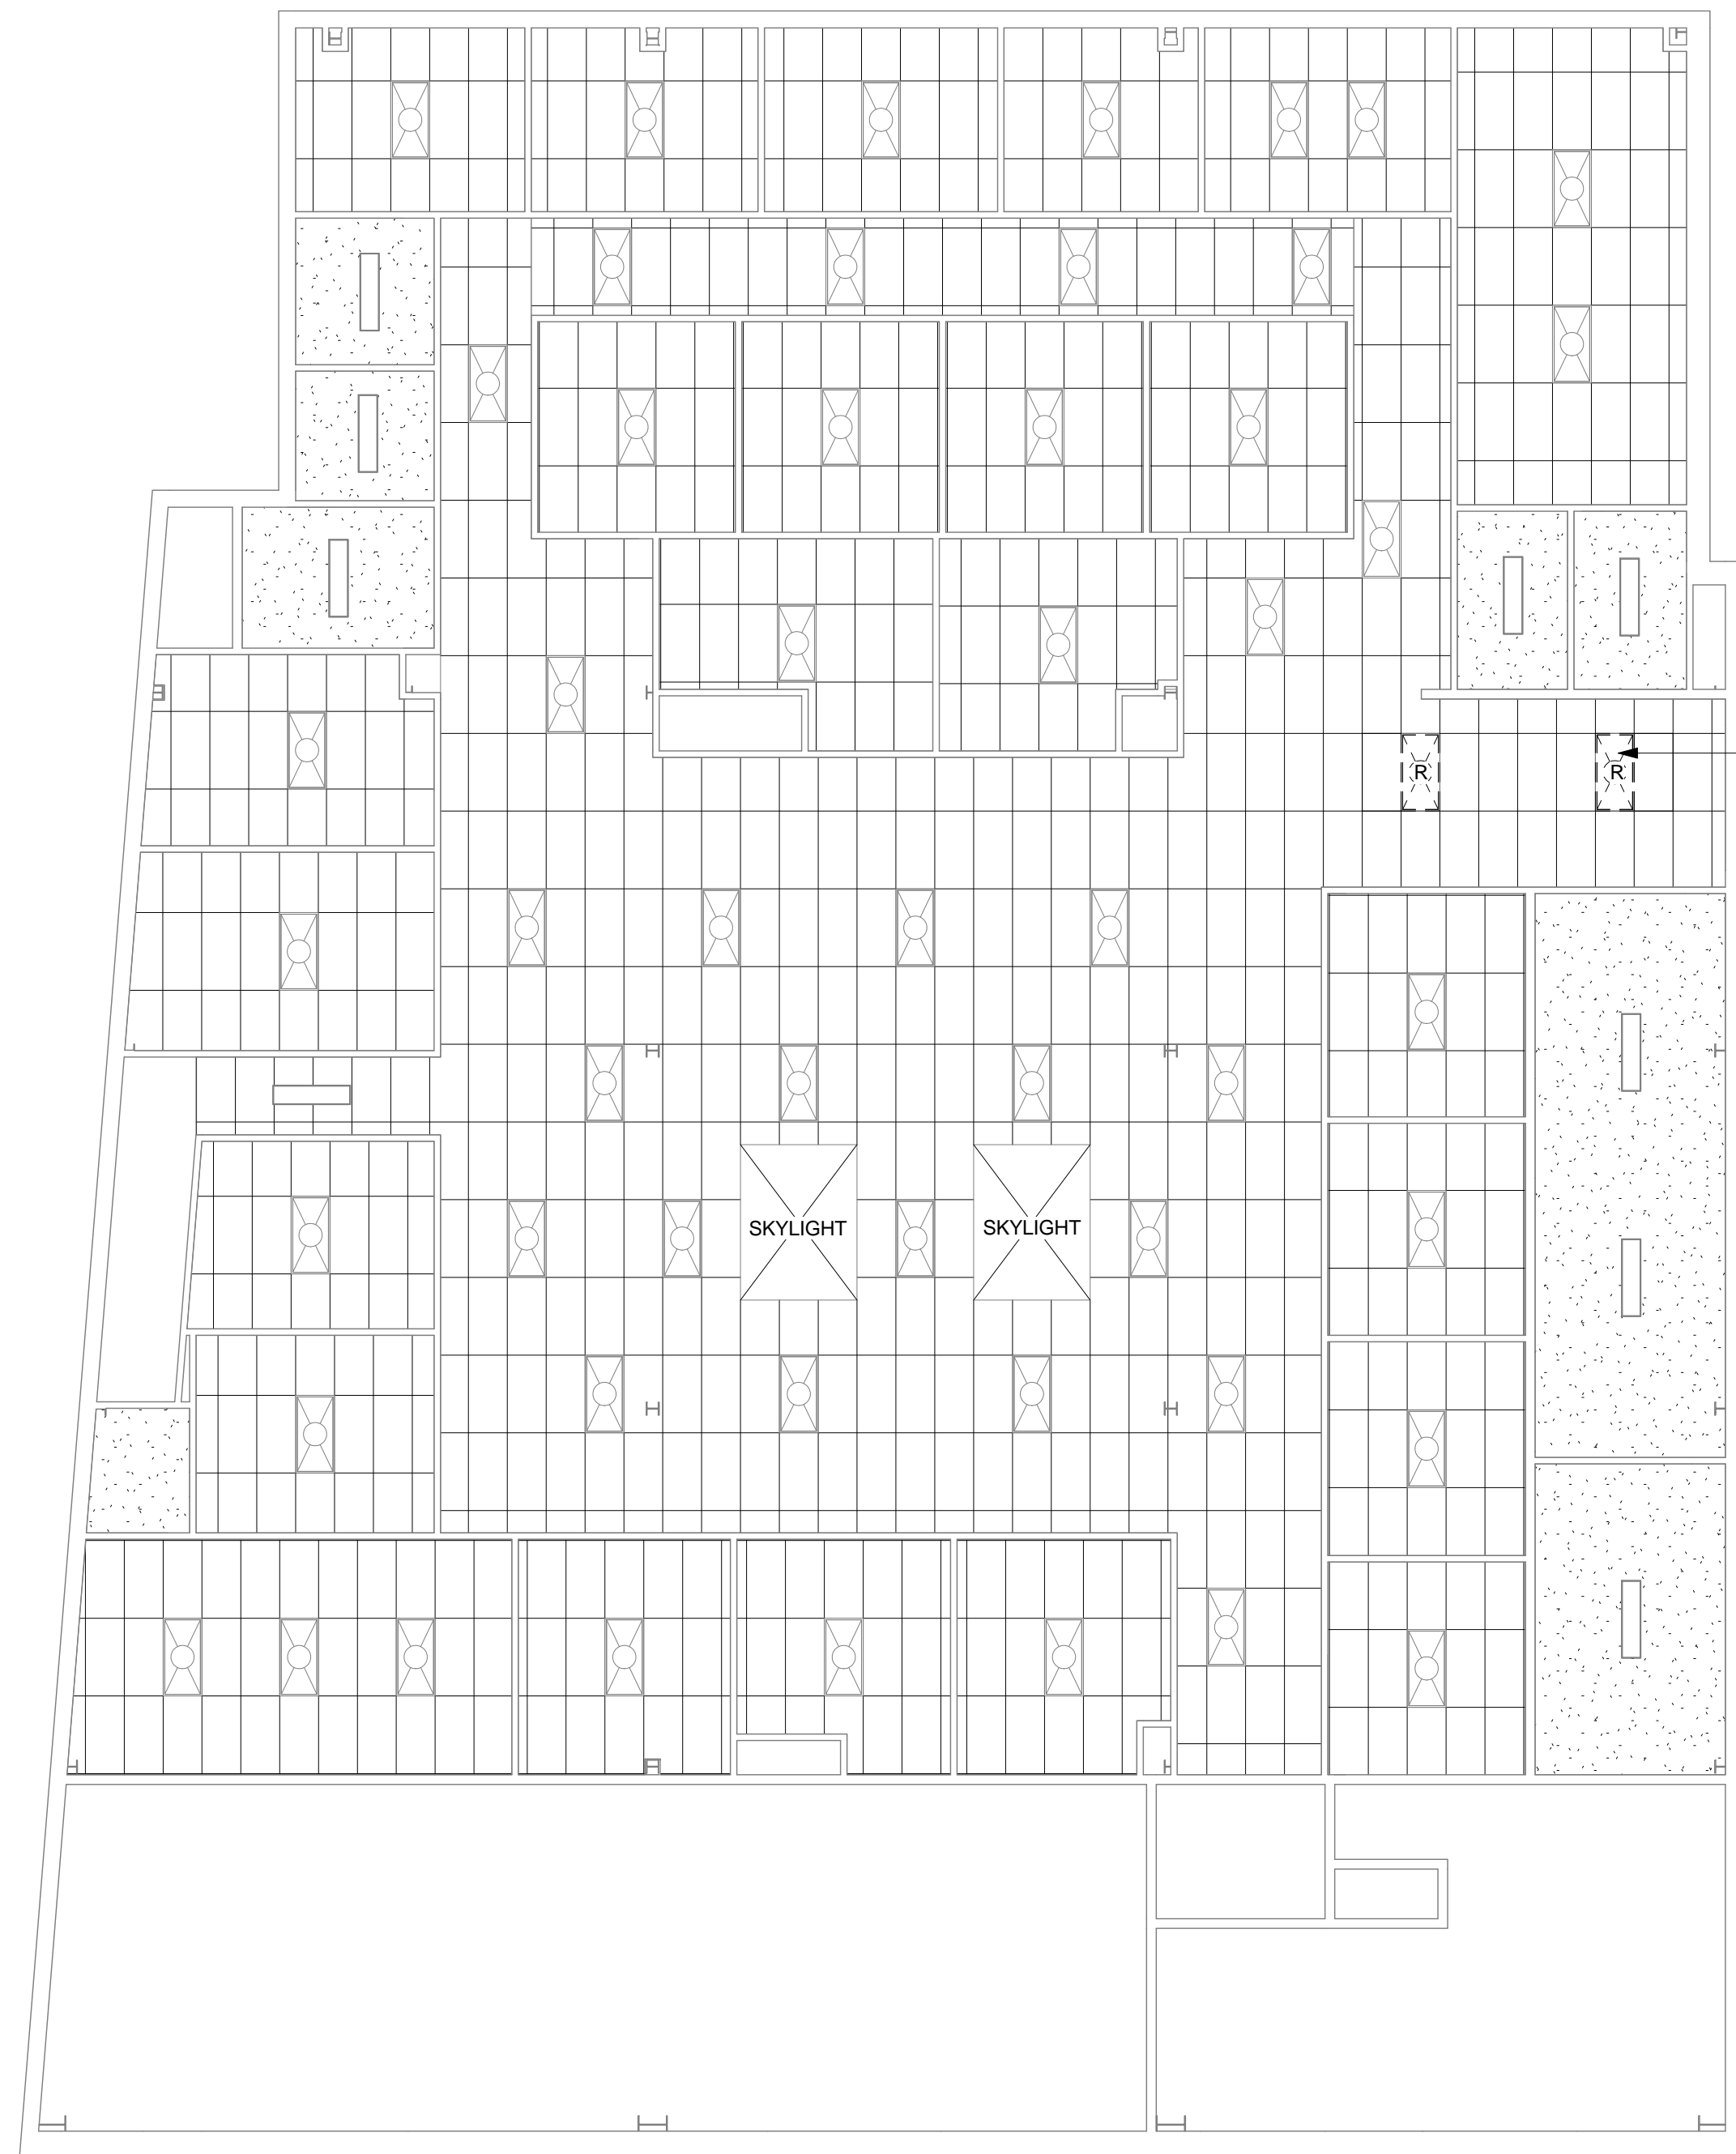

LIGHTING FIXTURES:
(E) TOTAL = 42

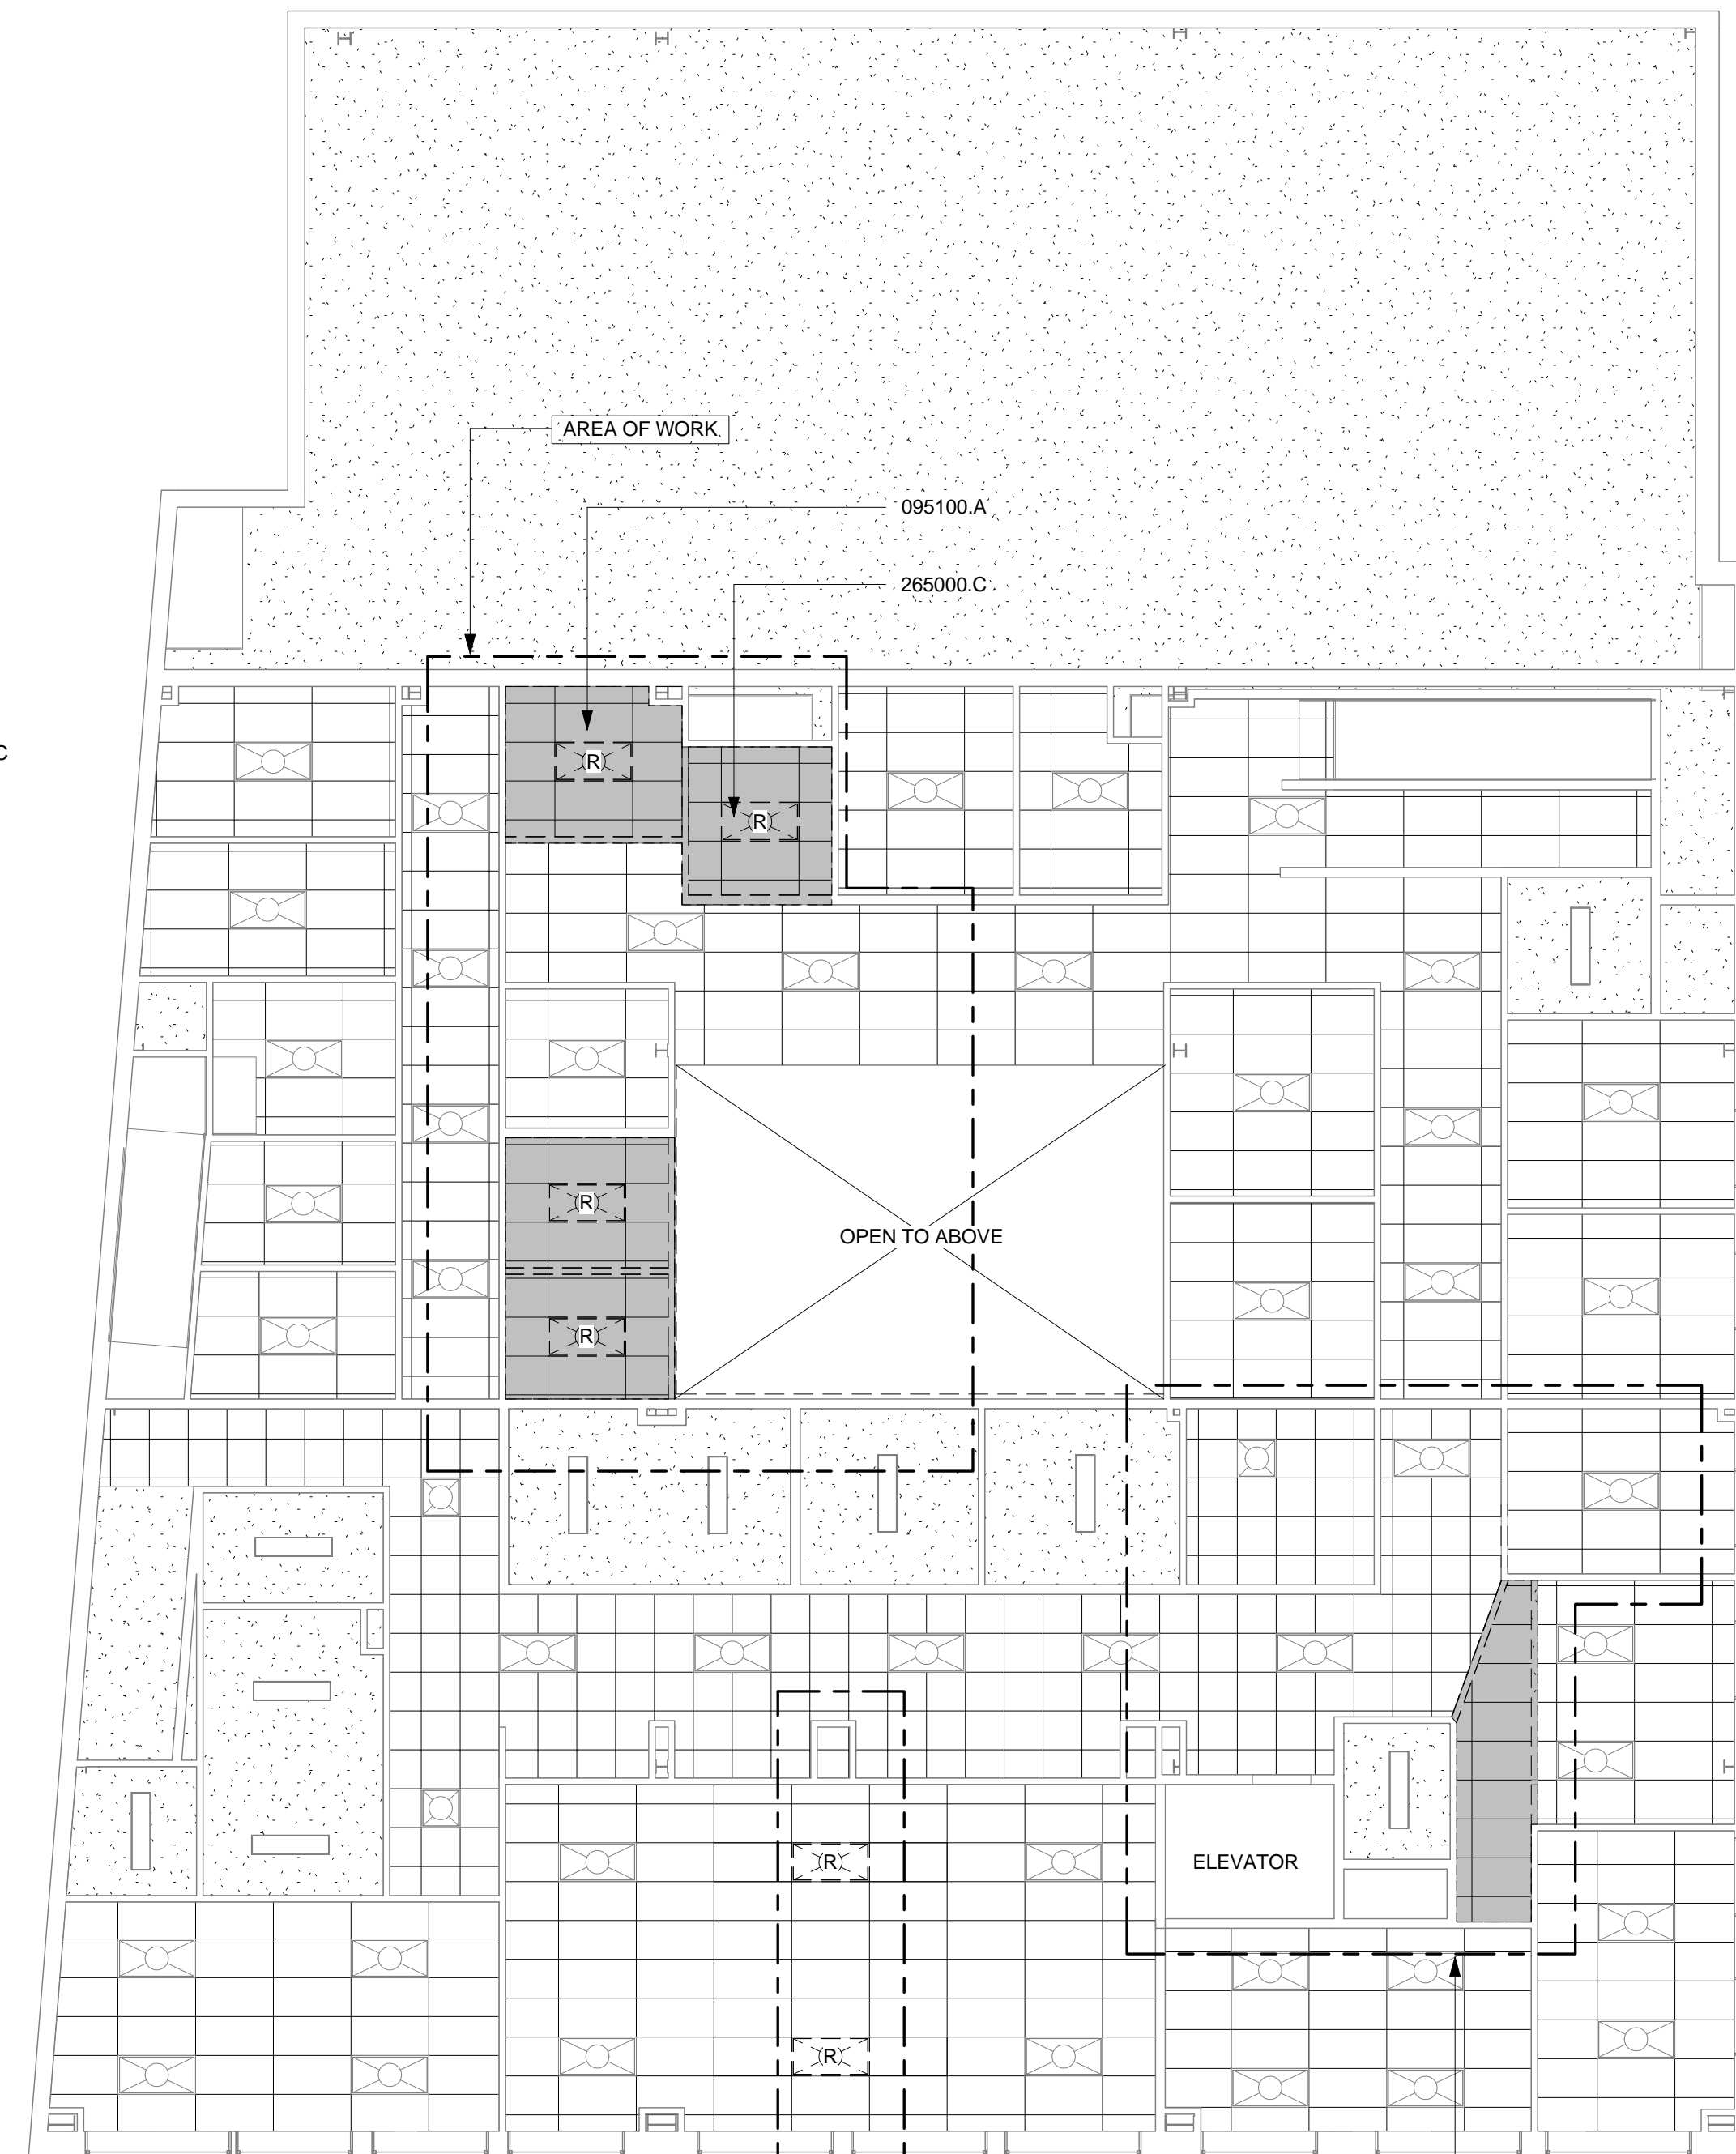

LIGHTING FIXTURES:
(E) TOTAL = 61

② 3RD FLOOR - EXISTING/DEMO CEILING
PLAN
1/8" = 1'-0"

① 2ND FLOOR - EXISTING/DEMO CEILING
PLAN
1/8" = 1'-0"

LEGEND

NOTE: ALL CEILING CONSTRUCTION & FIXTURES ARE (E) & TO REMAIN UNLESS AS NOTED BELOW.

- GYPSUM BOARD CEILING, TYPICAL
- SUSPENDED ACOUSTICAL CEILING LOCATION
- ILLUMINATED EXIT SIGN, BATTERY BACK-UP TYPICAL
- ILLUMINATED EXIT DIRECTIONAL SIGN, BATTERY BACK-UP.
- EMERGENCY EGRESS LIGHTING, CEILING MOUNTED
- EMERGENCY EGRESS LIGHTING, WALL MOUNTED
- LIGHT FIXTURE - DOWNLIGHT - RECESSED IN CEILING
- 2X4 TROFFER LIGHT
- RETURN AIR DIFFUSER LOCATION
- SUPPLY AIR DIFFUSER LOCATION
- EXHAUST FAN
- RELOCATED FIXTURE (SEE NEW CEILING PLAN FOR PLACEMENT)
- REMOVED & STORED FIXTURE

GENERAL NOTES


- A. LAYOUT OF SUSPENDED FIXTURES & RECESSED FIXTURES ARE EXISTING AND TO REMAIN U.N.O.
- B. EXIT SIGNS, TO REMAIN U.N.O. REFER TO EXISTING PLANS AND ELECTRICAL DOCUMENTS.

SHEET NOTES

- 1. NOT USED

KEYNOTES

- 095100.A ACOUSTICAL PANEL ASSEMBY
- 265000.C SUSPENDED LIGHT FIXTURES

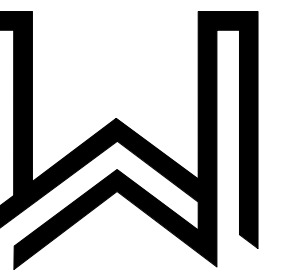


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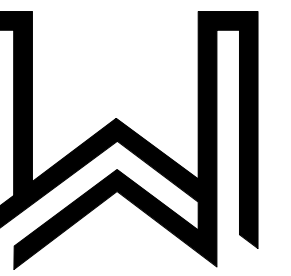
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A6.0

EXISTING & DEMOLITION
CEILING PLANS




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A6.1
 CEILING PLANS

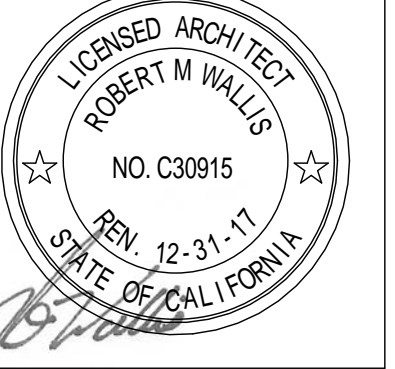LEGEND

- GYPSUM BOARD CEILING, TYPICAL
- EXISTING SUSPENDED ACOUSTICAL CEILING LOCATION
- NEW SUSPENDED ACOUSTICAL CEILING LOCATION 5
A6.2
- ILLUMINATED EXIT SIGN, BATTERY BACK-UP TYPICAL
- ILLUMINATED EXIT DIRECTIONAL SIGN, BATTERY BACK-UP.
- EMERGENCY EGRESS LIGHTING, CEILING MOUNTED
- EMERGENCY EGRESS LIGHTING, WALL MOUNTED
- LIGHT FIXTURE - DOWNLIGHT - RECESSED IN CEILING
- 2X4 TROFFER LIGHT
- RELOCATED 2X4 TROFFER LIGHT
- NEW 2X4 TROFFER LIGHT
- RETURN AIR DIFFUSER LOCATION
- SUPPLY AIR DIFFUSER LOCATION
- EXHAUST FAN

CEILING FINISHES

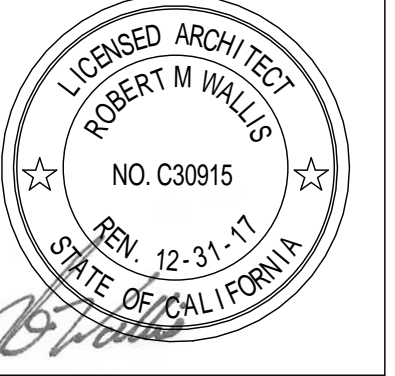
- AP-1 ACOUSTICAL CEILING TILE, TYPICAL
MSF: MATCH (E)
STYLE: MATCH (E)
SIZE: MATCH (E)
- CSS-1 ACOUSTICAL CEILING GRID ASSEMBLY, TYPICAL
MSF: MATCH (E)
TYPE: T BAR

GENERAL NOTES


- A. LAYOUT OF SUSPENDED FIXTURES & RECESSED FIXTURES, REFER TO ELECTRICAL DOCUMENTS.
- B. ILLUMINATED EXIT SIGNS SHALL BE CENTERED ABOVE DOOR OPENINGS, UNO.
- C. EXIT ROUTE SIGNAGE SHALL BE WALL MOUNTED ADJACENT TO DOOR AND/OR PASSAGE WAY OPENING AT ALL LOCATIONS PROVIDED WITH AN ILLUMINATED EXIT SIGN.
- D. ELECTRICAL AND MECHANICAL CONTRACTORS SHALL COORDINATED FIXTURE AND DIFFUSER LOCATIONS, ALL CONFLICTS SHALL BE REVIEWED BY ARCHITECT.
- E. ELECTRICAL AND MECHANICAL CONTRACTORS SHALL COORDINATED FIXTURE AND DIFFUSER LOCATIONS WITH SPRINKLER HEAD LOCATIONS, ALL CONFLICTS SHALL BE REVIEWED BY ARCHITECT.
- F. ACOUSTICAL TILE CEILING LAYOUT SHALL BE COORDINATED WITH SUSPENDED INDIRECT/DIRECT LIGHTING FIXTURES.
- G. VERTICAL MEMBERS OF SOFFITS SHALL BE PAINTED THE SAME COLOR AS HORIZONTAL SURFACE, UNO.
- H. AT NEW CEILING LOCATION CENTER T-GRID WITHIN ROOMS, UNO.
- I. EXIT SIGNS, REFER TO EXITING PLANS AND ELECTRICAL DOCUMENTS.
- J. TYPICAL ACOUSTICAL CEILING HEIGHT IS 10'-0" AFF, UNO.
- K. SUSPENDED T-BAR CEILING AREA NOT TO EXCEED 2,500 SF WITHOUT AN EXPANSION JOINT. JOINT LOCATION TO BE DETERMINE BY CONTRACTOR IN FIELD. SEE DETAILS.
- L. (N) AND (R) FIXTURES TO USE EXISTING CIRCUITRY, UNO.

SHEET NOTES


1. NEW ACCORDIAN PARTITION, MOVE (E) LIGHT FIXTURES AND ADD NEW FIXTURES AS SHOWN.
2. NEW WALL, MOVE (E) LIGHT FIXTURES AS SHOWN.

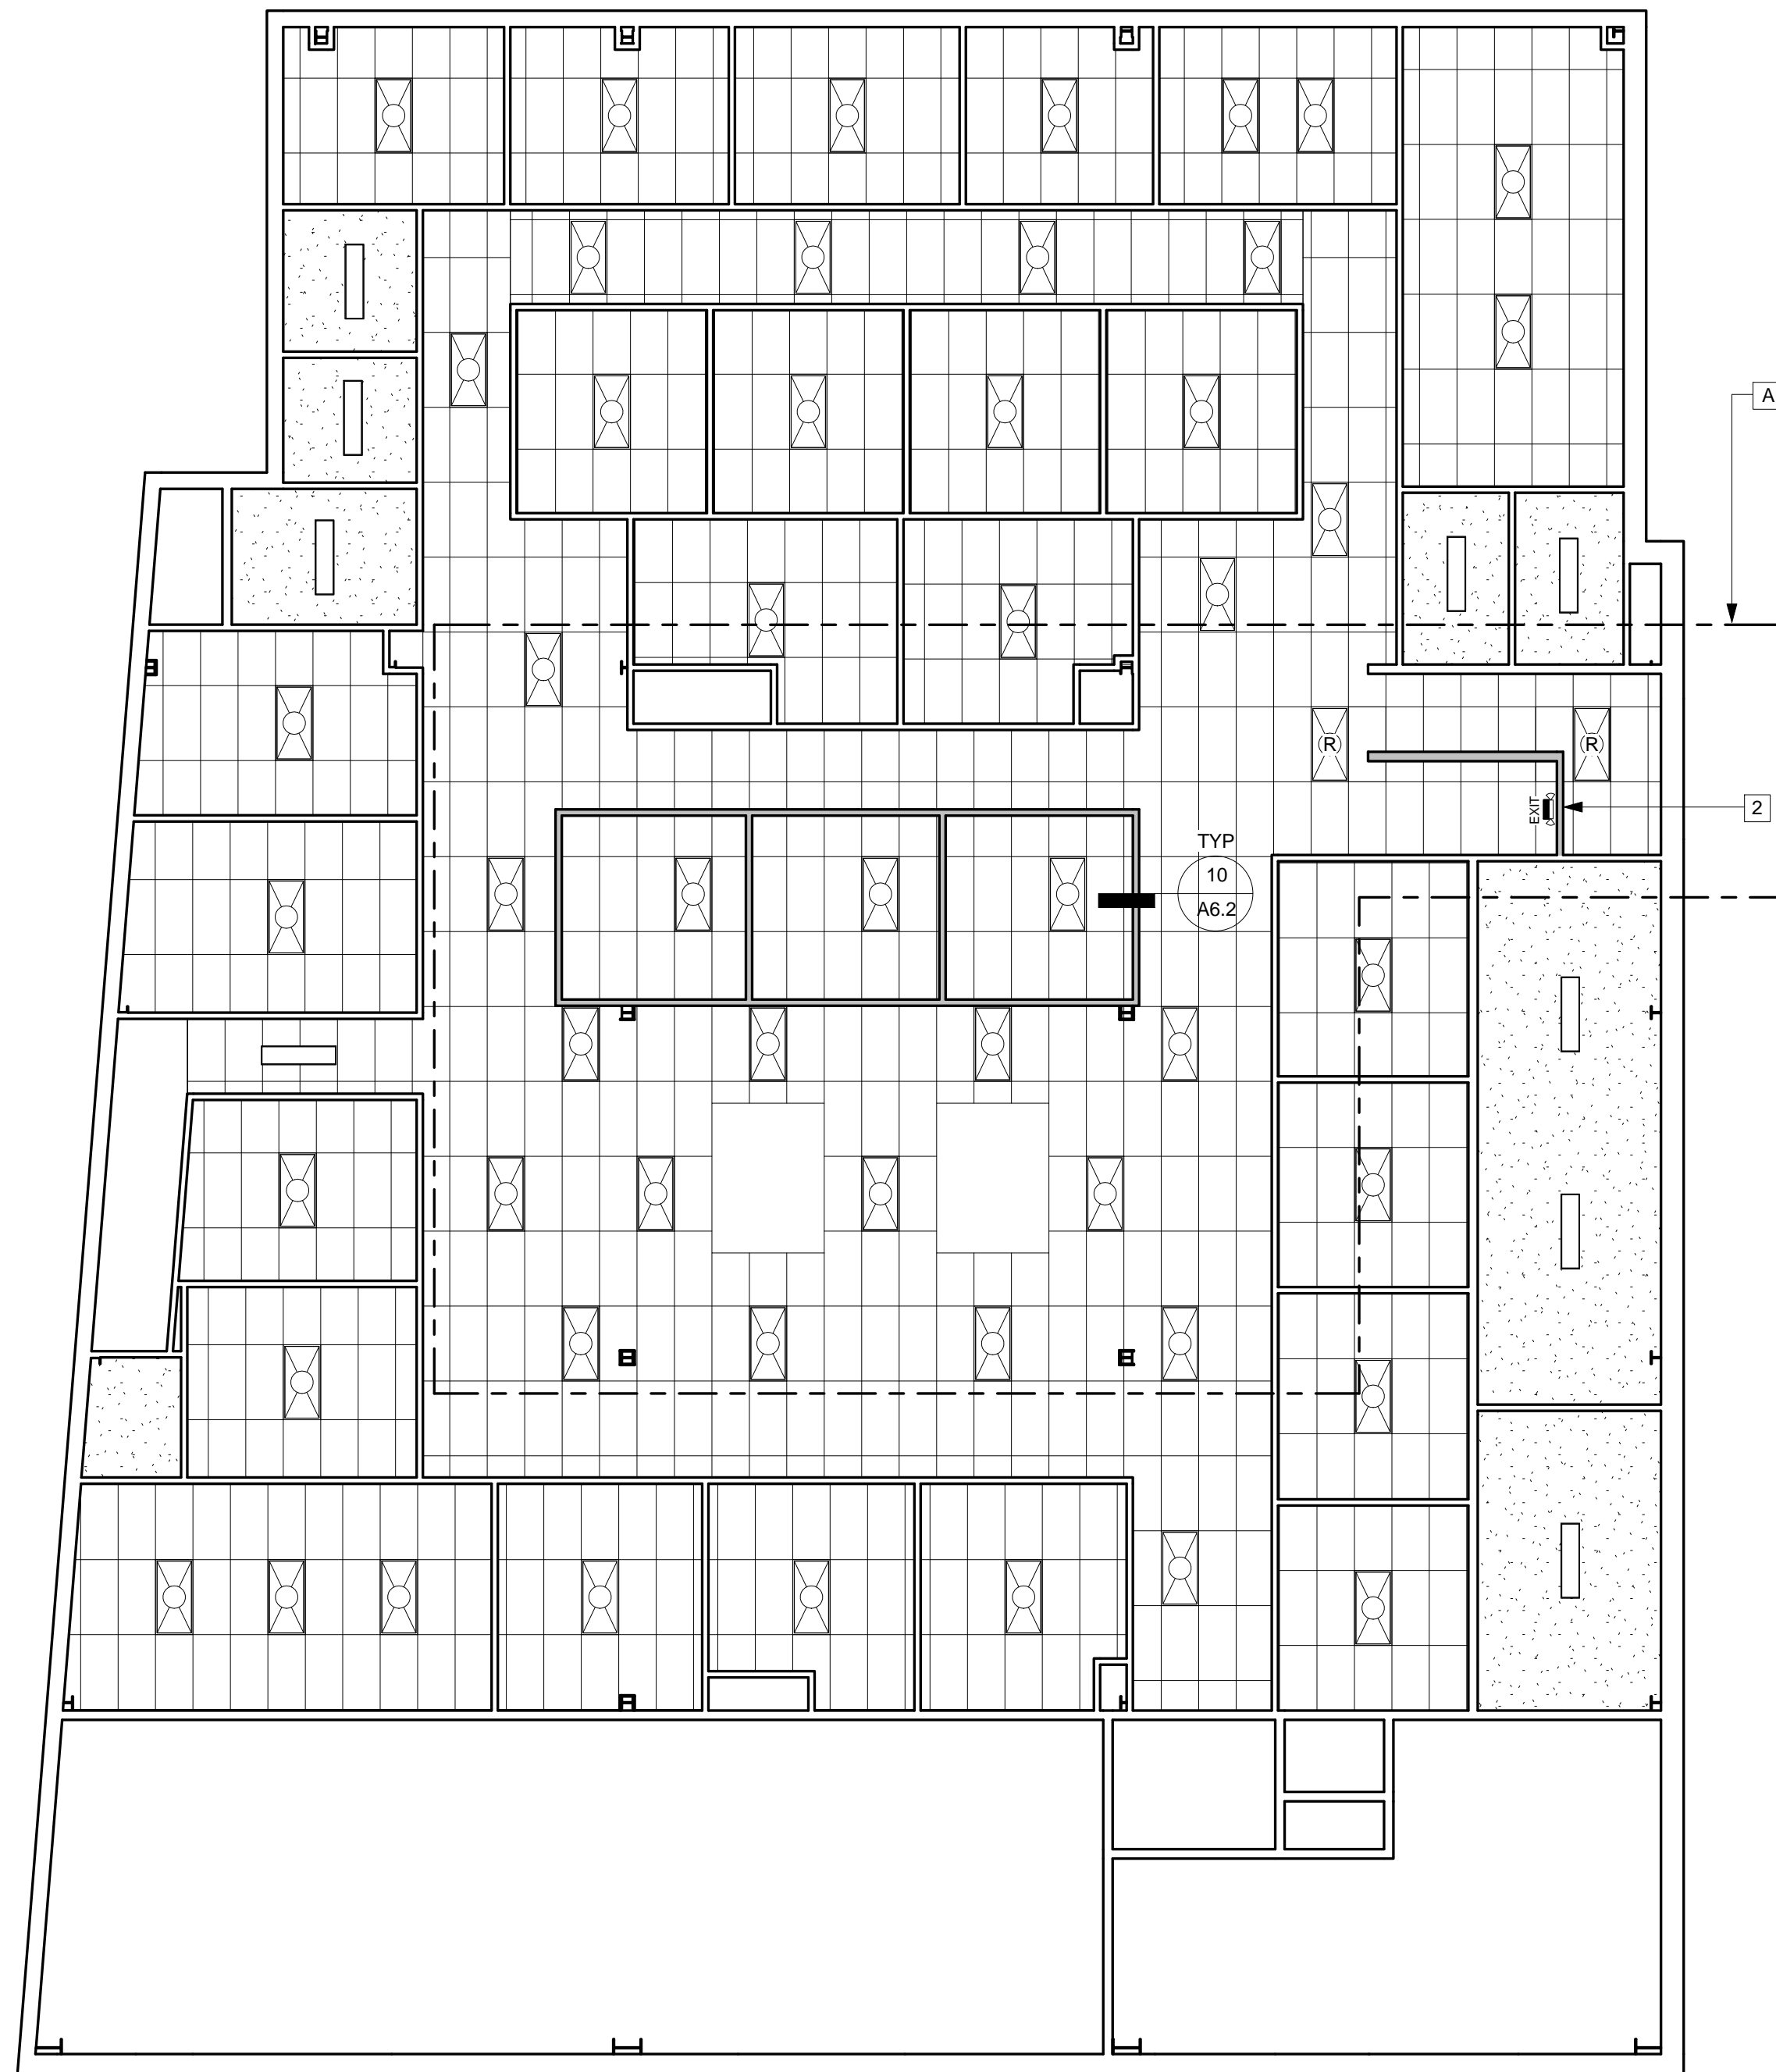

2 3RD FLOOR - OVERALL CEILING PLAN
1/8" = 1'-0"

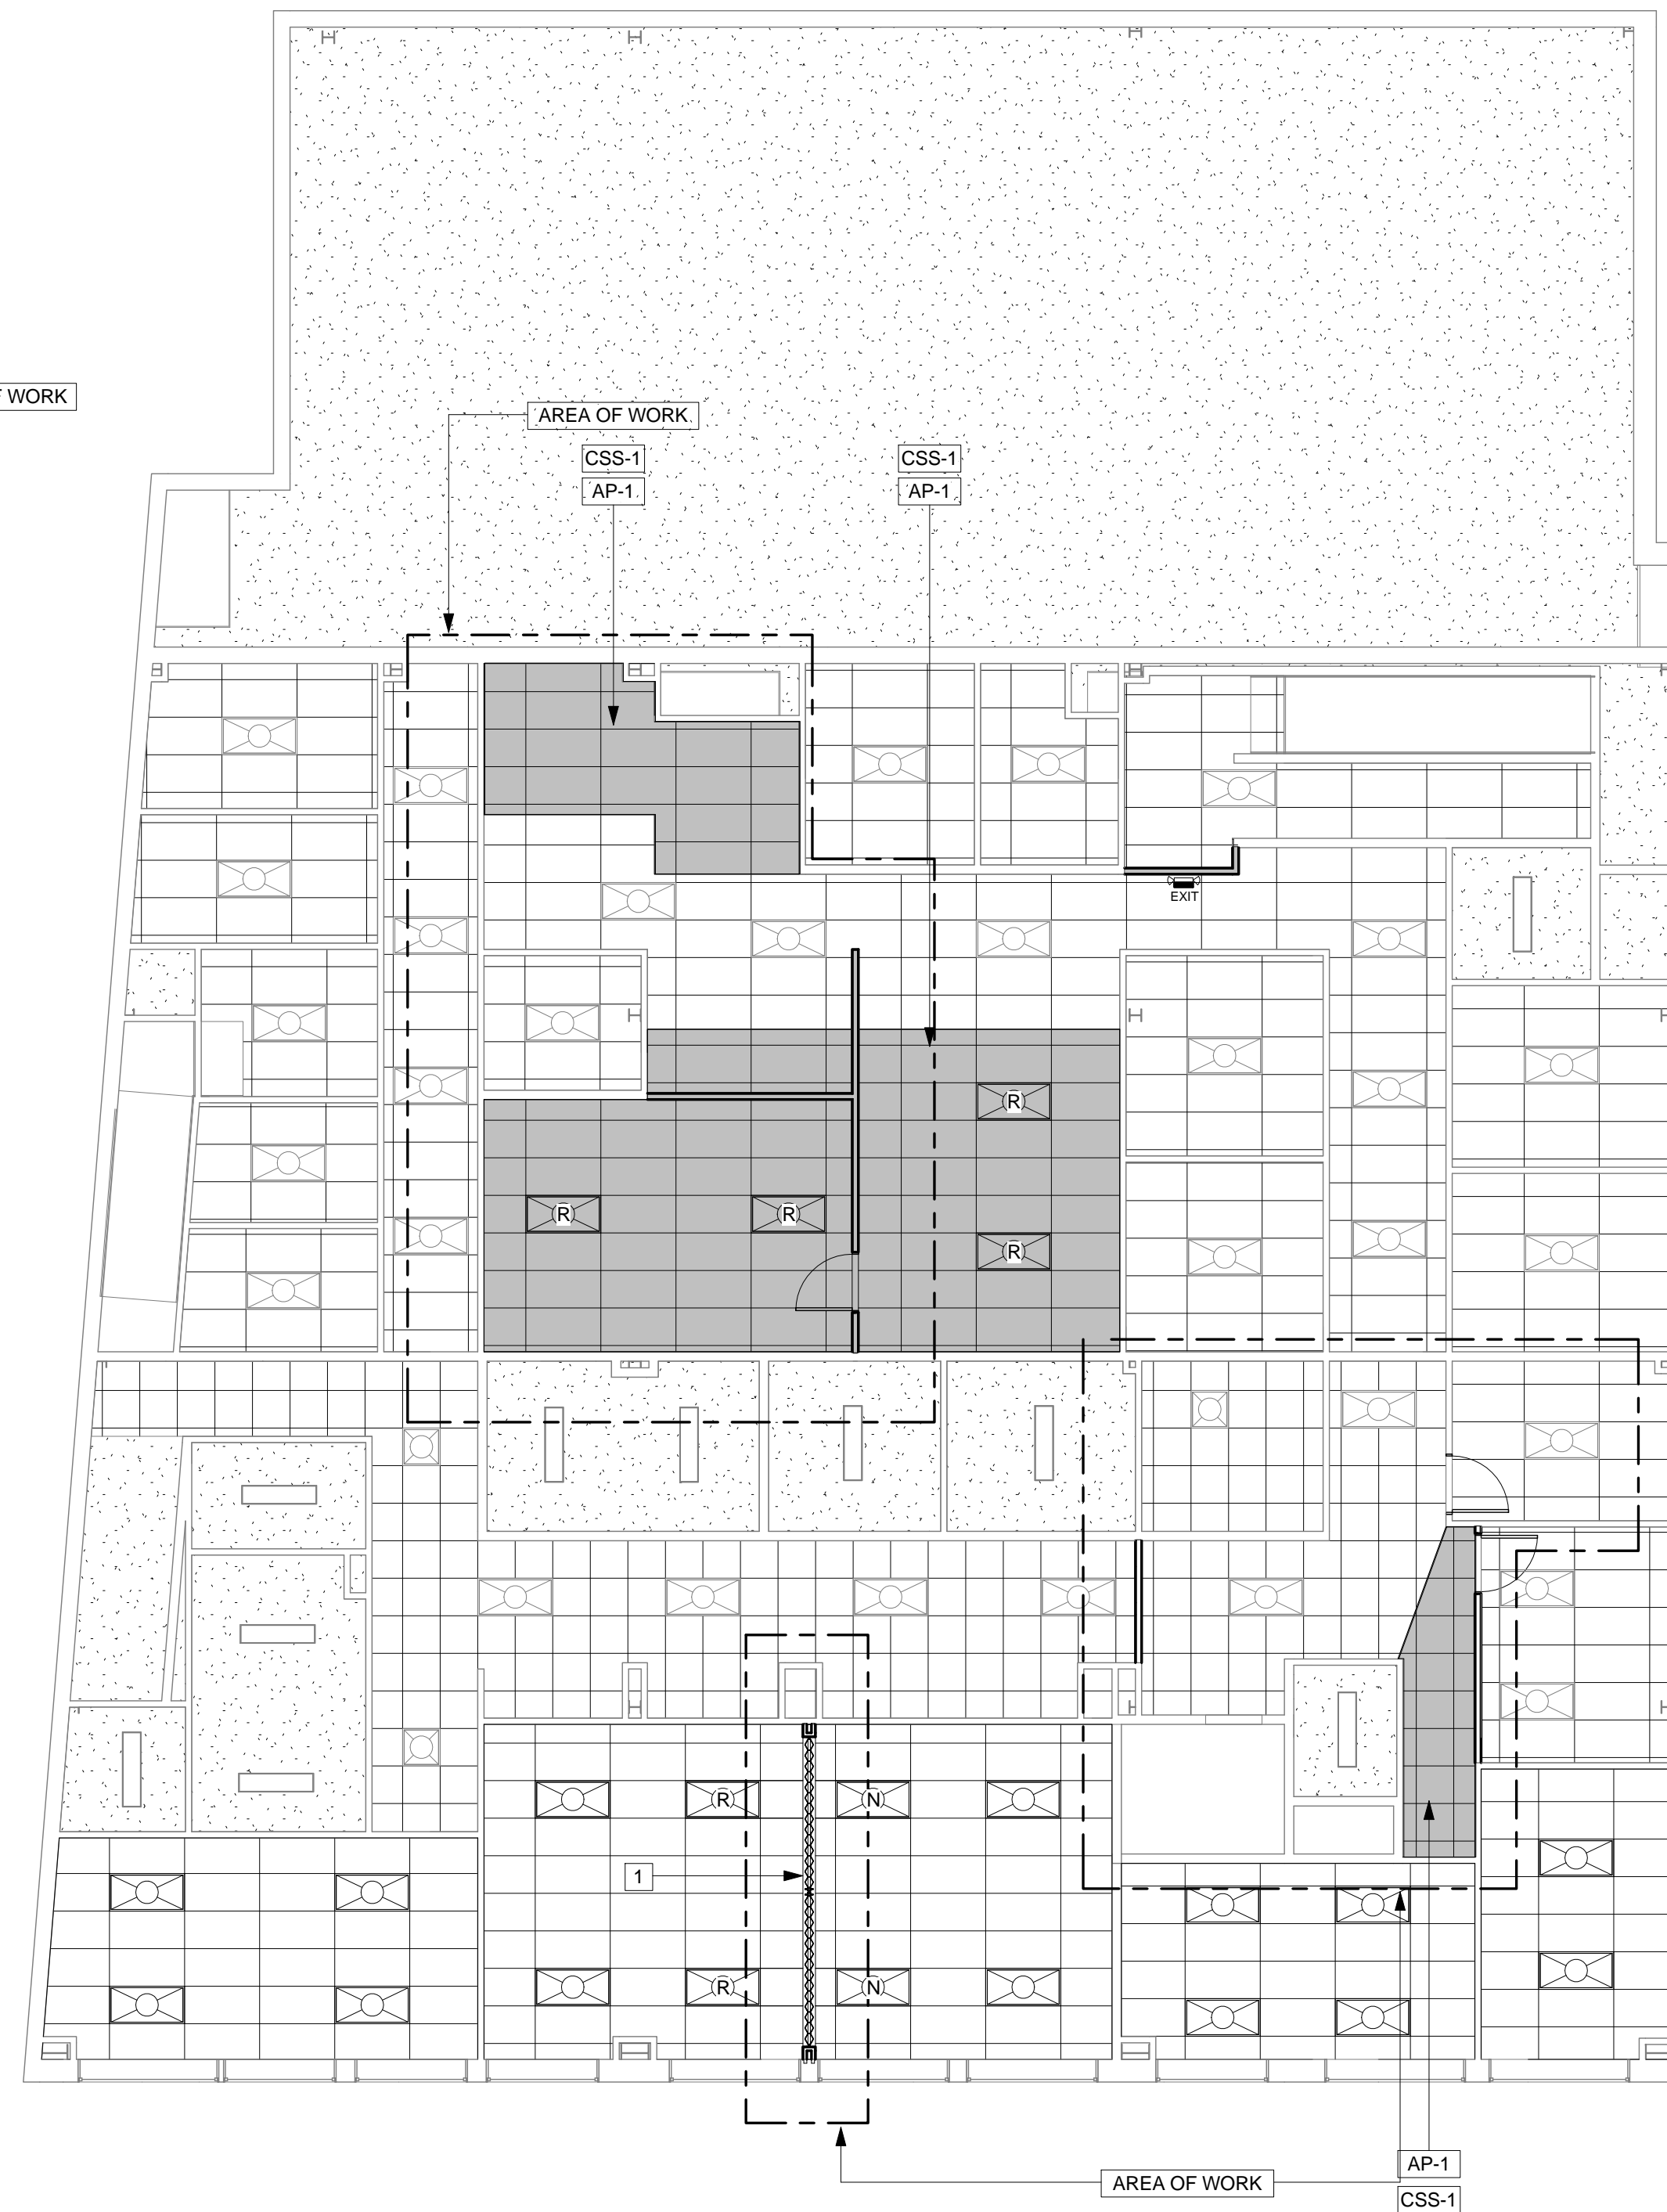

1 2ND FLOOR - OVERALL CEILING PLAN
1/8" = 1'-0"

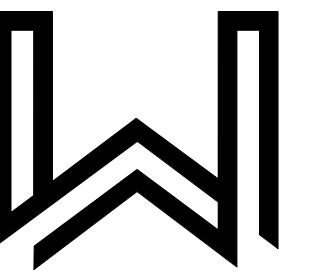


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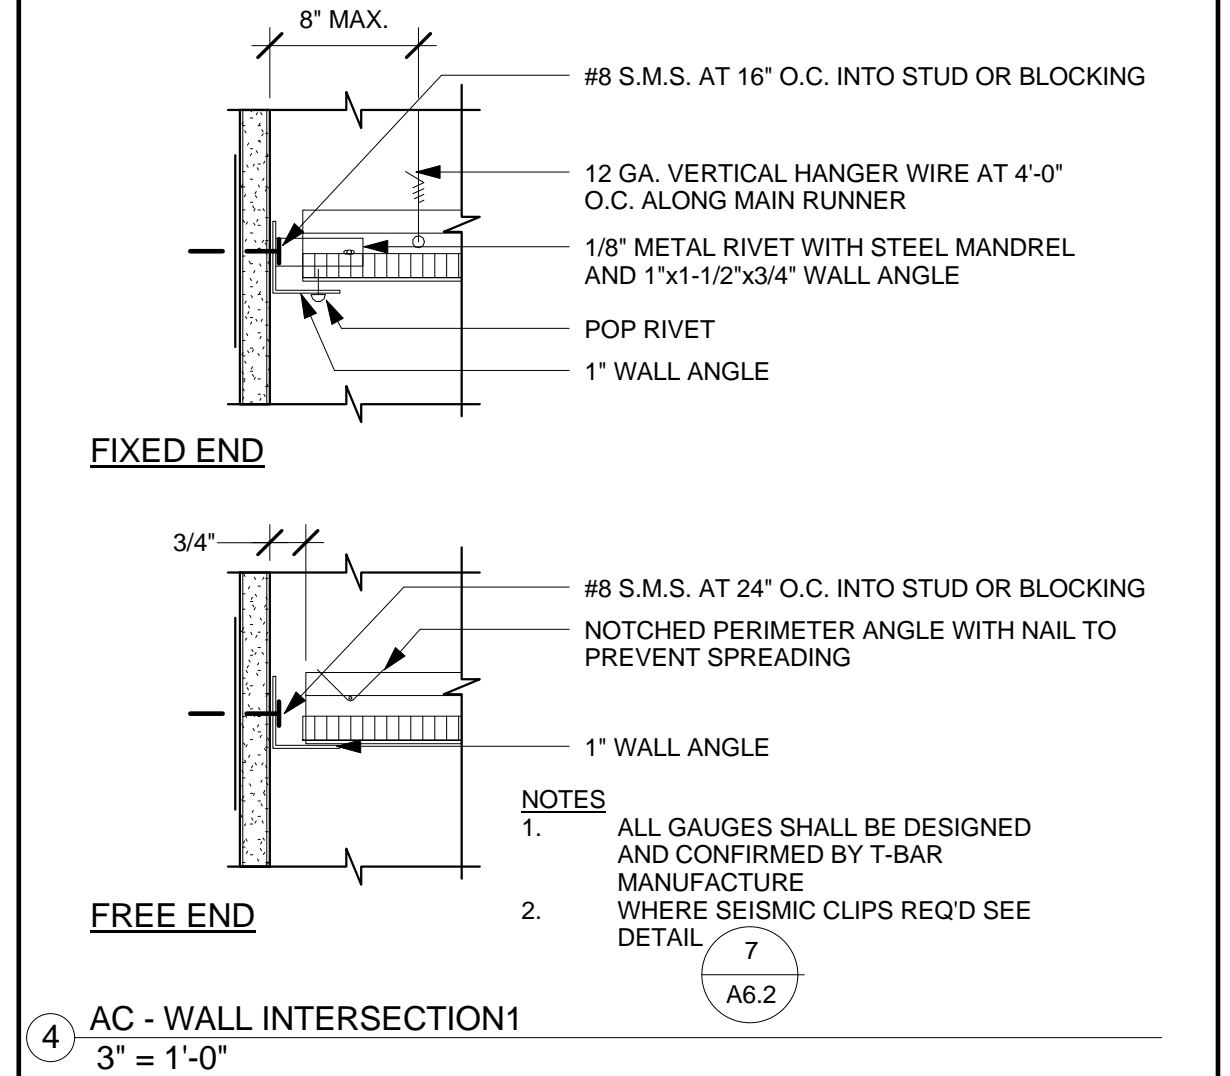
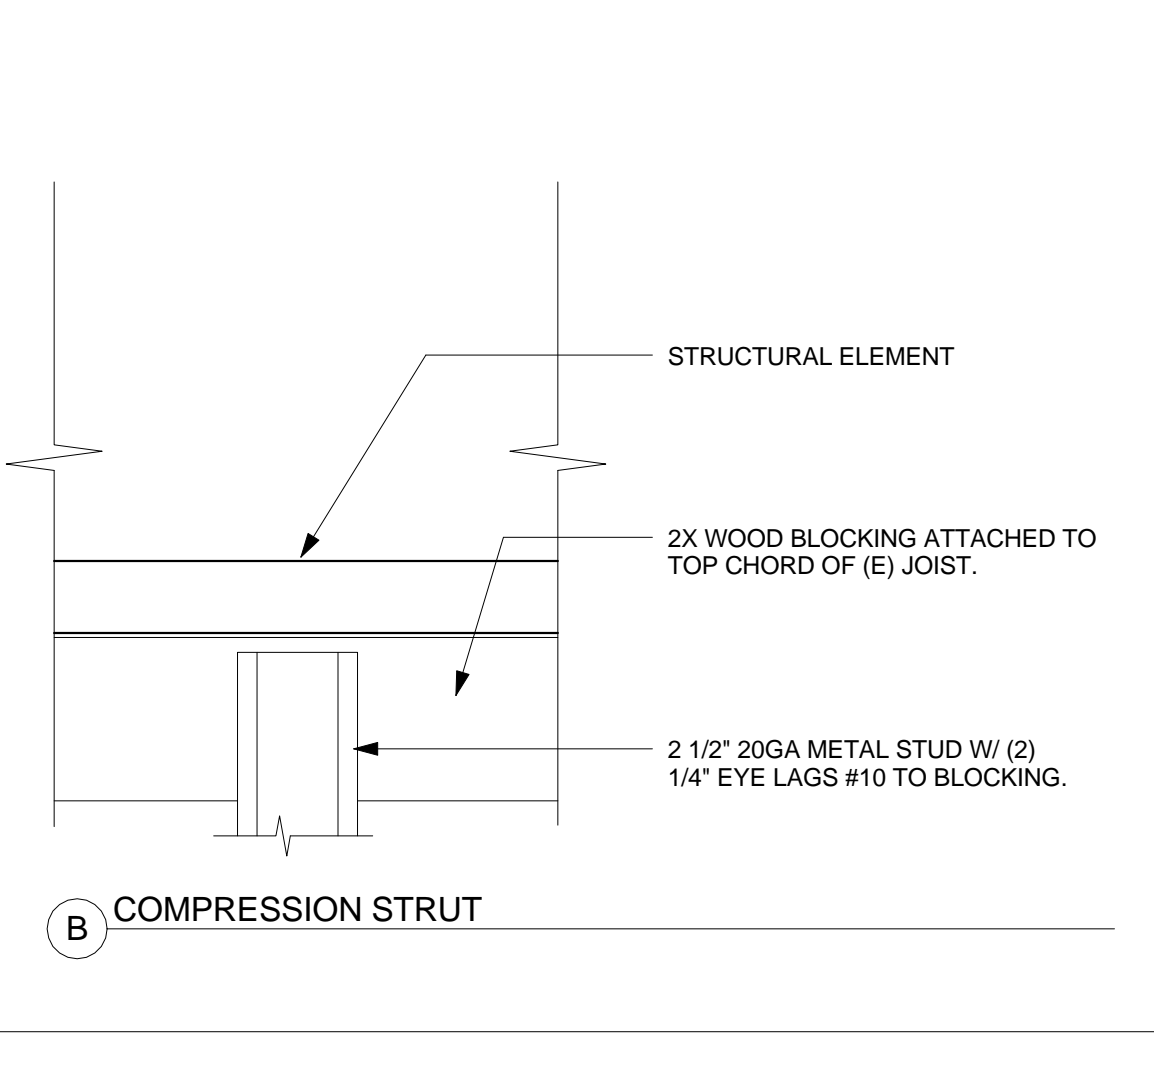
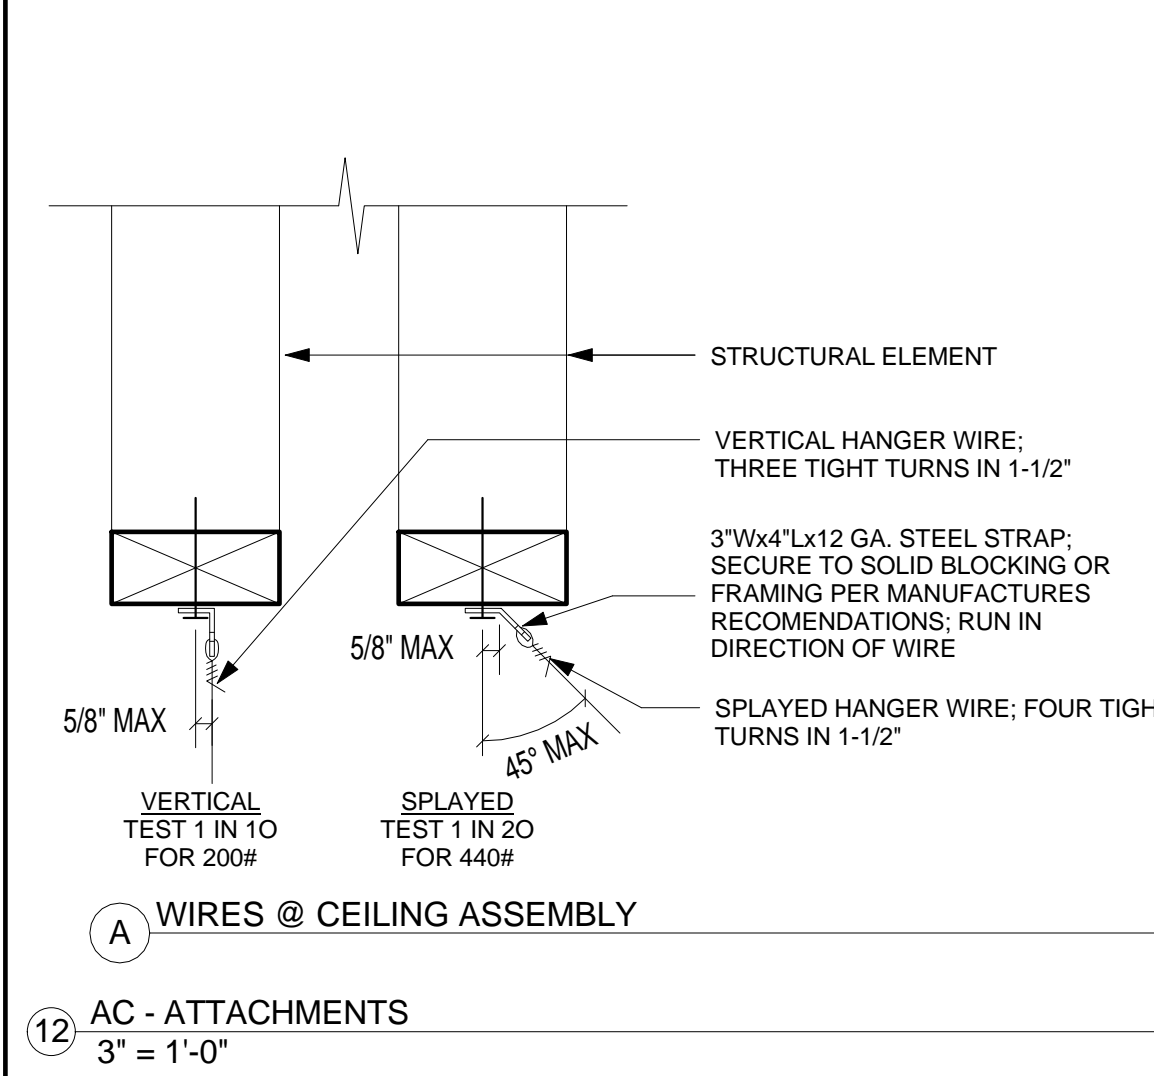
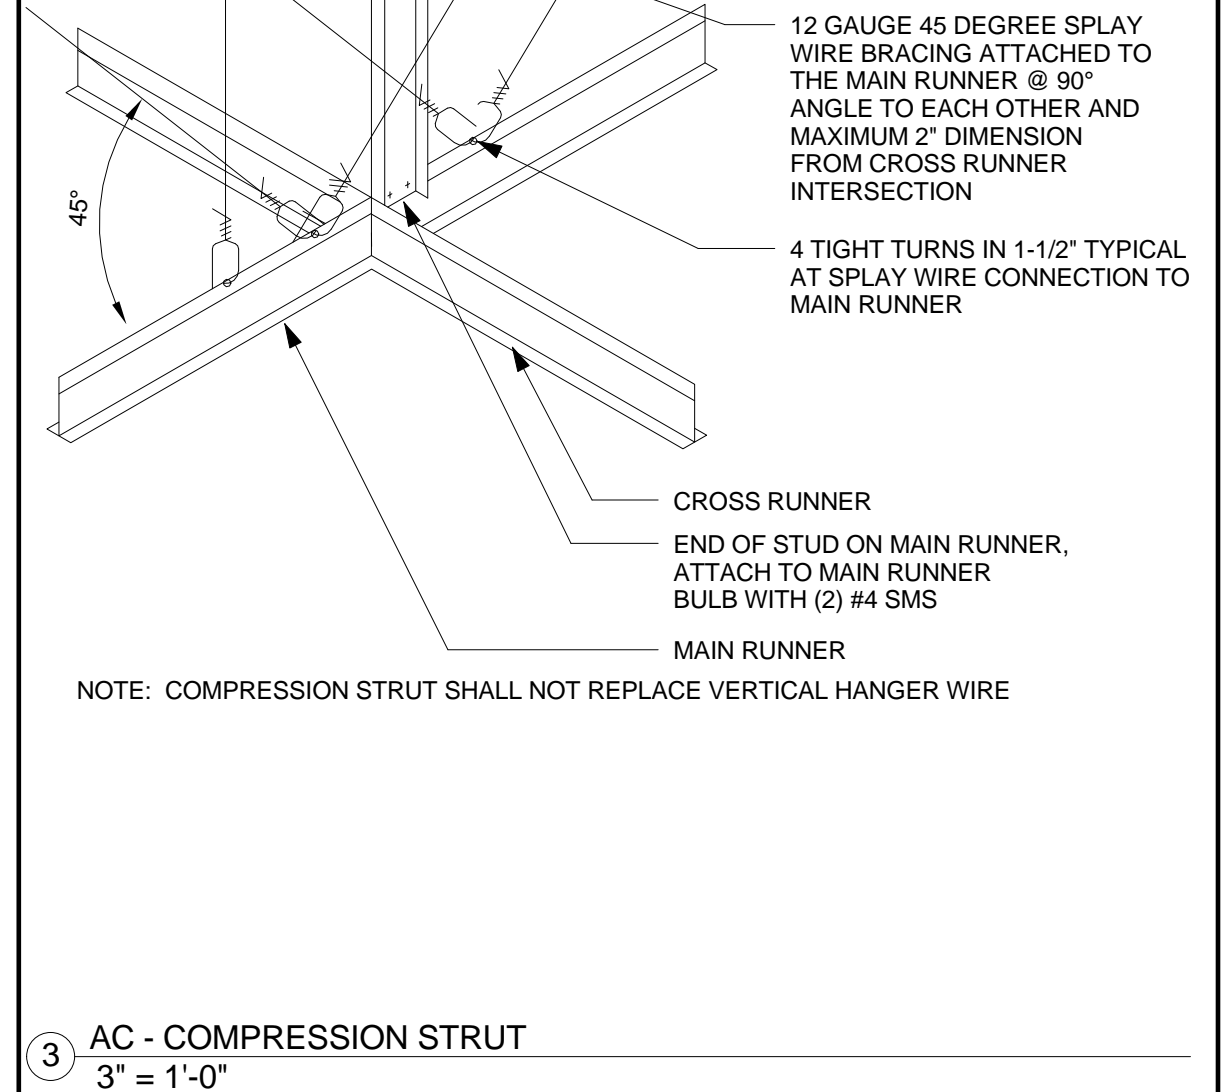
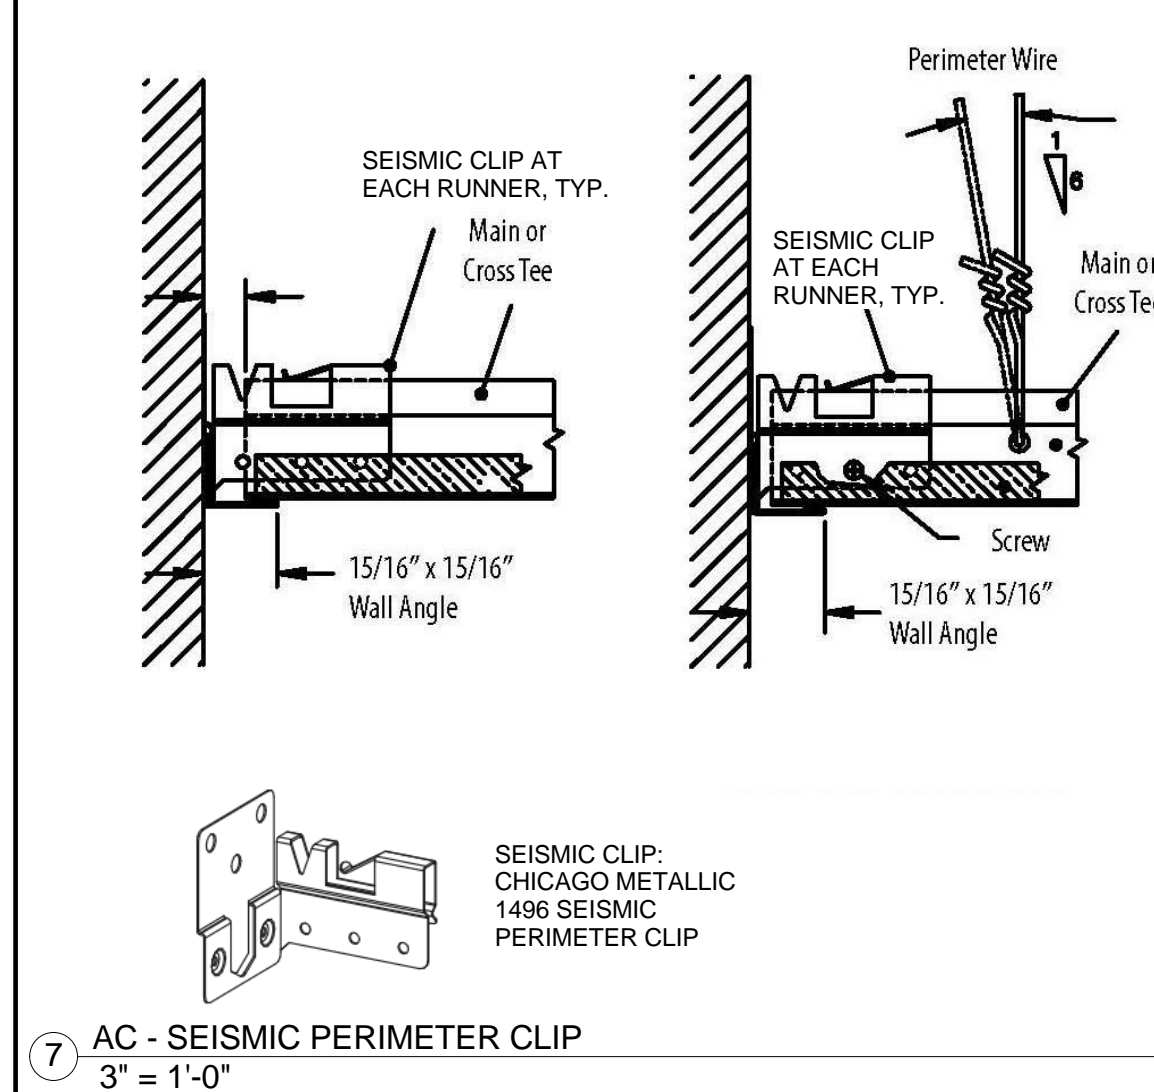
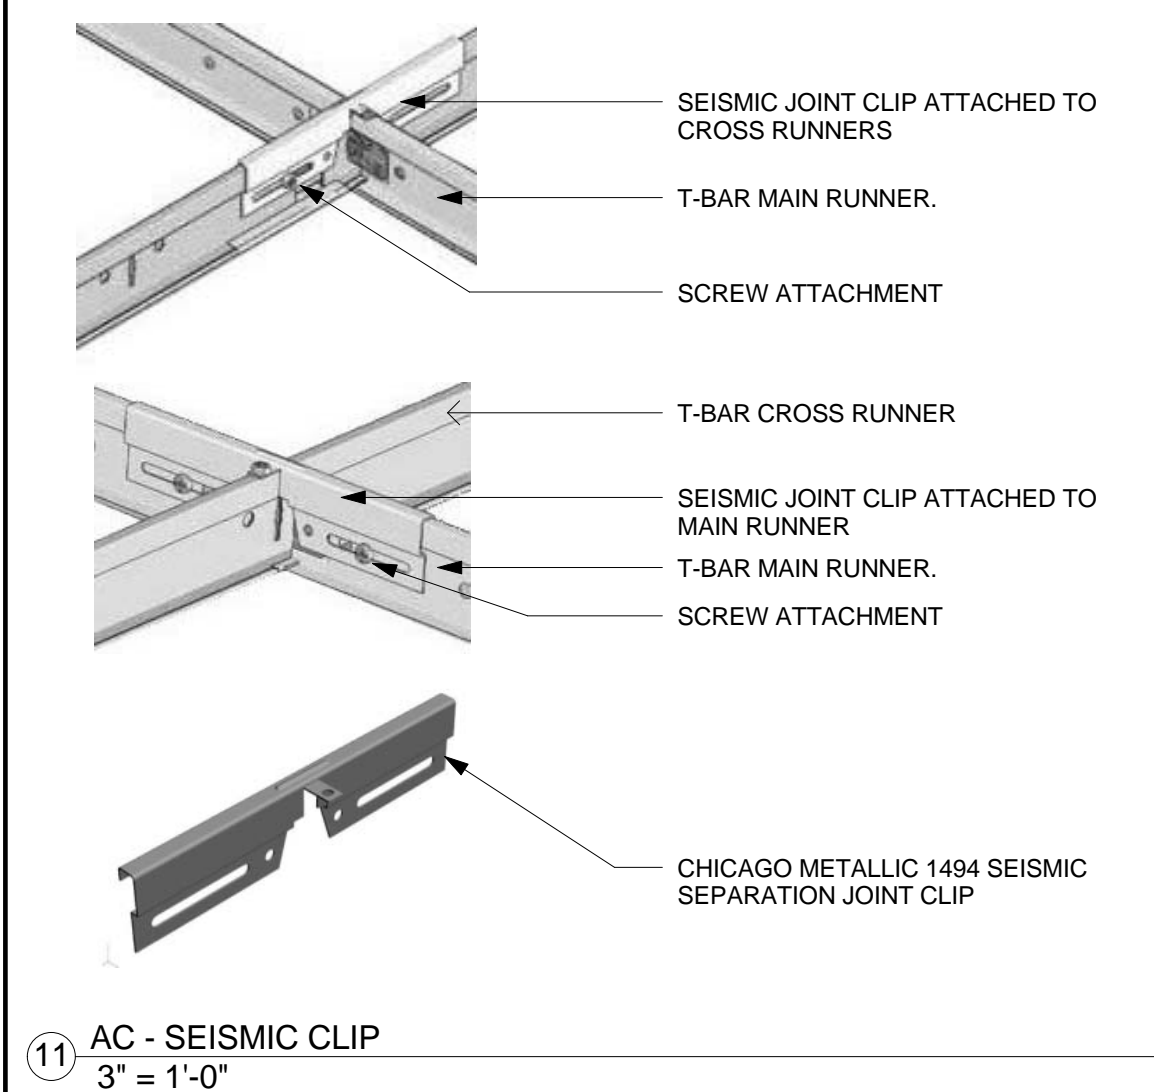
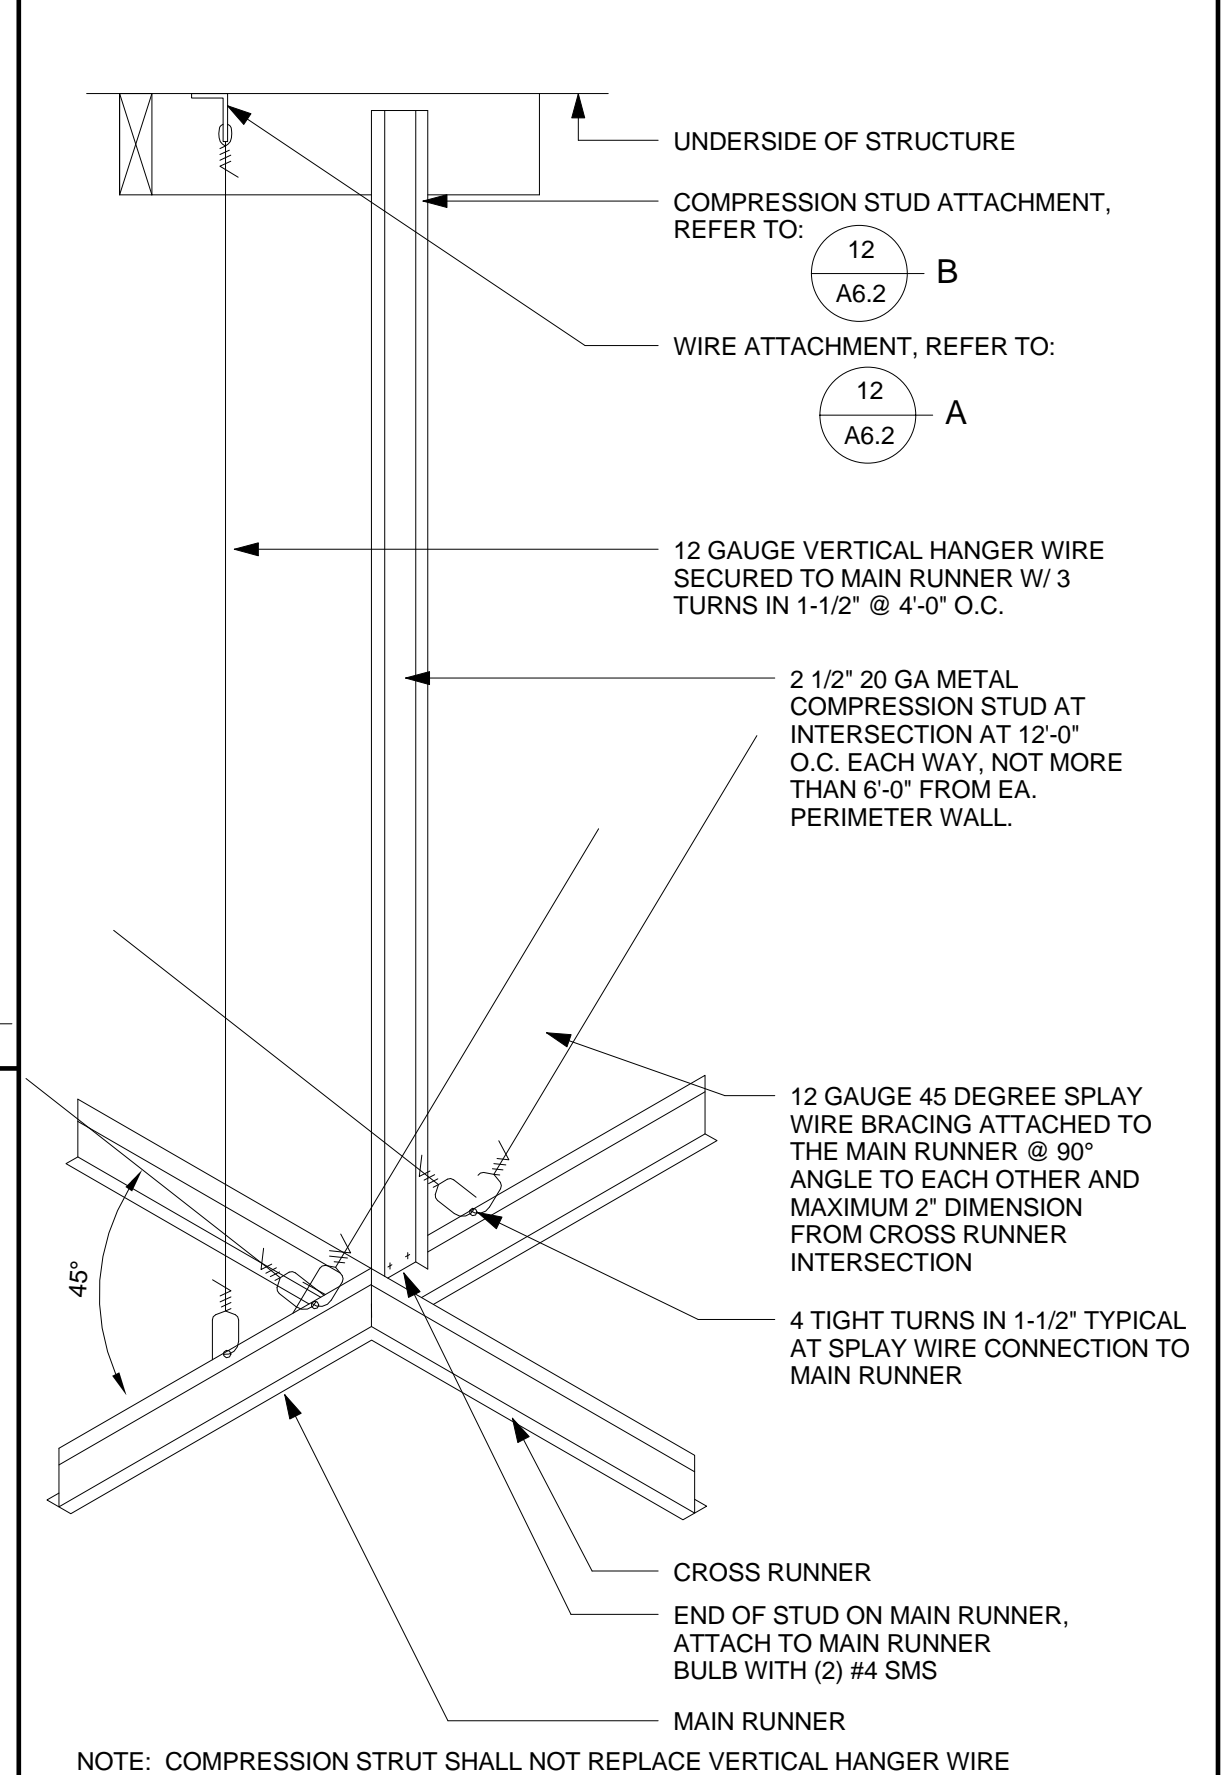
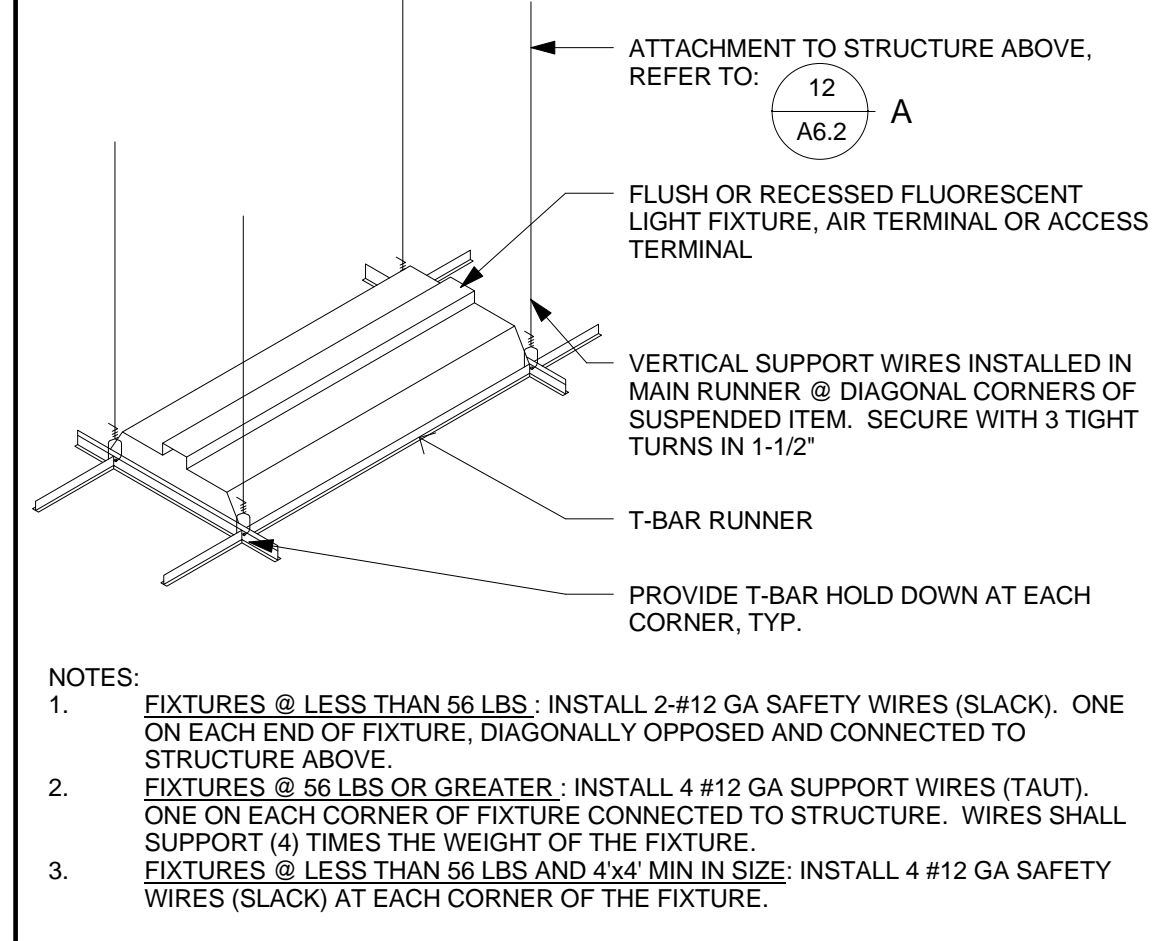
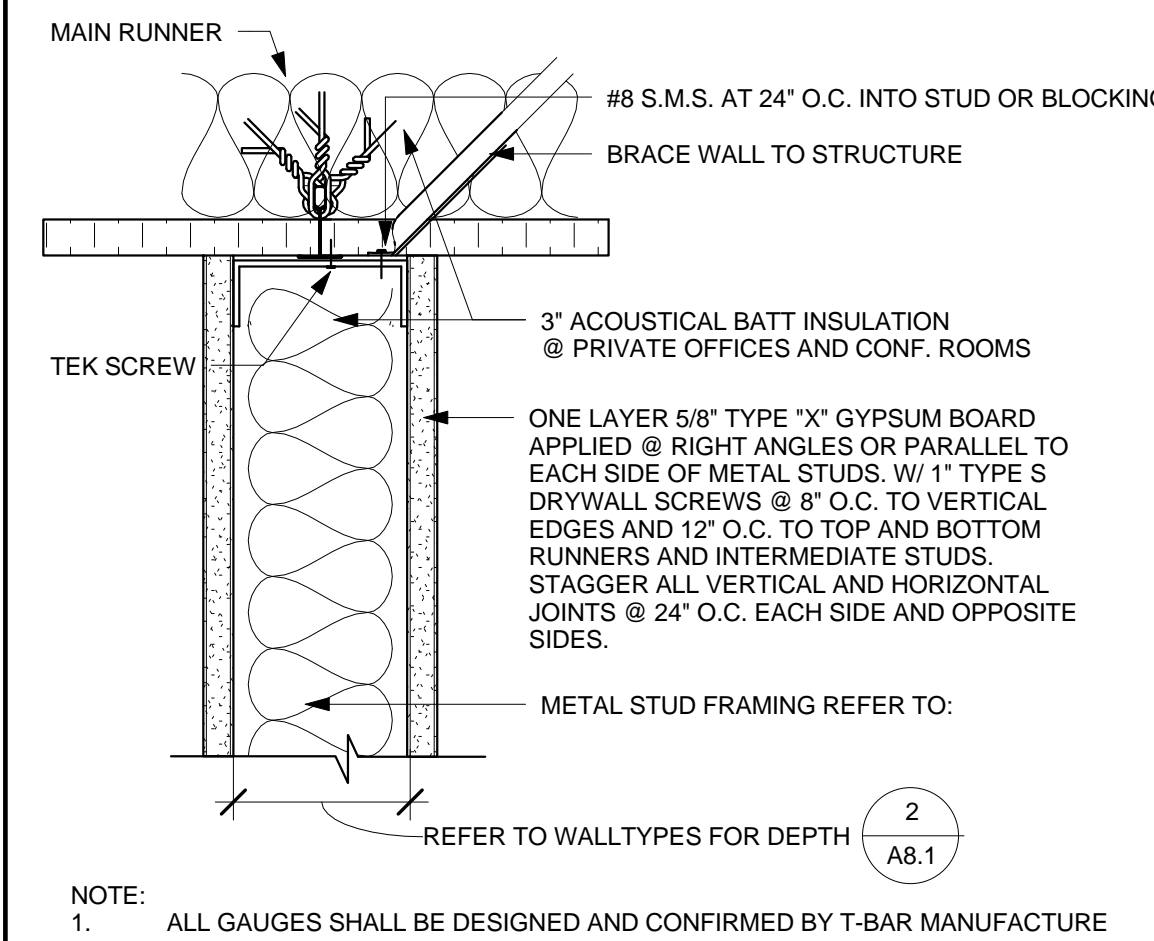
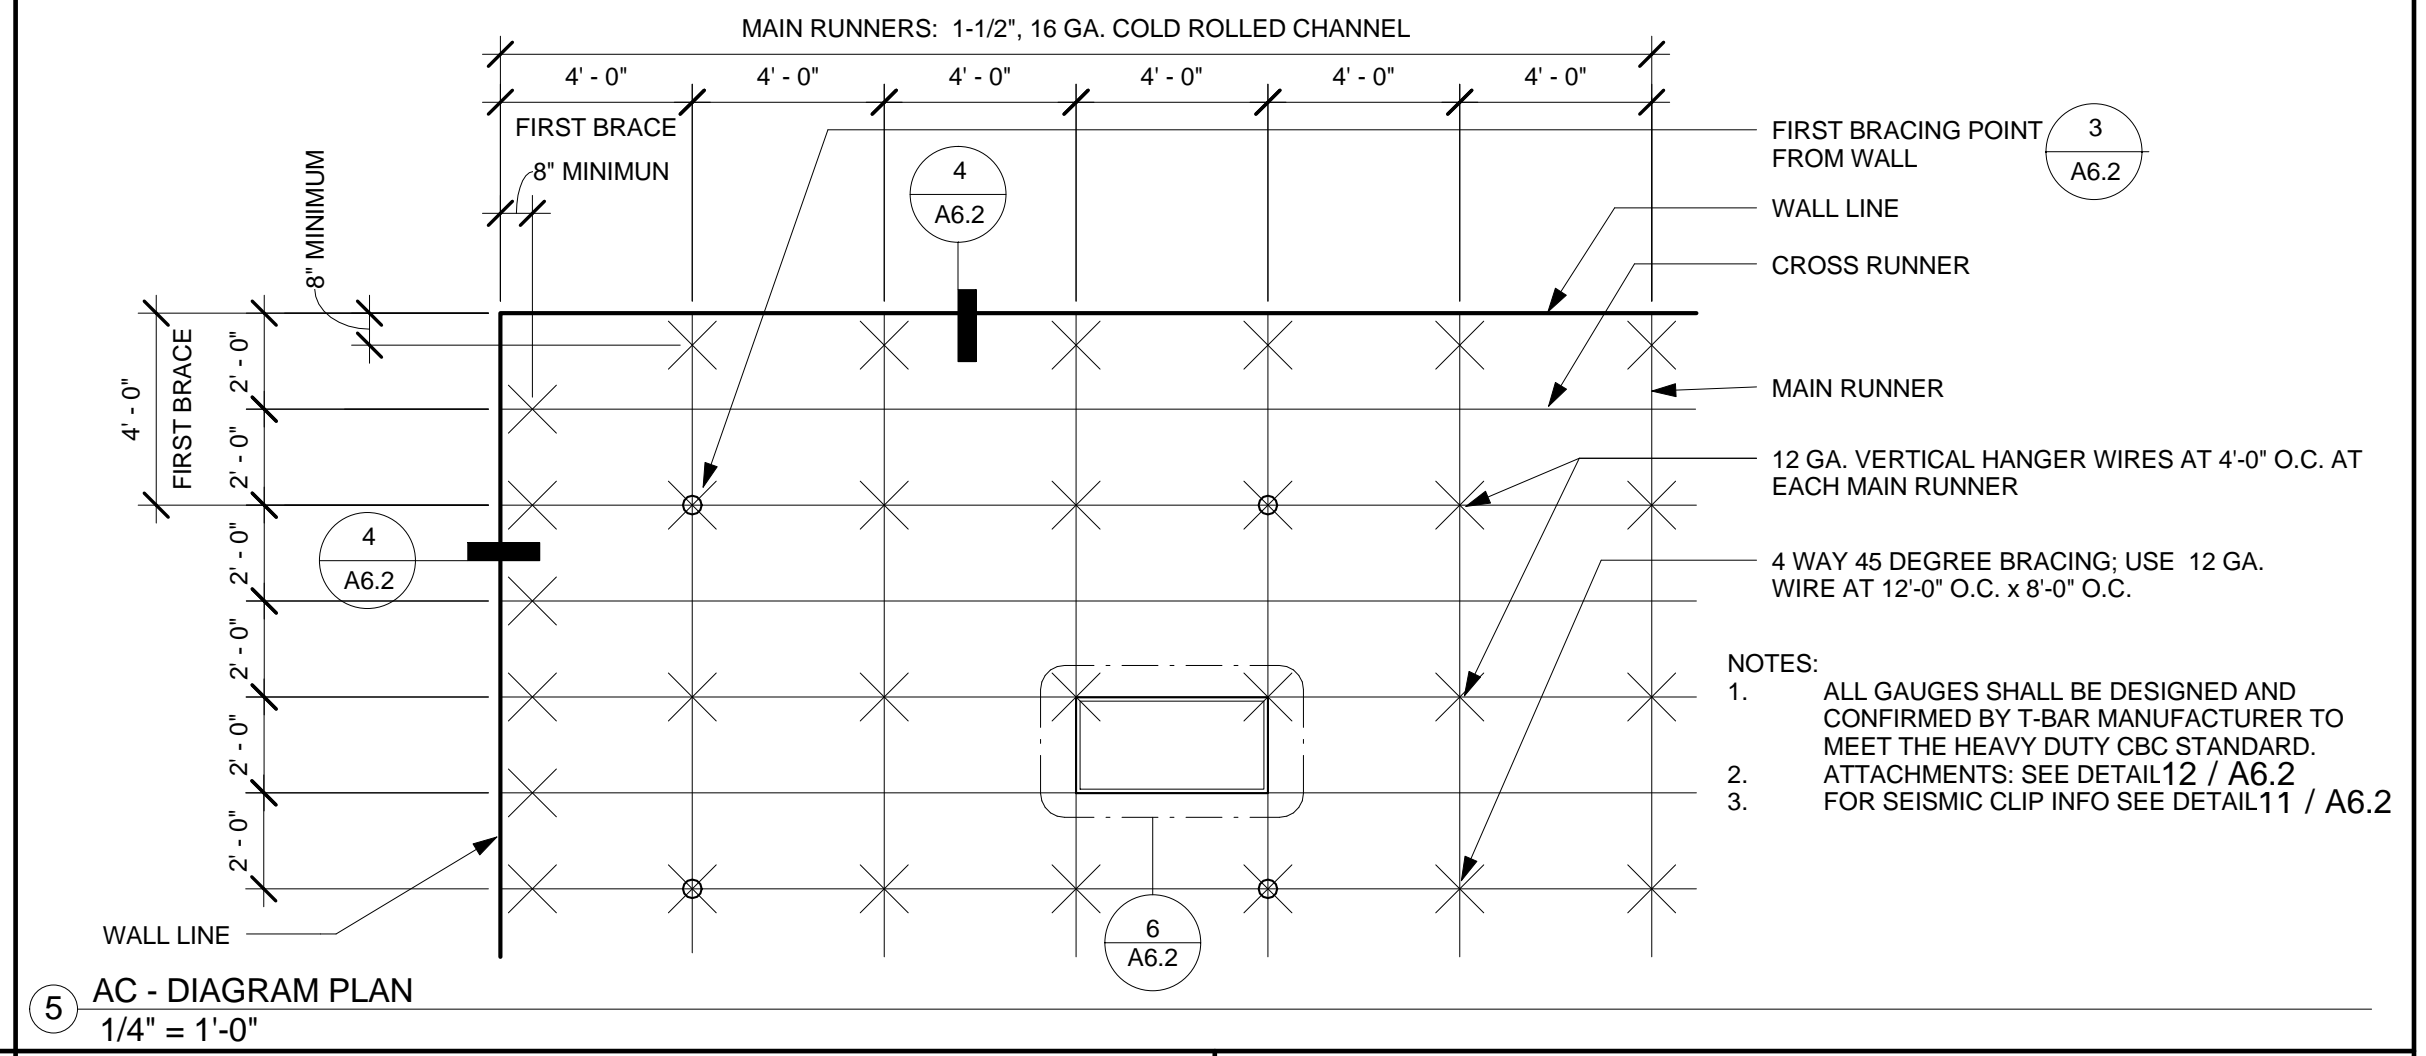
CONSTRUCTION
DOCUMENTS


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No.	Description	Date

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Date: 08/03/2016
Scale: As indicated
Drawn By: JMT

A6.2
CEILING DETAILS

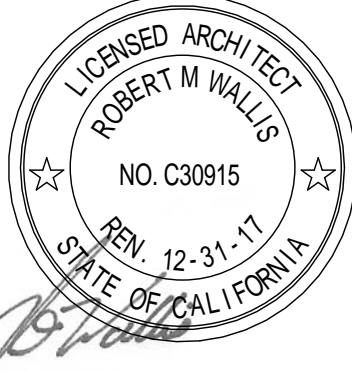

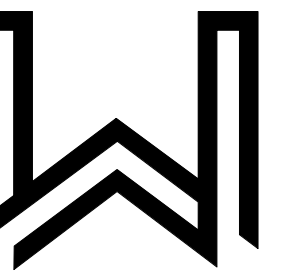


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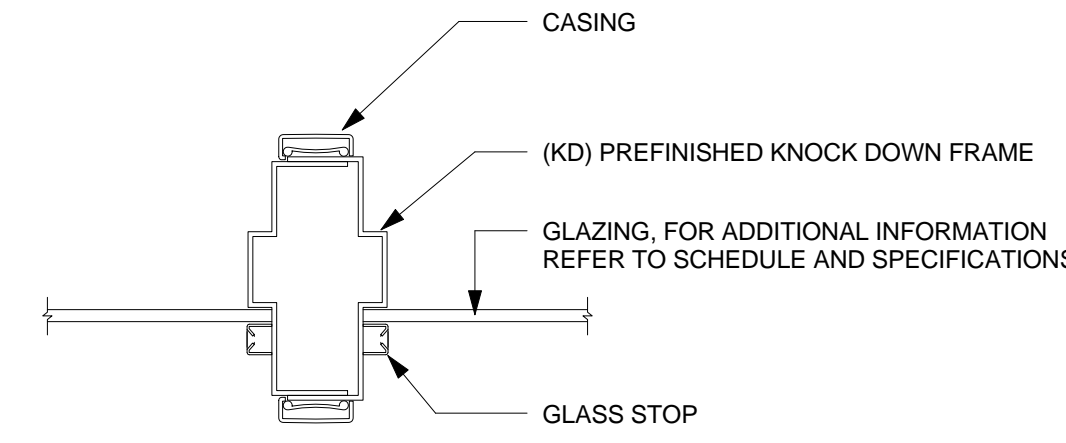
No.	Description	Date

Proj. No.: 2016015
Date: 08/03/2016
Scale: 3" = 1'-0"
Drawn By: JMT


A8.0

DOOR AND WINDOW DETAILS

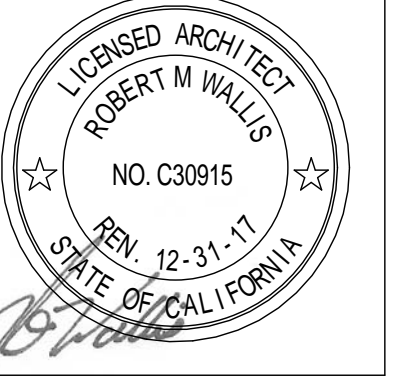
8/4/2016 8:39:38 AM




9 WNDW - KD MULLION VERT
3" = 1'-0"

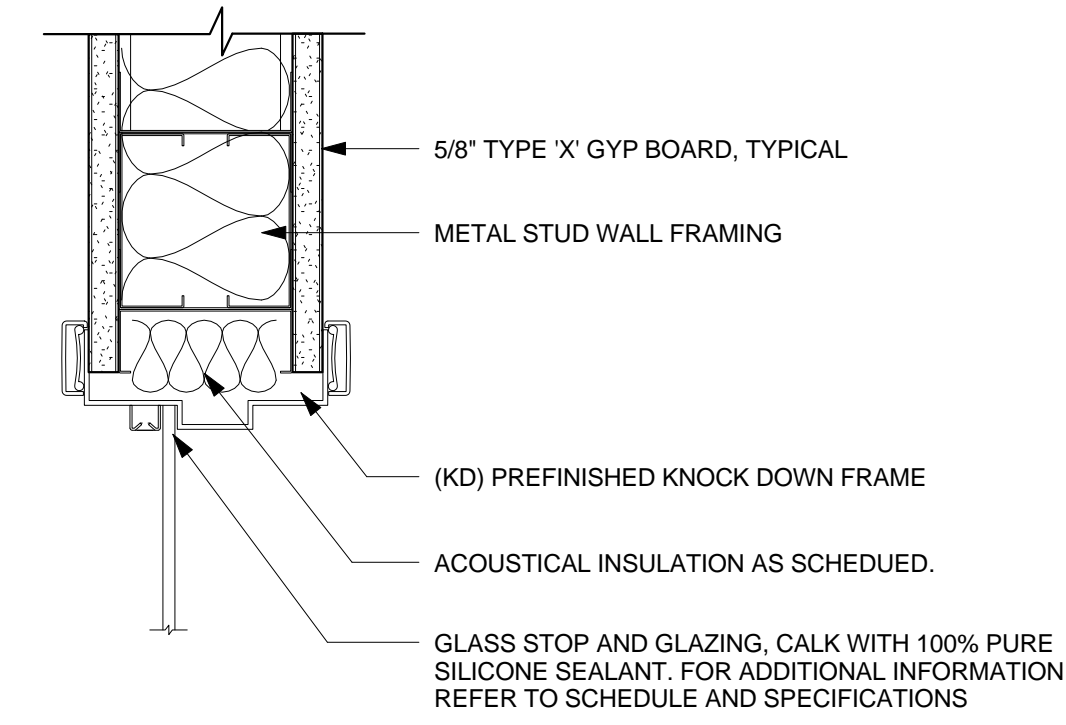


5 WNDW - KD HEAD CONDITION
3" = 1'-0"

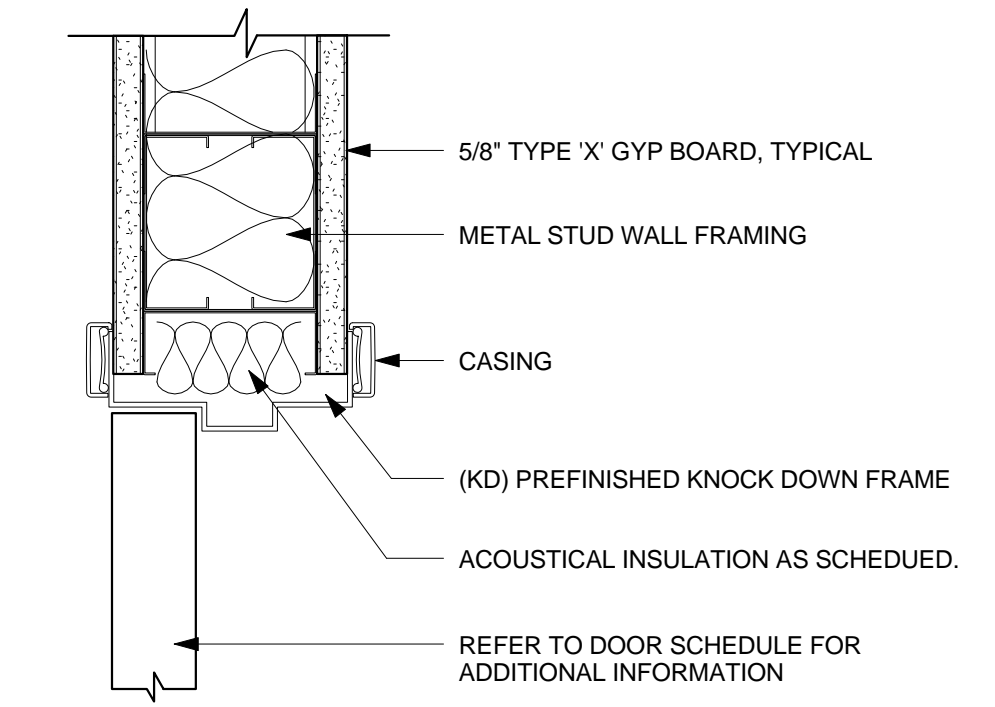


1 DOOR - KD INT DOOR HEAD
3" = 1'-0"

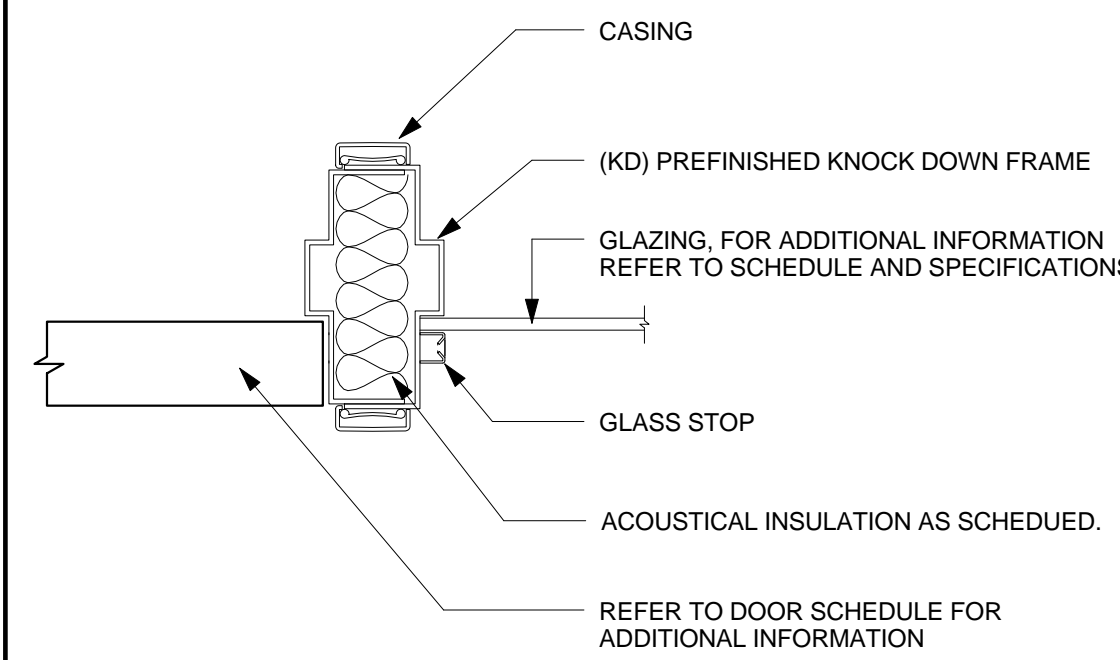


10 DOOR - KD INT DOOR JAMB/HEAD
3" = 1'-0"

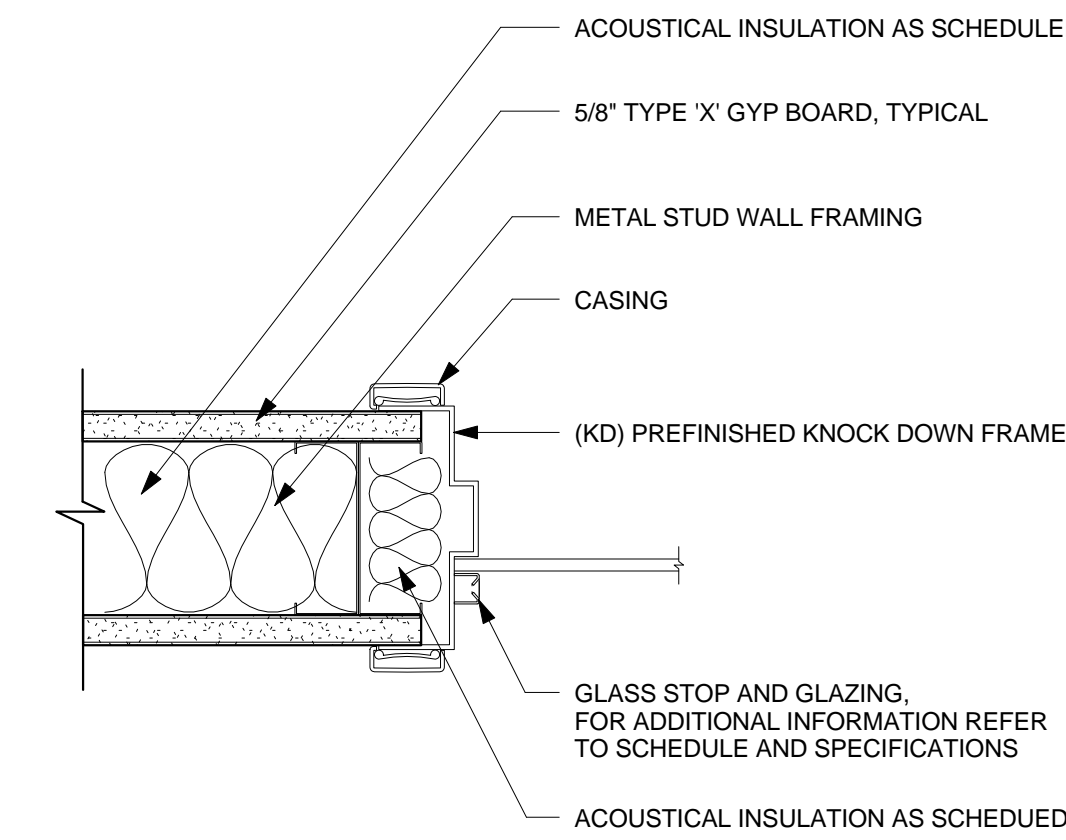


6 WNDW - KD JAMB CONDITION @ WALL
INSULATED
3" = 1'-0"

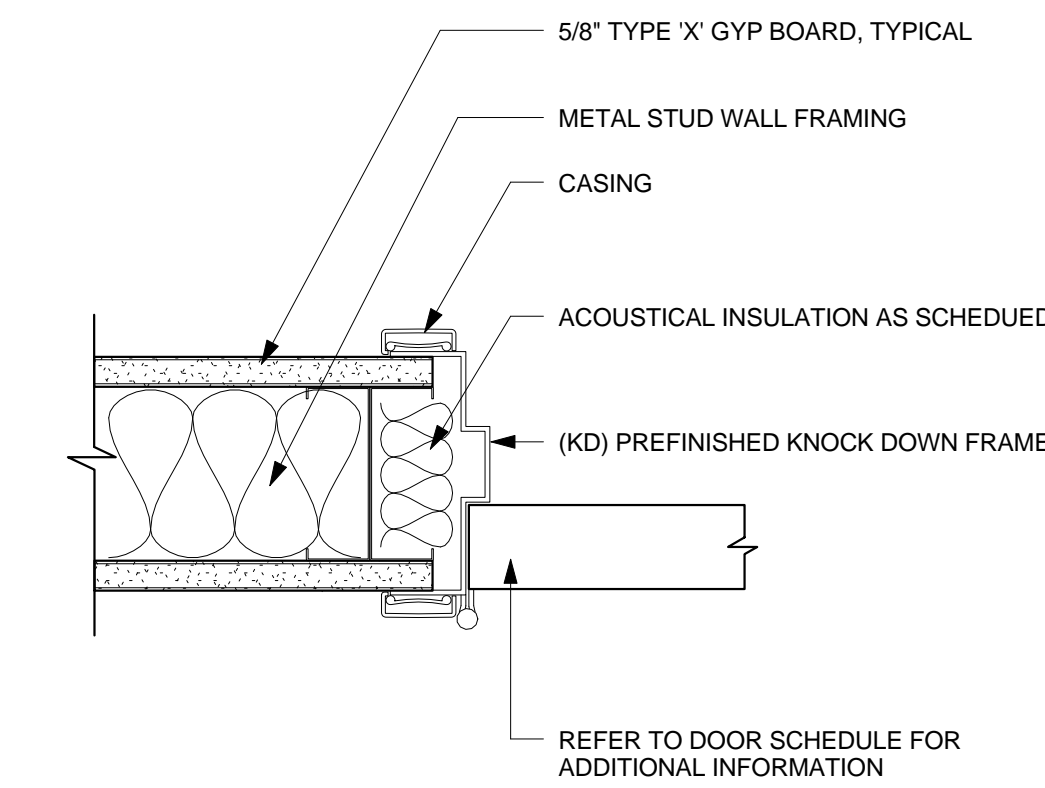


2 DOOR - KD INT DOOR JAMB @ WALL
3" = 1'-0"

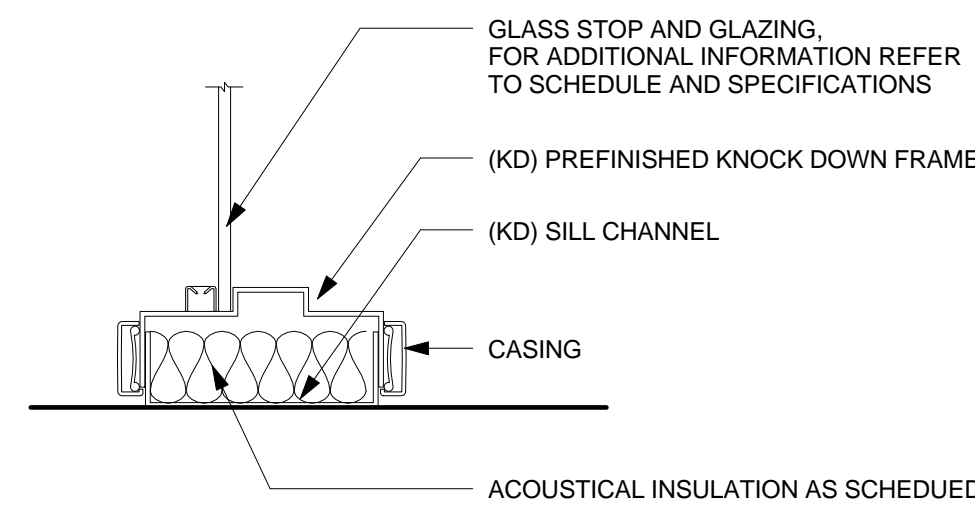


11 WNDW - KD SILL CONDITION @ FLOOR
3" = 1'-0"

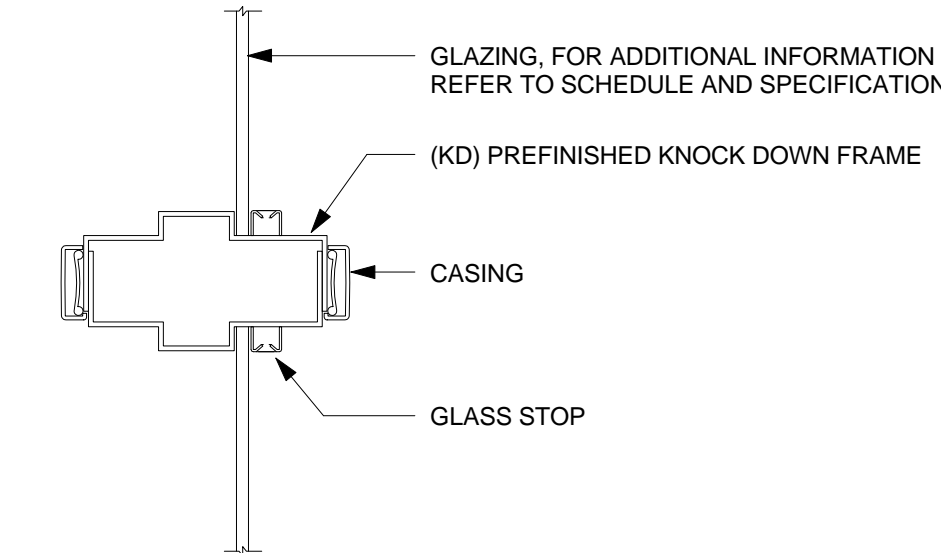

7 WNDW - KD MULLION HORIZ
3" = 1'-0"

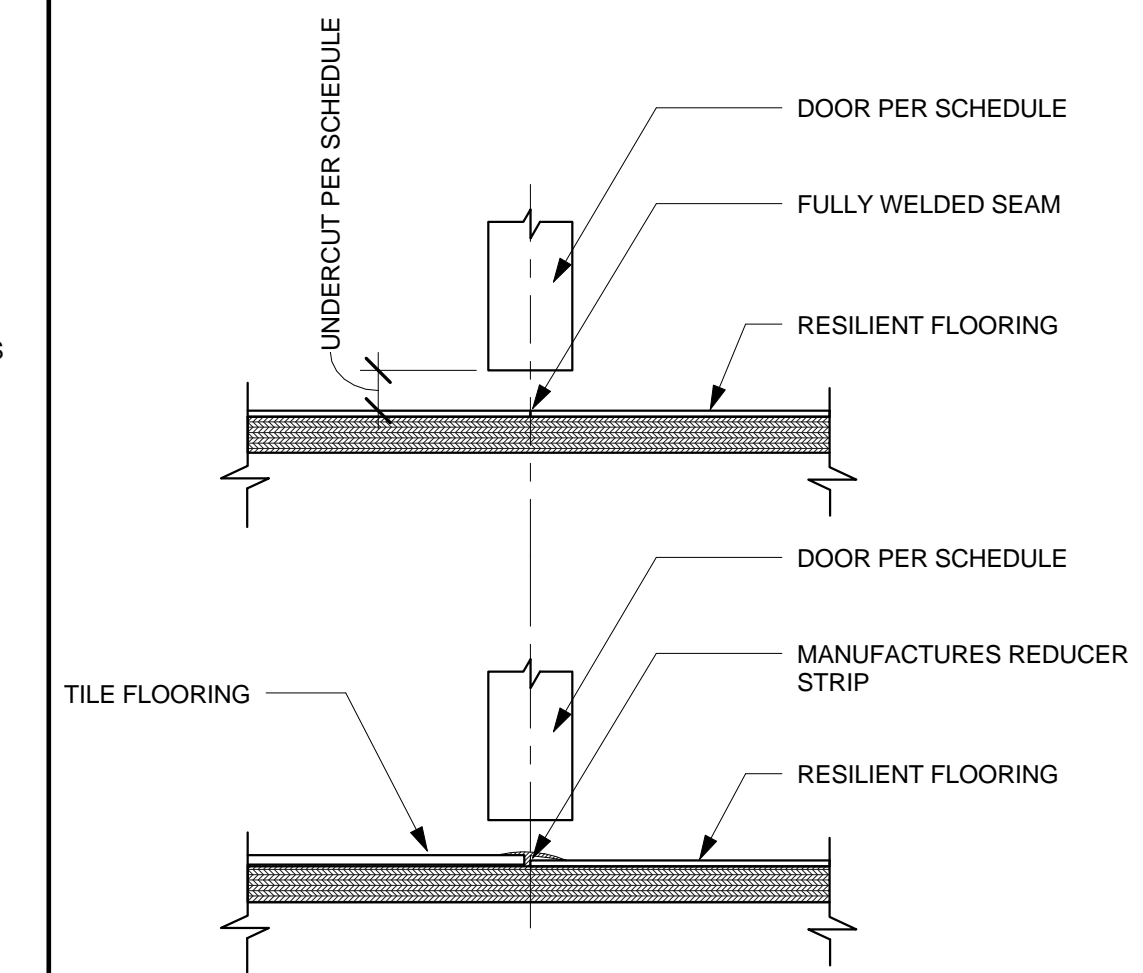

3 DOOR - INT THRESHOLD
3" = 1'-0"

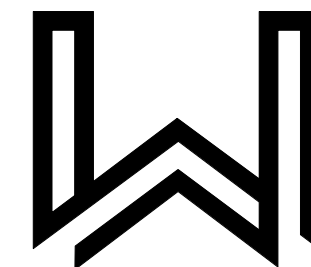


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No.	Description	Date

Proj. No.: 2016015
Date: 08/03/2016
Scale: As indicated
Drawn By: JMT

A8.1
METAL FRAMING DETAILS

INTERIOR NON-BEARING PARTITIONS SCHEDULE
MAXIMUM HEIGHT FOR METAL STUDS WITH DEFLECTION LIMIT L/240 @ 7.5 PSF A8.1

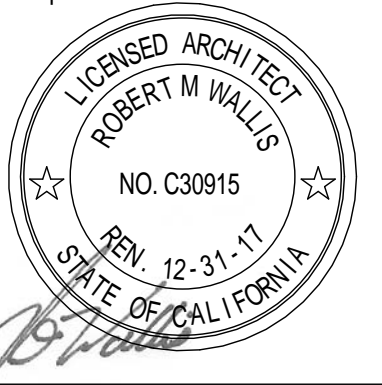24" CC SPACING - REFER TO WALL TYPES FOR DEPTH


DEPTH	GAUGE	FLANGE	HEIGHT
3 5/8"	20	1 3/8"	12'-10"
3 5/8"	18	1 3/8"	13'-11"
3 5/8"	16	1 3/8"	14'-11"
3 5/8"	14	1 3/8"	15'-11"
4"	20	1 3/8"	13'-10"
4"	18	1 3/8"	15'-0"
4"	16	1 3/8"	16'-1"
4"	14	1 3/8"	17'-2"
6"	20	1 3/8"	18'-11"
6"	18	1 3/8"	20'-9"
6"	16	1 3/8"	22'-3"
6"	14	1 3/8"	23'-10"
8"	20	1 3/8"	21'-10"
8"	18	1 3/8"	25'-11"
8"	16	1 3/8"	27'-11"
8"	14	1 3/8"	30'-2"

* WEB STIFFENERS REQUIRED


INTERIOR NON-BEARING WALL OPENING FRAMING SCHEDULE

W' WIDTH	JAMBS	HEADER	SILL
4'-0"	SINGLE STUD * 15 A8.1	TRACK 14 A8.1	TRACK 4 A8.1
8'-0"	DOUBLE STUD 15 A8.1	TRACK & STUD 13 A8.1	TRACK 4 A8.1
12'-0"	DOUBLE STUD 15 A8.1	2 TRACK & STUD 17 A8.1	TRACK & STUD 12 A8.1
16'-0"	TRIPLE STUD 15 A8.1	3 TRACK & 2 STUD 18 A8.1	2 TRACK & STUD 8 A8.1


* USE DOUBLE STUD MINIMUM AT DOOR OPENINGS

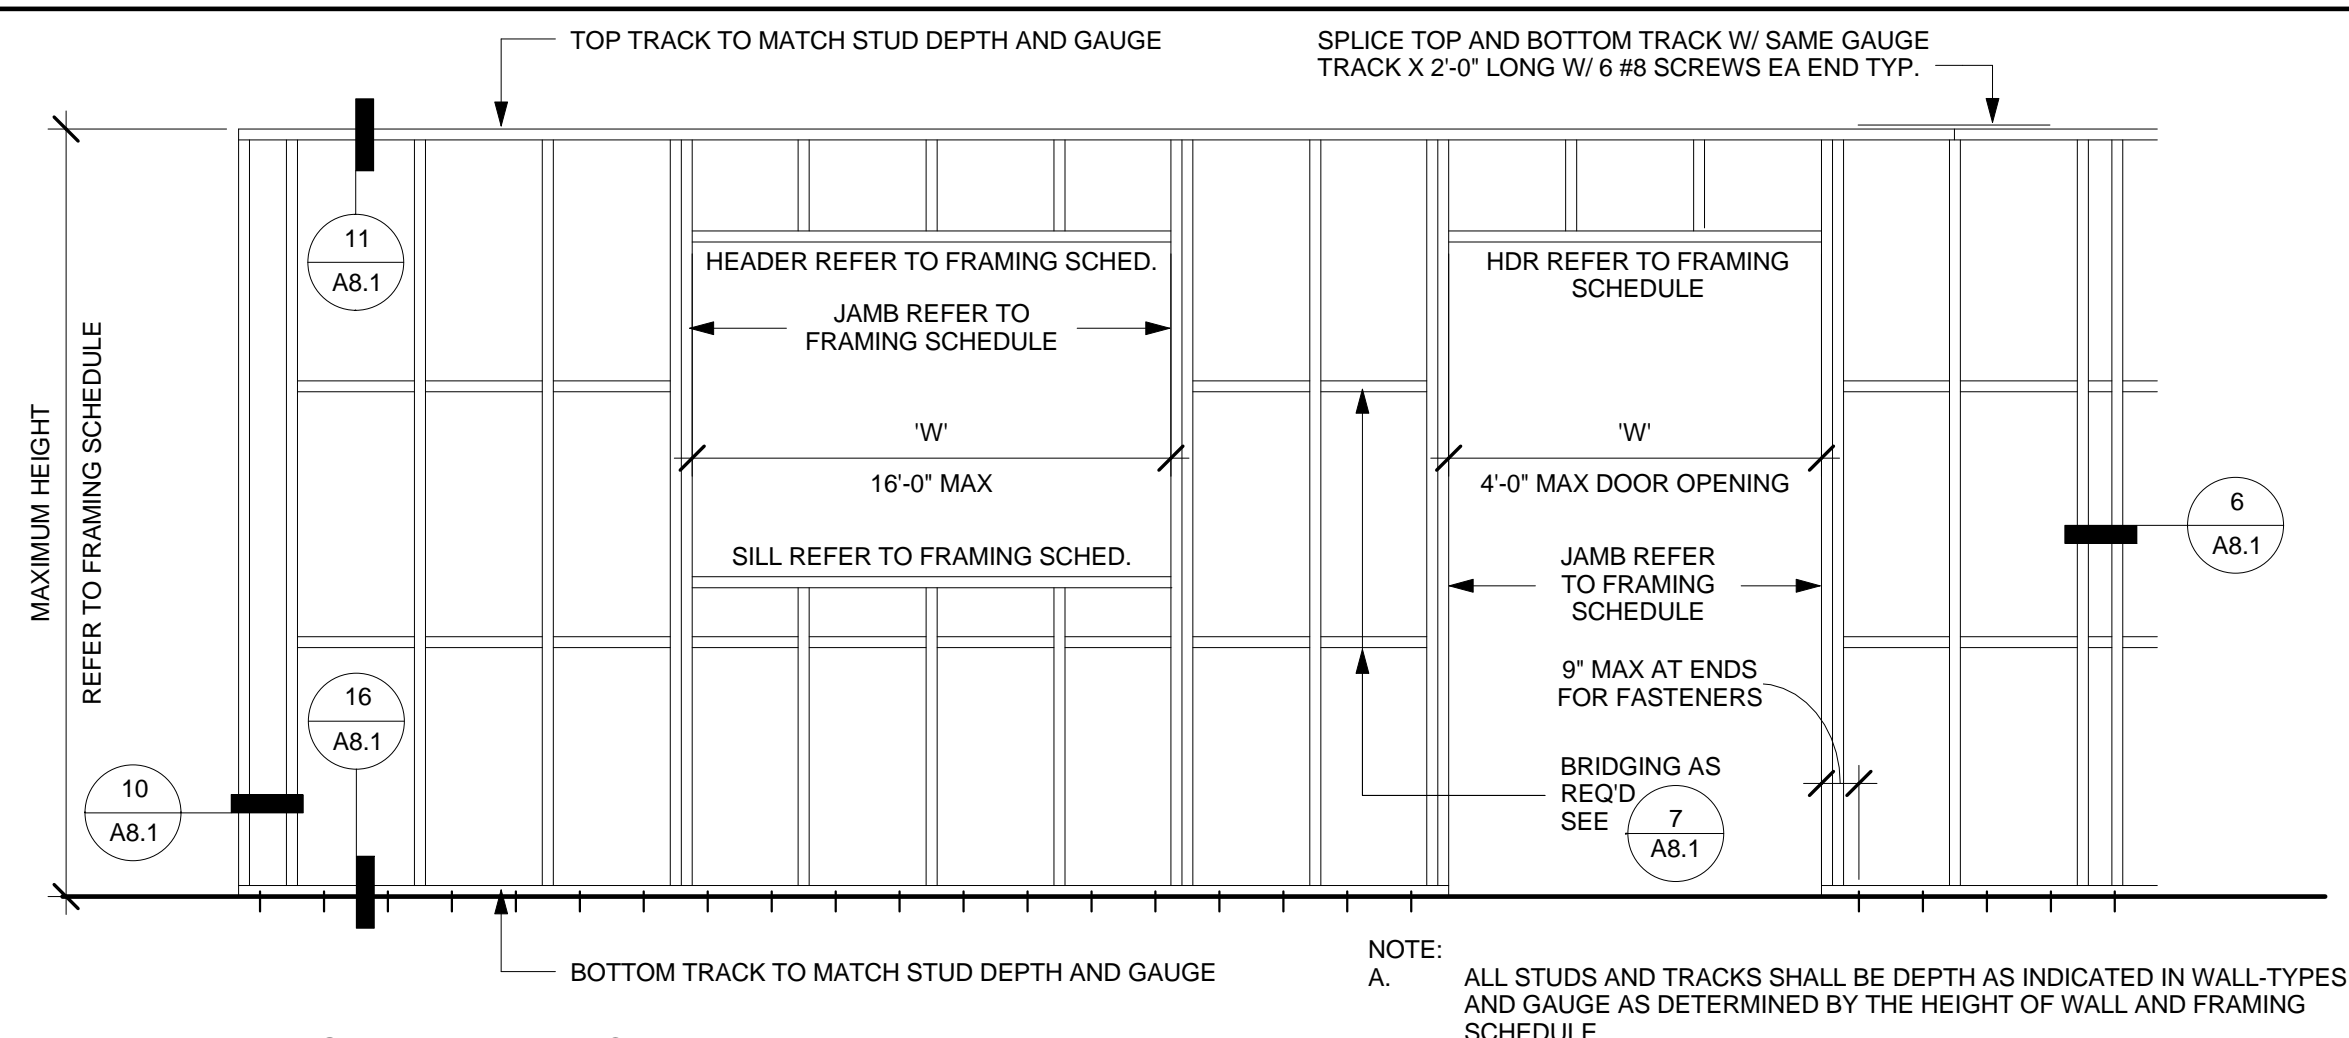


9 METAL FRAMING - WALL ELEVATION
1 1/2" = 1'-0"

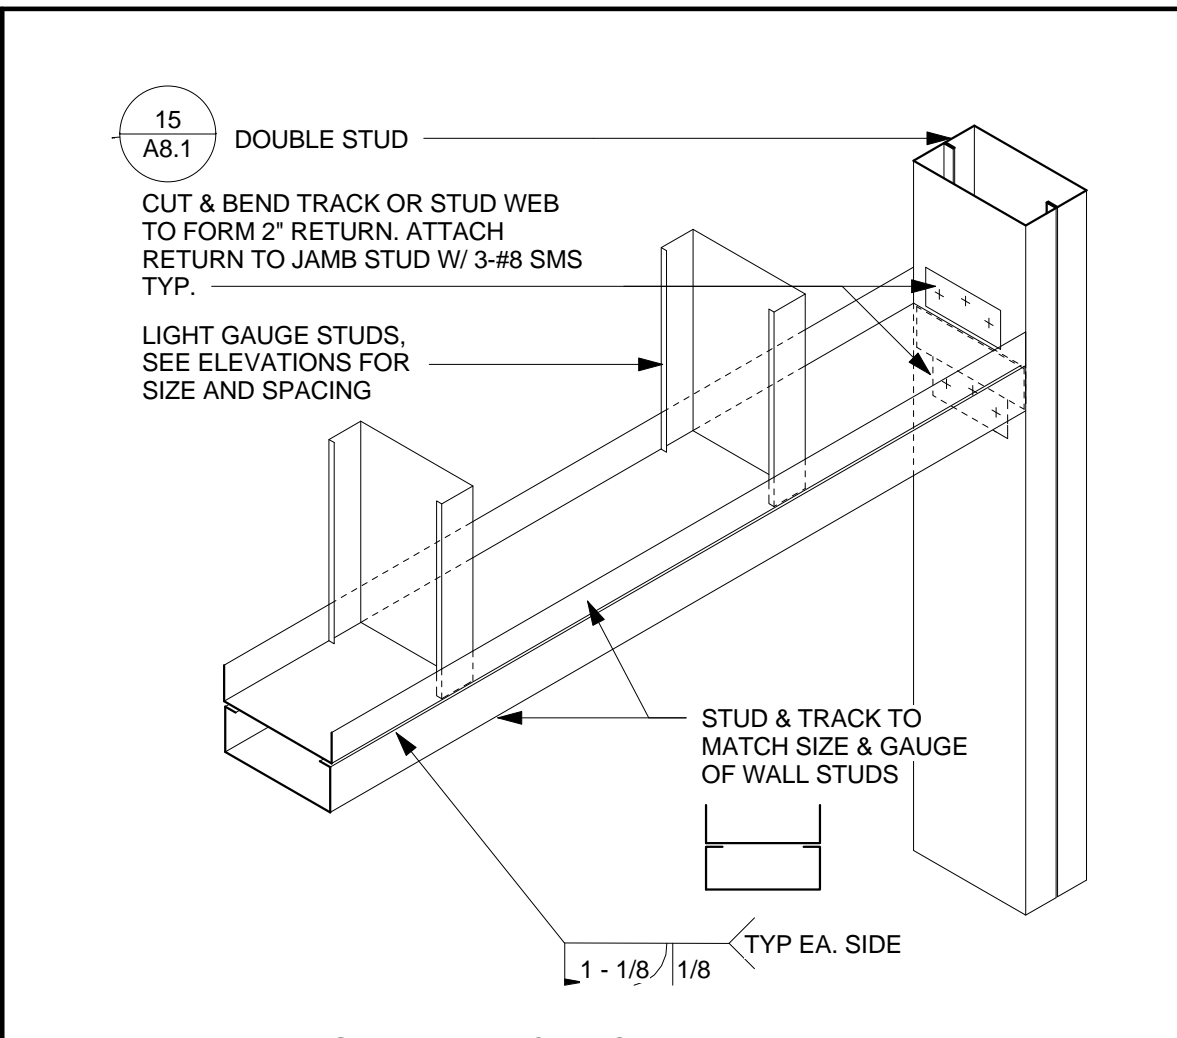


13 METAL FRAMING - HDR TRACK + STUD
1 1/2" = 1'-0"

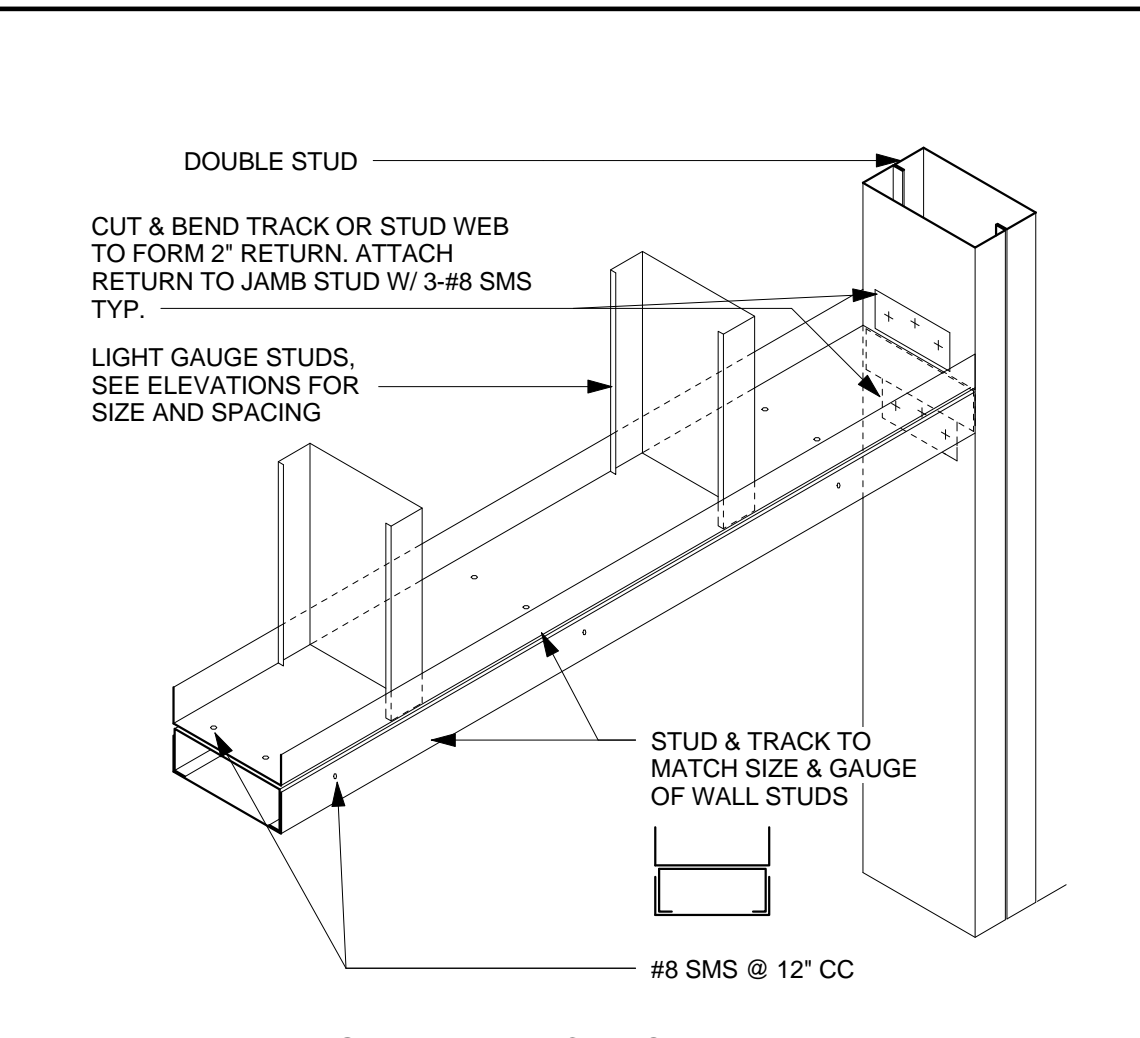


17 METAL FRAMING - HDR 2 TRACK + STUD
1 1/2" = 1'-0"

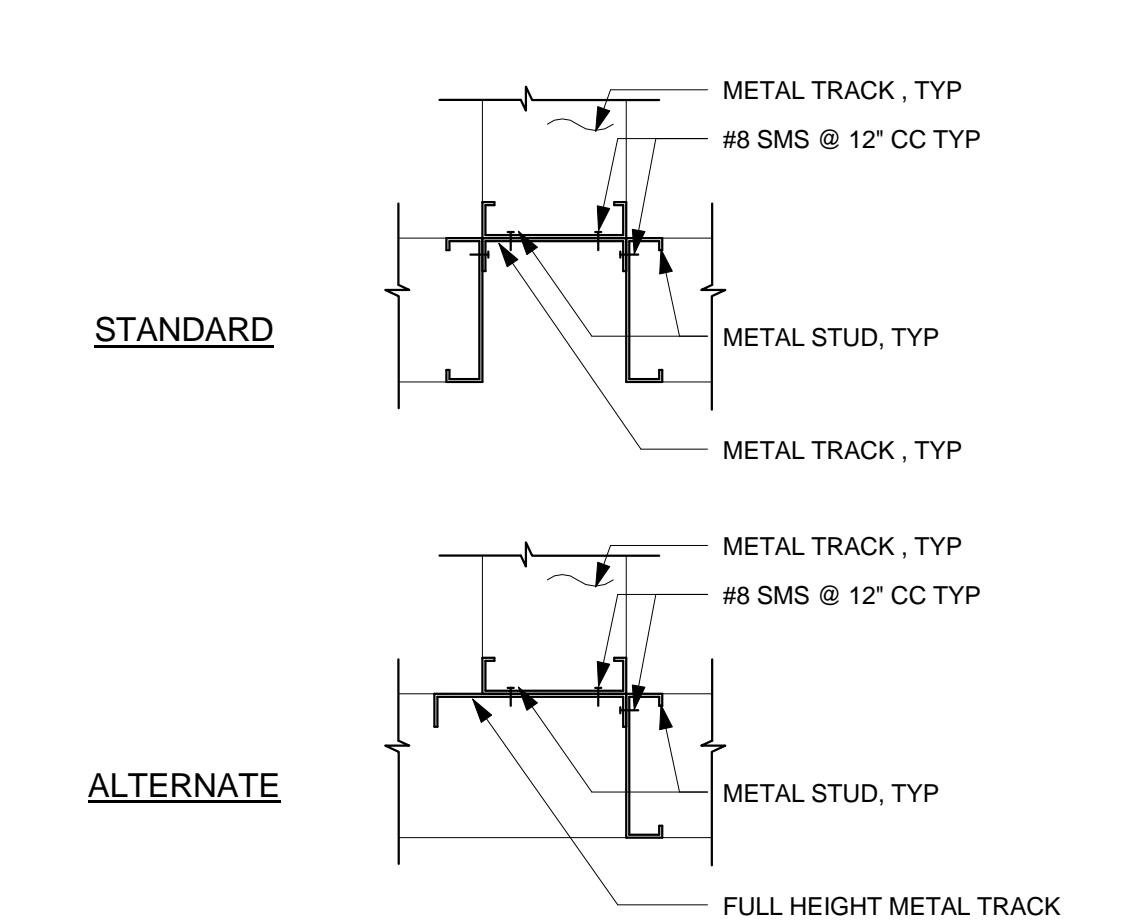


6 METAL FRAMING - WALL TEE
1 1/2" = 1'-0"

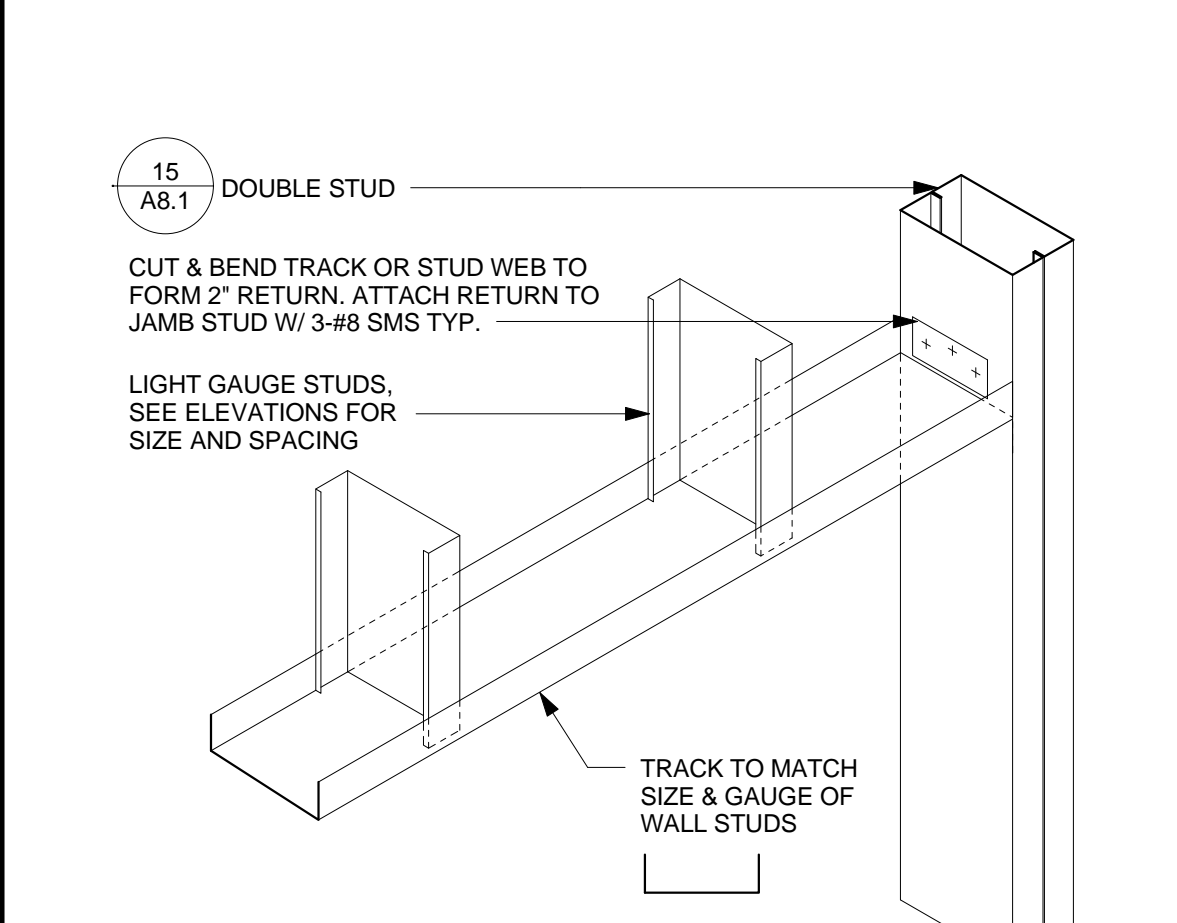

14 METAL FRAMING - HEADER TRACK
1 1/2" = 1'-0"

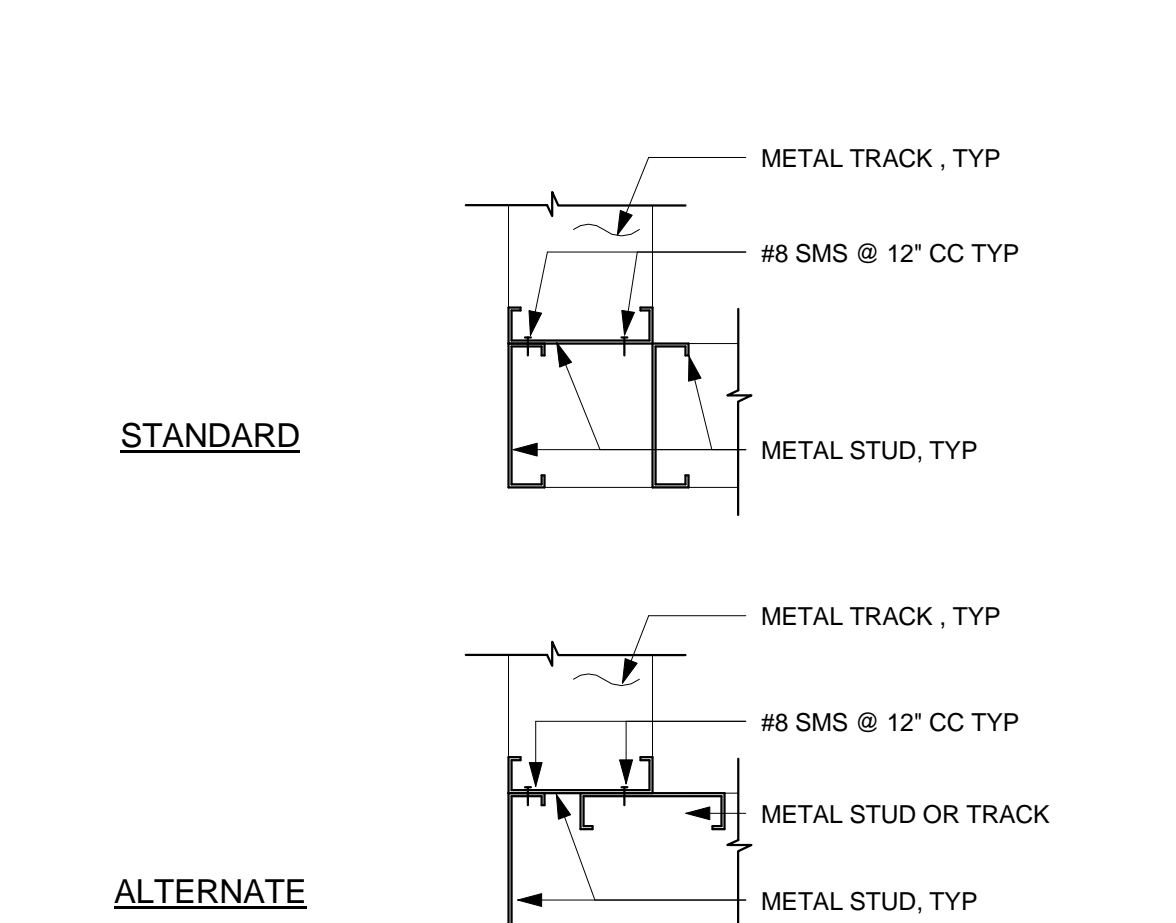


10 METAL FRAMING - WALL 'CORNER'
1 1/2" = 1'-0"

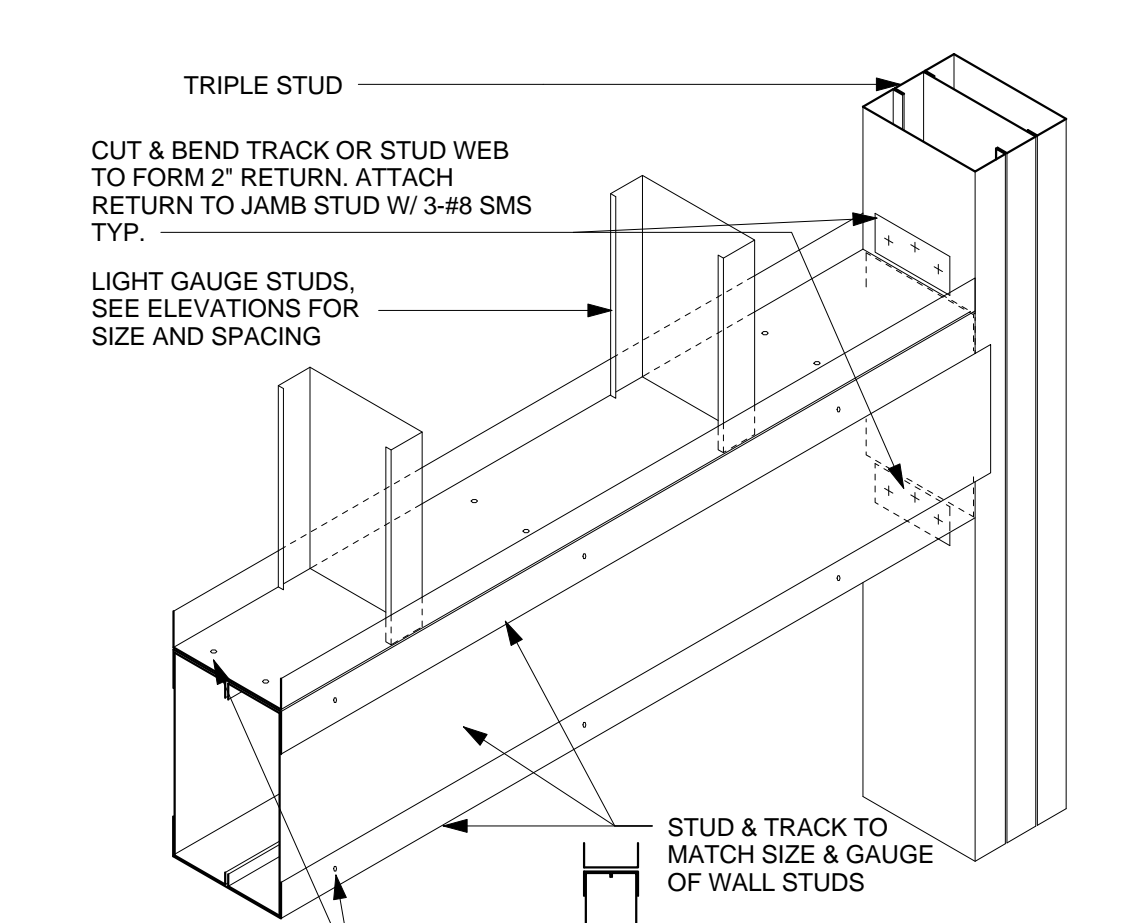


18 METAL FRAMING - HDR 3 TRACK + STUD
1 1/2" = 1'-0"


2 METAL FRAMING - FRAMING SCHEDULE
1 1/2" = 1'-0"

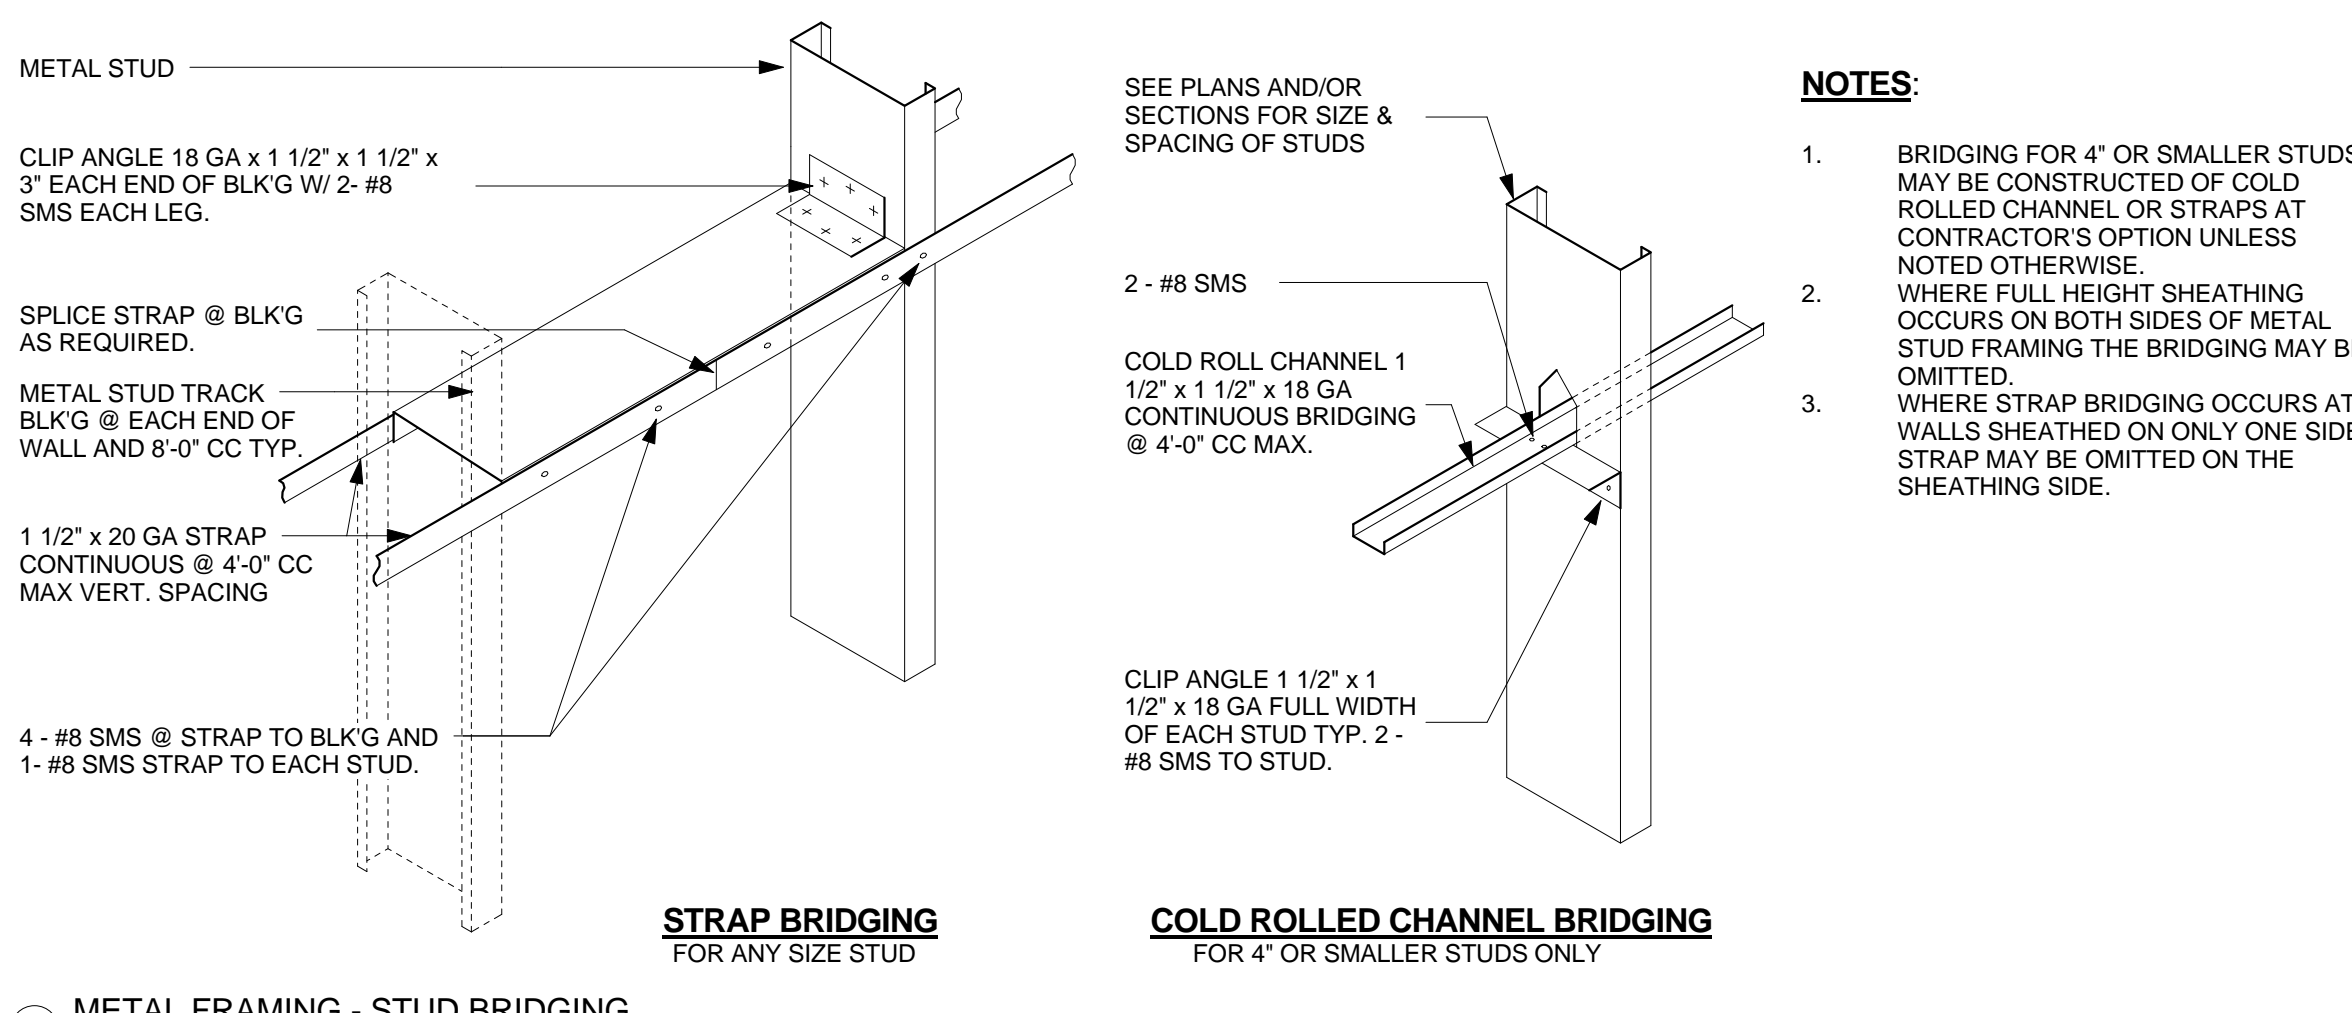


7 METAL FRAMING - STUD BRIDGING
1 1/2" = 1'-0"

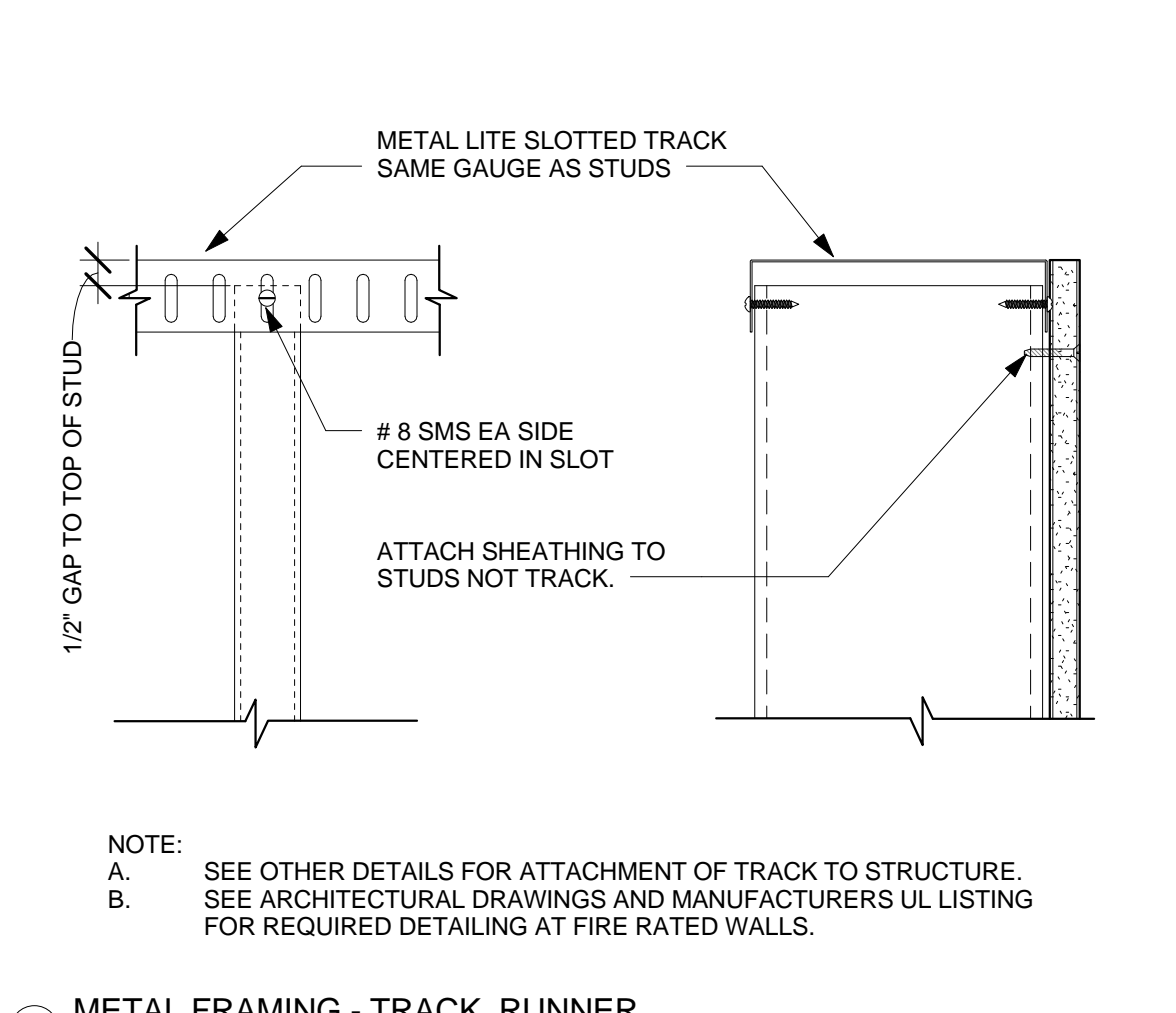


11 METAL FRAMING - TRACK RUNNER
3" = 1'-0"

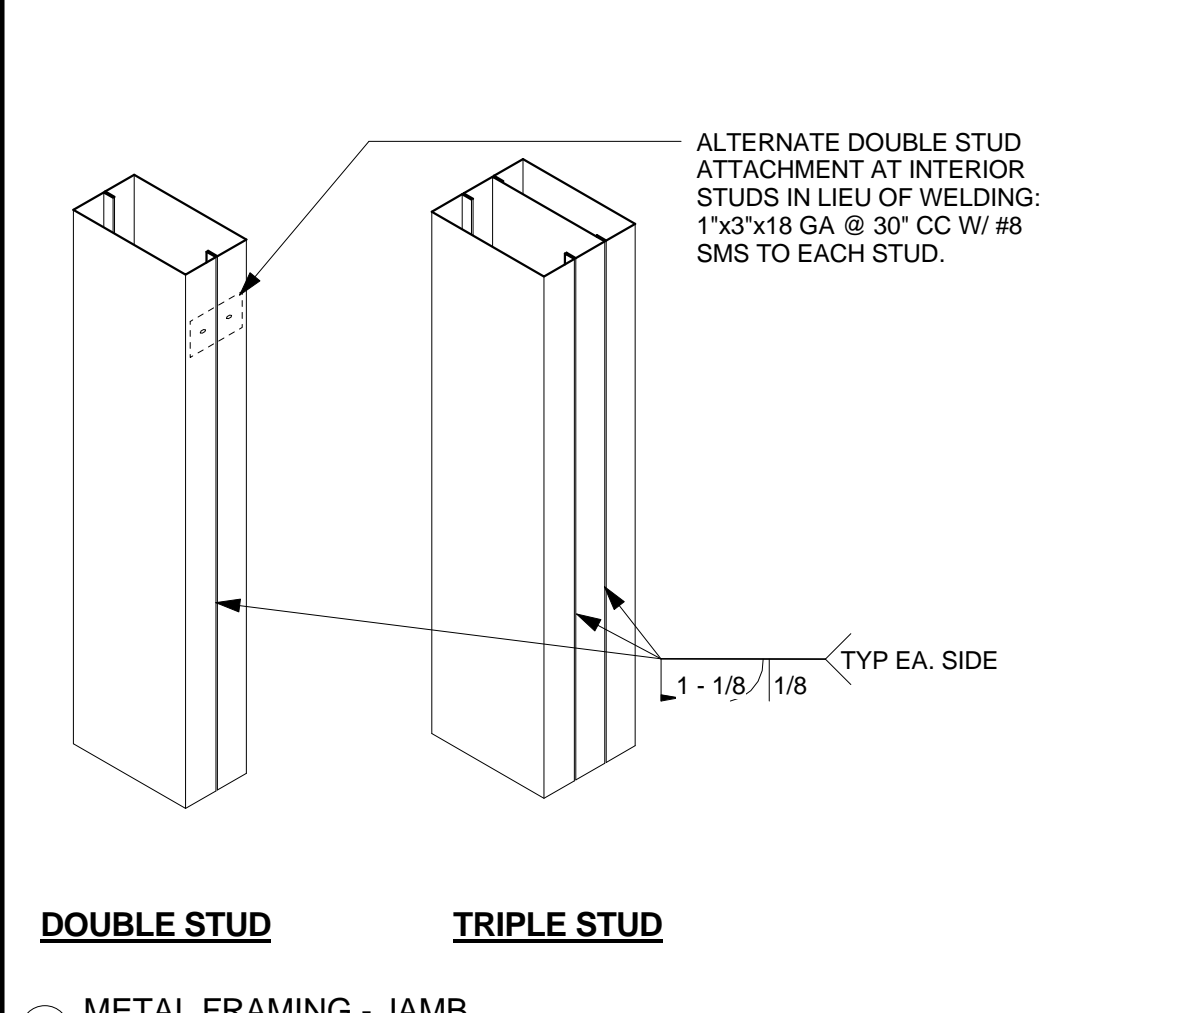


15 METAL FRAMING - JAMB
1 1/2" = 1'-0"

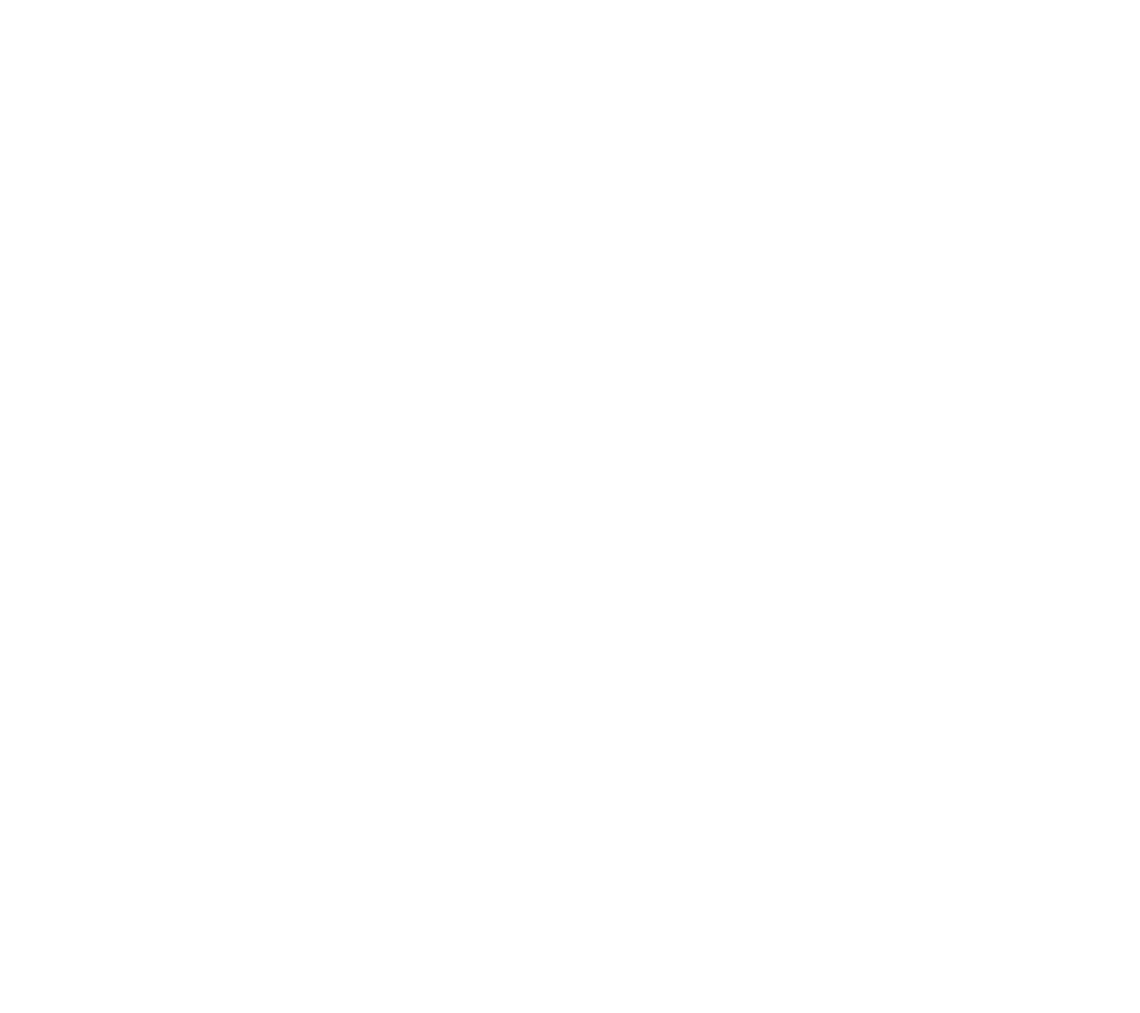


15 METAL FRAMING - JAMB
1 1/2" = 1'-0"

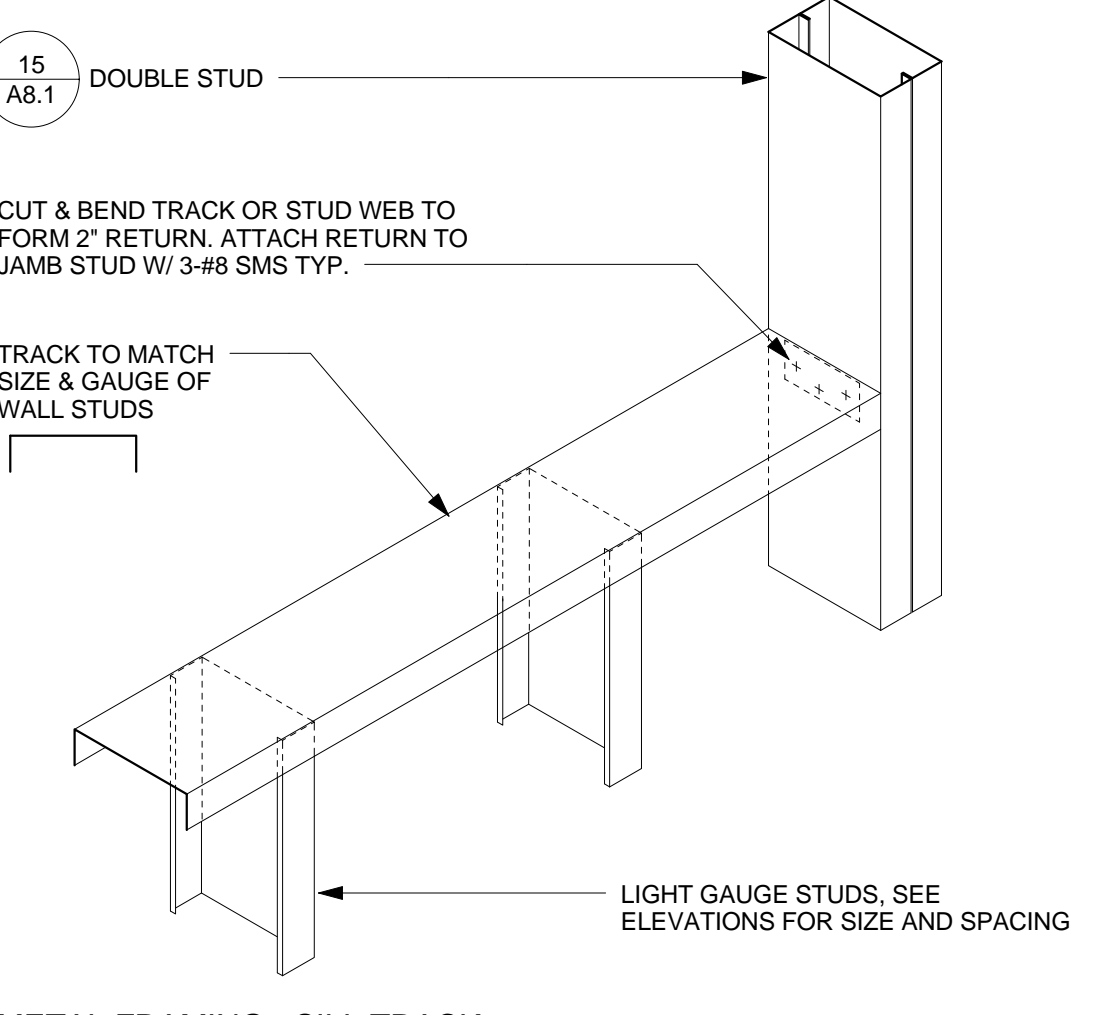


4 METAL FRAMING - SILL TRACK
1 1/2" = 1'-0"

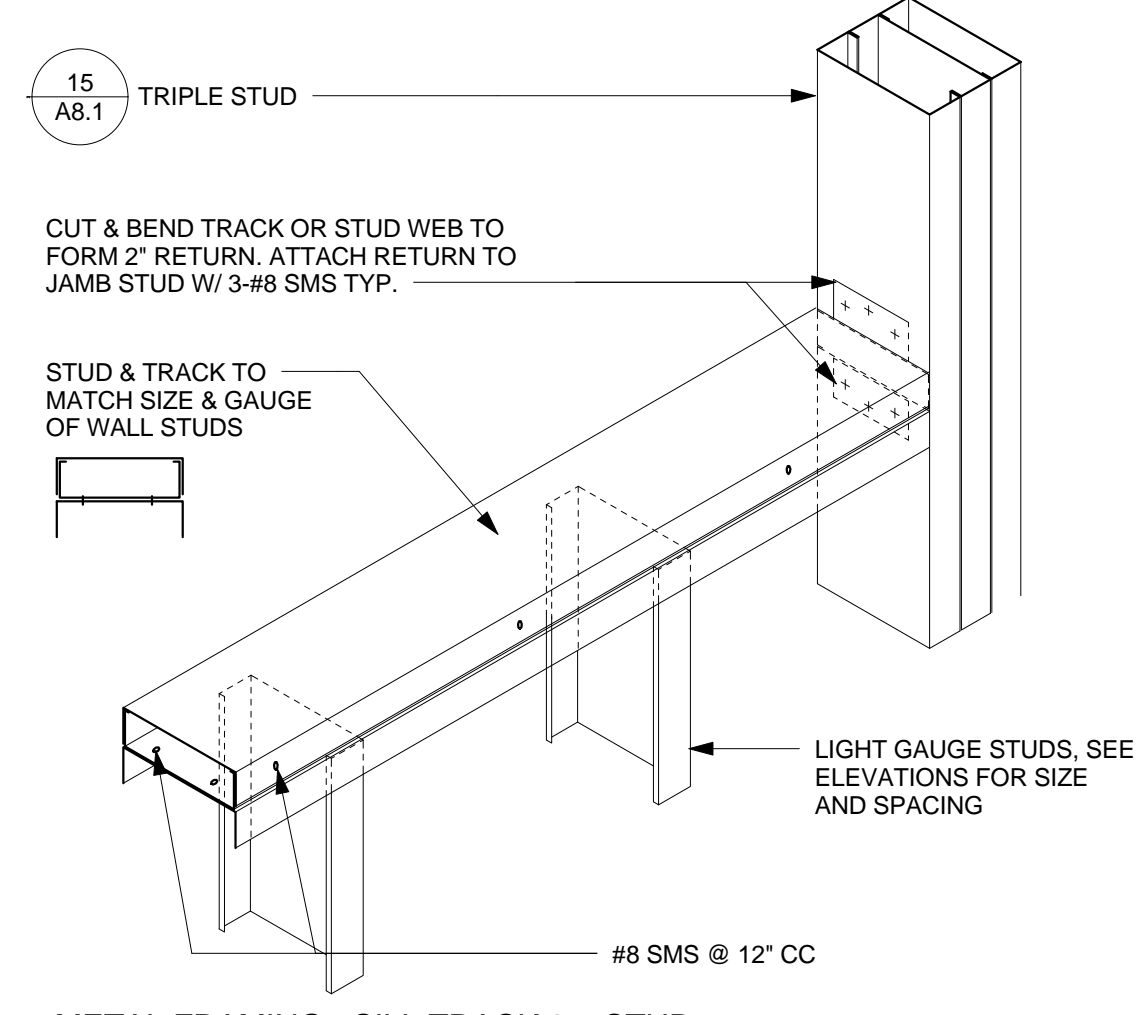


8 METAL FRAMING - SILL TRACK 2 + STUD
1 1/2" = 1'-0"

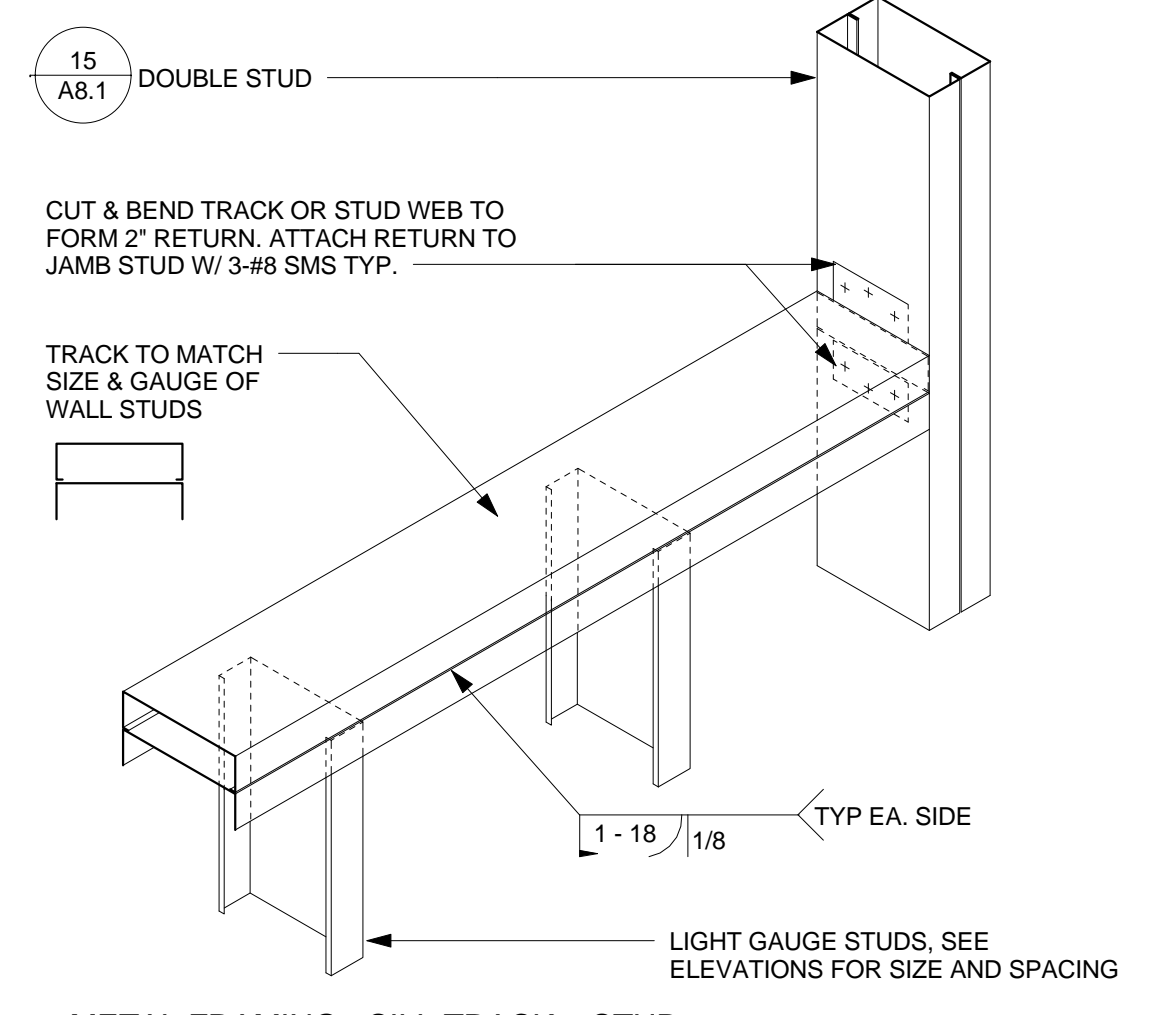


12 METAL FRAMING - SILL TRACK + STUD
1 1/2" = 1'-0"

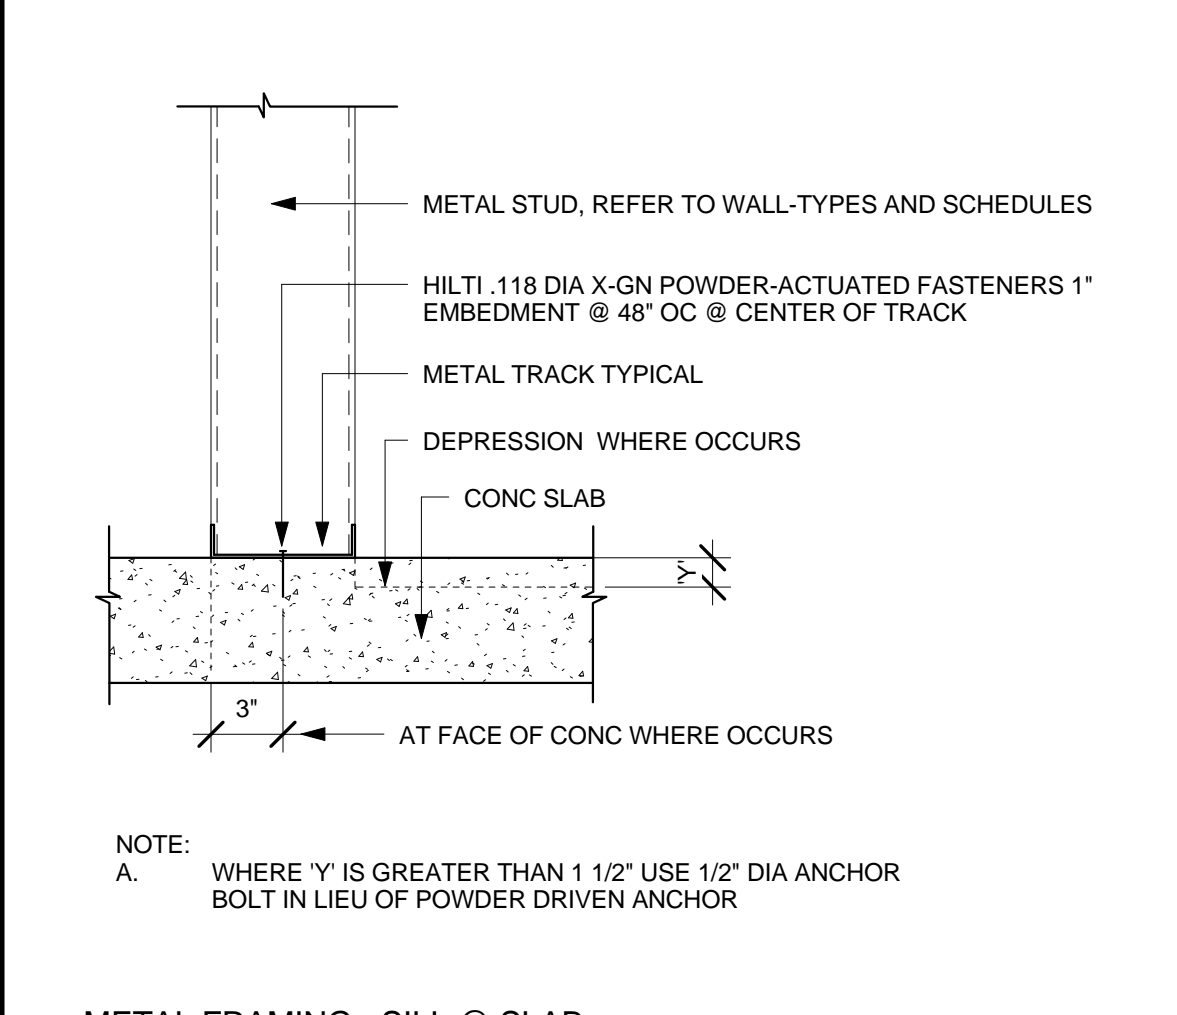

16 METAL FRAMING - SILL @ SLAB
1 1/2" = 1'-0"

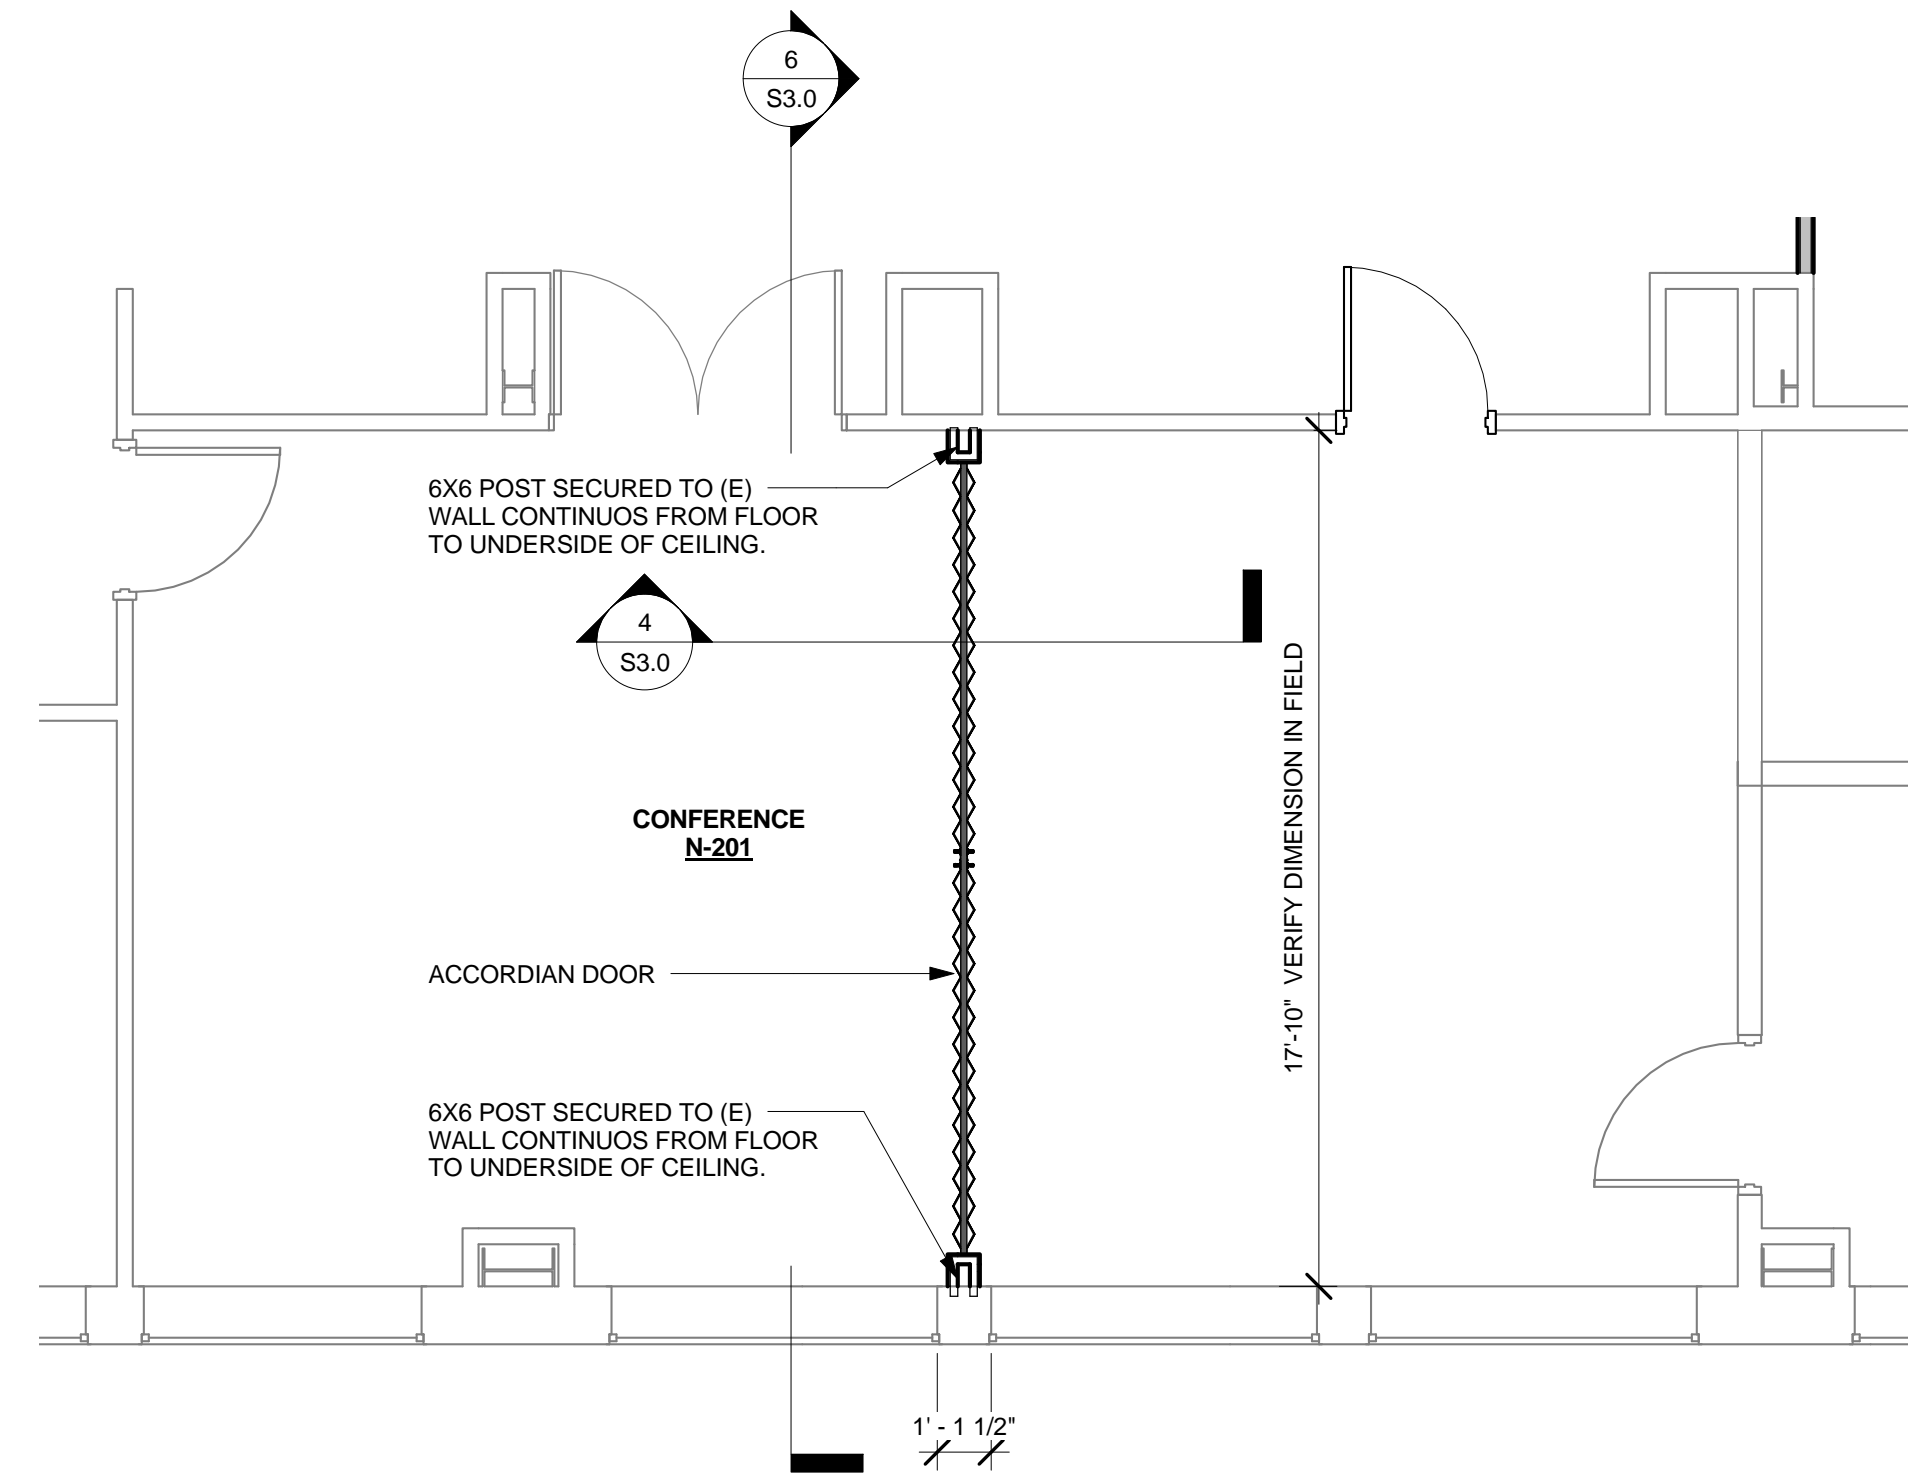

4 S-2ND FLOOR - ENLARGED PLAN CONF.
1/4" = 1'-0"

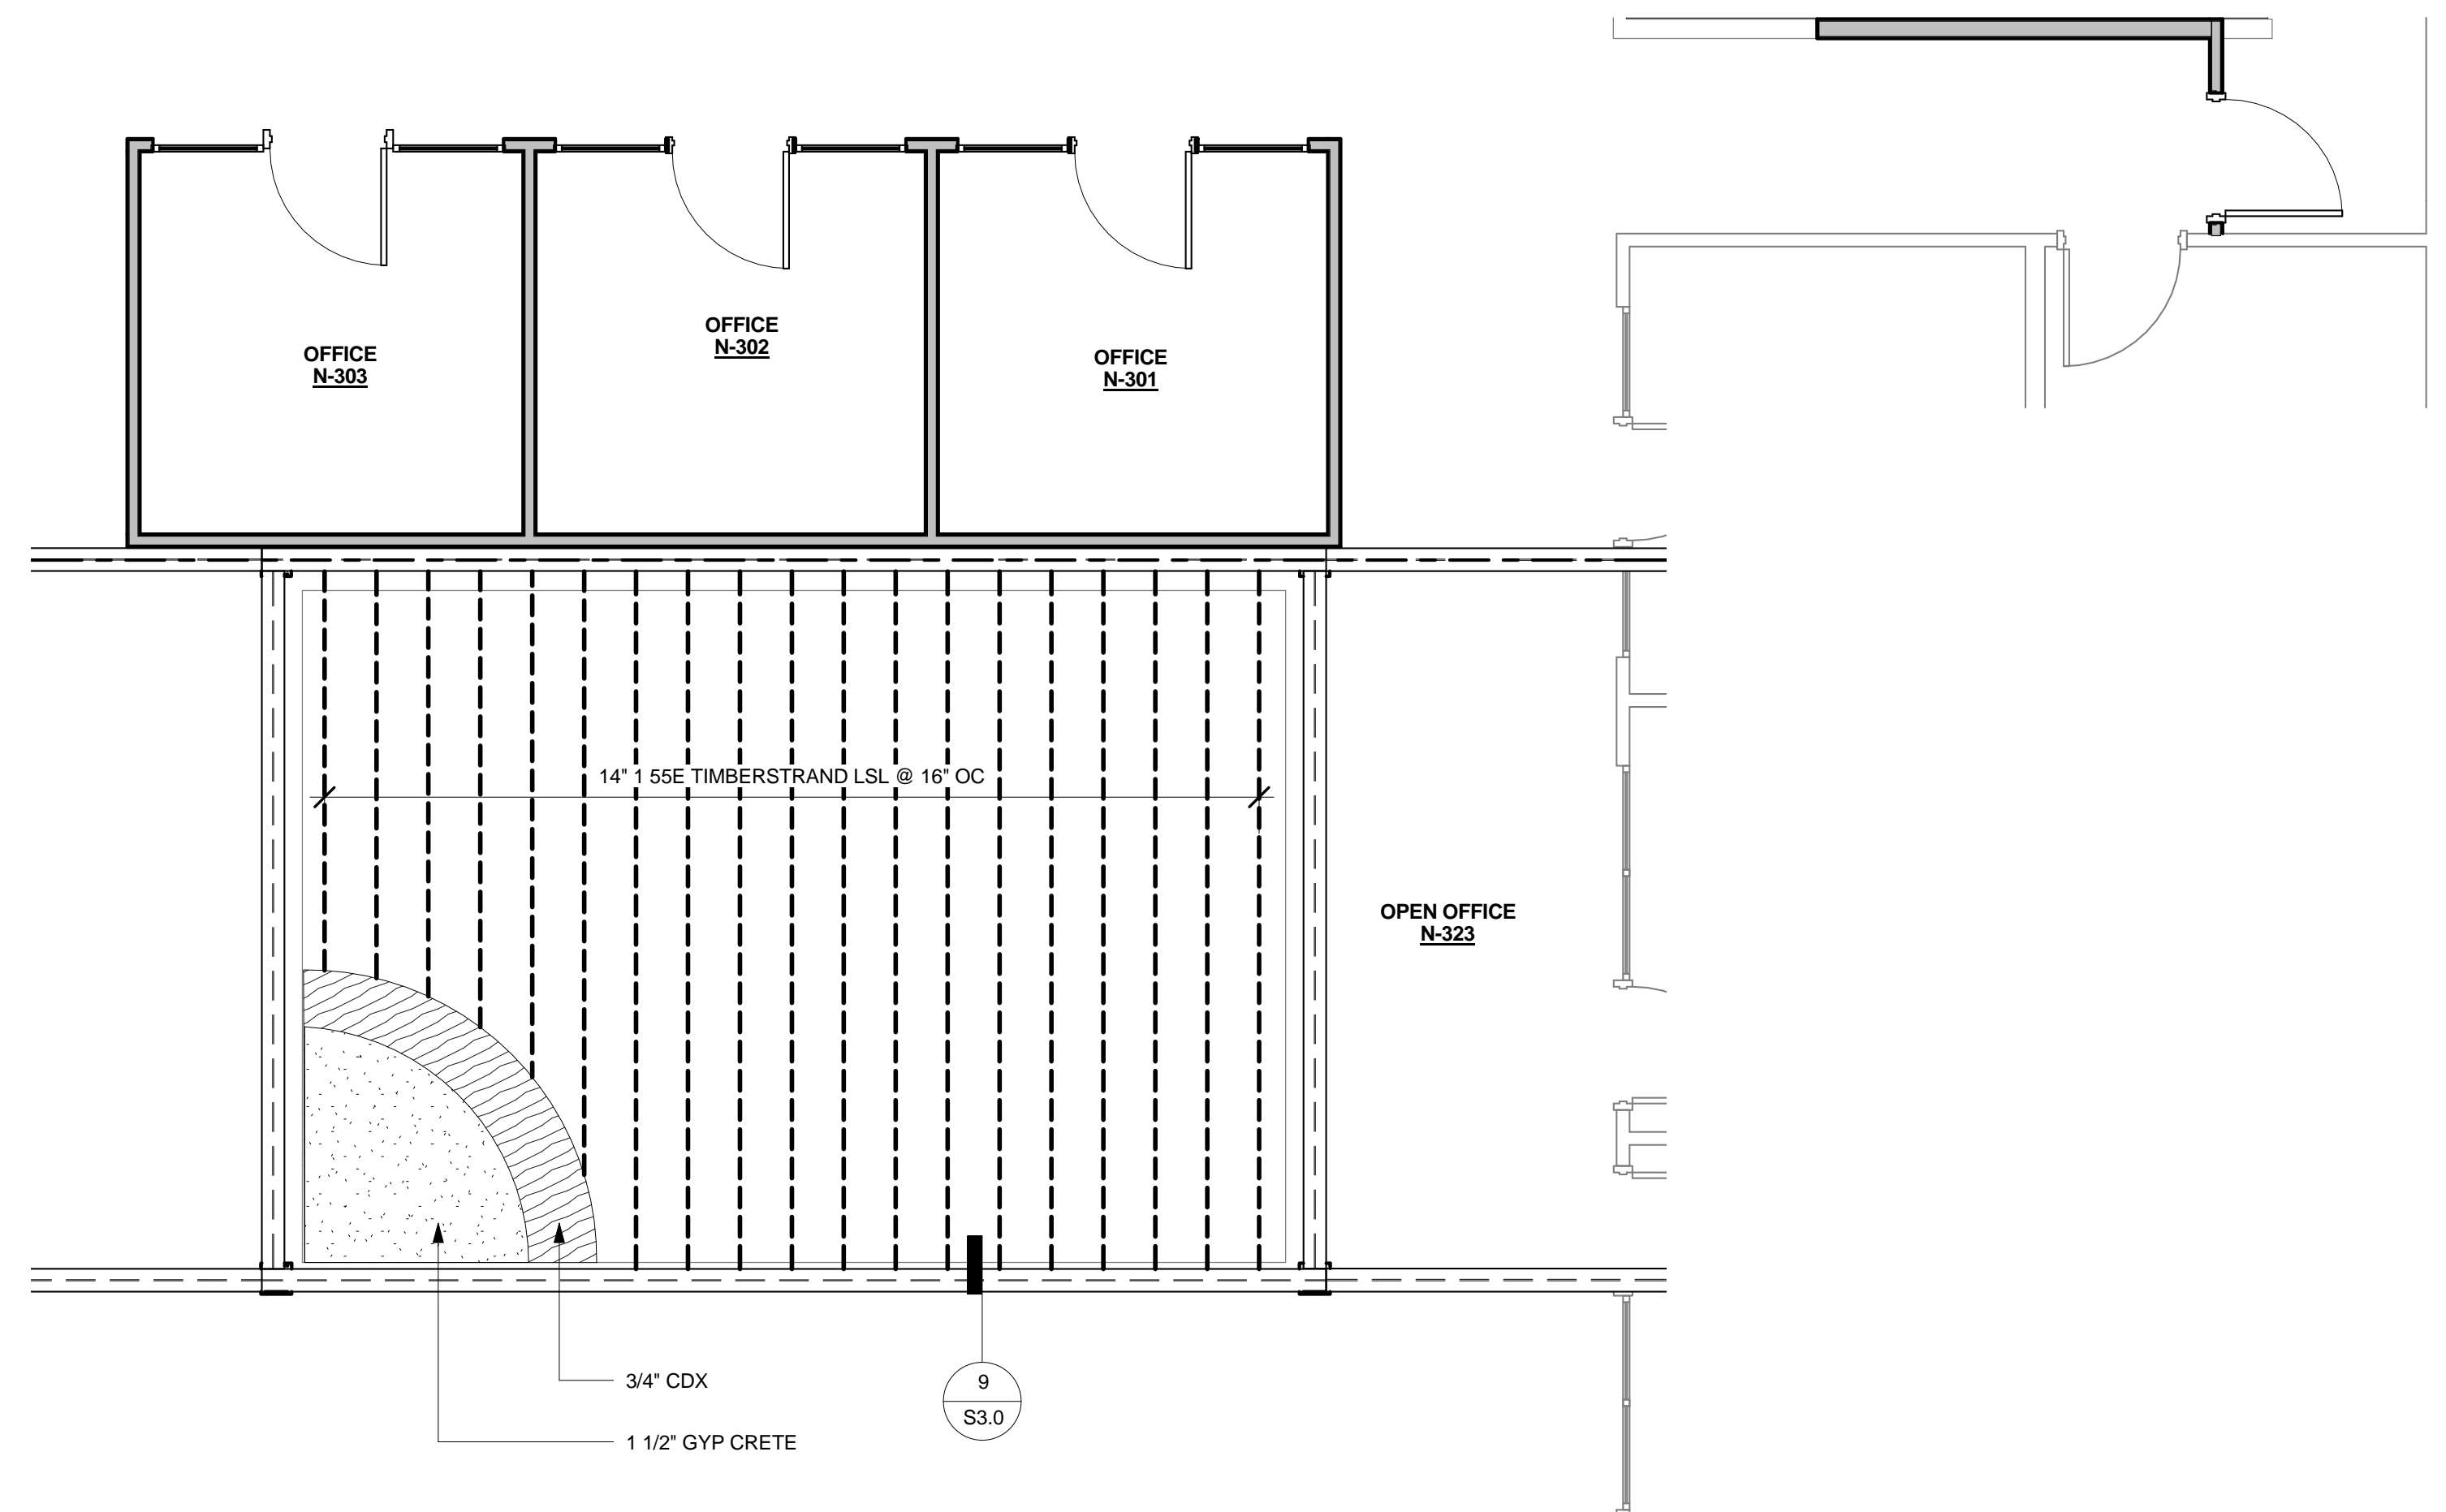

1 S-3RD FLOOR - ENLARGED OFFICE
1/4" = 1'-0"

LEGEND

- EXISTING WALL LOCATION
- NEW CONCRETE FOOTING LOCATION
- WOOD FRAMED WALL CONDITION CONSTRUCTED PER CRC SECTION R602
- 4 1/2 INCH R-CONTROL SIP'S WALL. PANEL WITH SURFACE OR BLOCK SPLINE, MIN. ALL PANEL TO BE PROVIDED WITH DOUBLE CAP AND TOP PLATE.
- SIP SHEAR WALL - 3'-0" WIDE SIP SHEARWALLS W/ 8d COMMONS @ 6" O.C. EN W/ HOLDDOWN TO DOUBLE 2X EACH END EACH SHEAR WALL. PROVIDE 2X CONT SILL W/ (2) 5/8" DIA ANCHOR BOLTS PER SHEAR WALL MIN. PLACE OUTSIDE OF QUARTER POINTS OF WALL LENGTH (SEE LATERAL ANALYSIS, PAGE 20 OF ENGINEERS CALCULATIONS FOR REQUIREMENTS)
- HOLDOWN LOCATION
USE: STHD8 / STHD8RJ - STRAP HOLDOWN TO DOUBLE 2X (HDU 2 MAY BE SUBSTITUTED)
- WOOD POST LOCATION. REFER TO SHEET S2.0 FOR SIZES

GENERAL REQUIREMENTS

WOOD FLOOR FRAMING

- A. THE MINIMUM REQUIREMENTS FOR WOOD FLOOR FRAMING SHALL COMPLY WITH SECTION R501 - WOOD FLOOR FRAMING OF THE CRC. REFER TO FIGURE R502.2 FLOOR CONSTRUCTION FOR ADDITIONAL INFORMATION.
- B. DECK SHALL BE SELF SUPPORTING OR POSITIVELY ANCHORED TO THE STRUCTURE PER CRC SECTION R502.2.2. REFER TABLE R502.2.2.1 FOR FASTENER SPACING AND TO FIGURE 502.2.2.3 DECK ATTACHMENT FOR LATERAL LOADS FOR ADDITIONAL DETAILS INFORMATION.
- C. FLOOR JOIST SPANS SHALL BE IN ACCORDANCE WITH TABLE R502.3.1 (1) AND R502.3.1 (2) OF THE CRC.
- D. PROVIDE 1 1/2" MINIMUM BEARING @ JOIST ENDS. R502.6
- E. 2" FULL DEPTH SOLID BLOCKING REQUIRED FOR LATERAL SUPPORT UNDER WALLS AND AT ENDS OF JOIST. R502.7
- F. NOTCHING ON ENDS OF JOIST SHALL NOT EXCEED 1/6 OF JOIST DEPTH. BORED HOLES SHALL NOT BE GREATER THAN 1/3 OF JOIST DEPTH AND SHALL NOT BE WITHIN 2" OF TOP OR BOTTOM OF JOIST. REFER TO FIGURE R502.8 OF CRC.
- G. FLOOR FRAMING SHALL BE NAILED IN ACCORDANCE NAILING CRC TABLE R602.3 (1) FASTENER SCHEDULE FOR STRUCTURAL MEMBERS.

WOOD WALL CONSTRUCTION


- A. THE MINIMUM REQUIREMENTS FOR WOOD WALL FRAMING SHALL COMPLY WITH SECTION R602 - WOOD WALL FRAMING OF THE CRC.
- B. NAILING SHALL BE IN ACCORDANCE WITH CRC TABLE R602.3 (1) THROUGH R602.3 (4) FASTENER SCHEDULE FOR STRUCTURAL MEMBERS.
- C. WALL FRAMING SIZE, HEIGHT AND SPACING SHALL BE IN ACCORDANCE WITH TABLE R602.3 OF THE CRC.
- D. WOOD STUD WALLS SHALL BE CAPPED WITH A DOUBLE TOP PLATE PER R602.3.2 OF THE CRC AND INSTALLED TO PROVIDED OVERLAPPING AT CORNERS AND INTERSECTIONS WITH BEARING PARTITIONS. END JOINTS OF TOP PLATES SHALL OVERLAP A MINIMUM OF 24 INCHES.
- E. BEARING STUDS SHALL BE SPACED SUCH THAT MEMBERS BEAR WITHIN 5 INCHES OF THE STUD BENEATH. CRC SECTION R602.3.3
- F. STUDS SHALL HAVE FULL BEARING ON A 2X OR LARGER BOTTOM PLATE OR SILL. WIDTH OF PLATE SHALL BE EQUAL TO OR GREATER THAN STUD DEPTH.
- G. INTERIOR LOAD BEARING WALLS SHALL BE CONSTRUCTED, FRAMED AND FIREBLOCKED AS SPECIFIED FOR EXTERIOR WALLS. CRC SECTION 602.4
- H. INTERIOR NON BEARING WALLS SHALL BE CONSTRUCTED IN ACCORDANCE WITH CRC SECTION R602.5.
- I. ANY BEARING STUD MAY BE CUT OR NOTCHED TO A DEPTH NOT EXCEEDING 25% OF THE STUD WIDTH. ANY NON-BEARING STUD MAY BE CUT OR NOTCHED TO A DEPTH NOT EXCEEDING 40% OF THE STUD WIDTH. CRC SECTION R602.6
- J. ANY STUD MAY BE BORED OR DRILLED PROVIDED THE DIAMETER OF THE RESULTING HOLE DOES NOT EXCEED 60% OF THE STUD WIDTH AND IS A MIN. OF 6" FROM THE EDGE OF THE STUD. EXTERIOR OR BEARING STUDS DRILLED OR BORED BETWEEN 40% AND 60% OF THE STUD WIDTH SHALL BE DOUBLED WITH NO MORE THAN TWO SUCCESSIVE DOUBLE STUDS BORED.
- K. PROVIDE A MINIMUM OF 3 STUDS AT CORNER OF EXTERIOR WALLS.
- L. PROVIDE HEADERS PER TABLE R502.5 (1) AND R502.5 (2).
- M. HEADERS AND LINTELS SHALL BE SUPPORTED BY A MINIMUM OF 1 1/2" BEARING ON EACH SIDE.
- N. WHERE PIPES PENETRATE THE SOLES OR WALL PLATE PROVIDE 1 1/2" WIDE 16 GAGE GALVANIZED TIES ON BOTH SIDES ATTACHED WITH A MIN. OF 8 10d NAILS.
- O. PROVIDE BRIDGING AT ALL INTERIOR AND EXTERIOR WALLS.
- P. WALLS SHALL BE BRACED PER CRC SECTION R602.10

STRUCTURAL INSULATED PANEL WALL CONSTRUCTION

- A. THE MINIMUM REQUIREMENTS FOR STRUCTURAL INSULATED PANEL WALL CONSTRUCTION SHALL COMPLY WITH SECTION R613 OF THE CRC AND INSTALLED PER THE MANUFACTURES INSTALLATION DETAILS.
- B. SCREWS USED TO ERECTION OF PANELS SHALL BE FABRICATED OF STEEL AND PROVIDED BY THE SIP'S MANUFACTURE R-CONTROL. THEY SHALL BE SIZED TO PENETRATE THE WOOD MEMBERS TO WHICH THE ASSEMBLY IS BEING ATTACHED A MIN. OF 1 INCH, BE CORROSION RESISTANT, HAVE A MIN SHANK DIAMETER OF .0188 INCHES, AND A MIN HEAD DIAMETER OF 0.620 INCHES. CRC R613.3.3.5
- C. ALL NAILS SHALL BE COMMON OR GALVANIZED BOX NAILS UNLESS OTHERWISE STATED. CRC R613.3.6
- D. SIP WALL PANELS SHALL HAVE A SOLID CORE WITH FACING ON EACH SIDE THAT IS FULLY ADHERED PER FIGURE R613.4 OF THE CRC. THICKNESS OF PANELS SHALL BE IN ACCORDANCE WITH TABLES R613.5 (1) AND R613.5 (2).
- E. PANELS SHALL BE LABELED WITH THE MANUFACTURES R-CONTROL NAME AND LOGO, IDENTIFICATION OF THE ASSEMBLY AND THE QUALITY ASSURANCE AGENCY. CRC 613.4.1

STRUCTURAL NOTES

- A. ALL WOOD FRAMED HEADERS TO BE 4x8 DF-L #2 U.N.O. OR 4 1-2" R-CONTROL SIP HEADER W/ 1'-0" MIN. HEADER DEPTH.
- B. NON-SIP EXTERIOR WALLS TO BE SHEETED WITH 3/8" STRUCTURAL PLYWOOD NAILED W/ 10d AT 6" O.C. AT EDGES AND AT 12" O.C. IN FIELD.

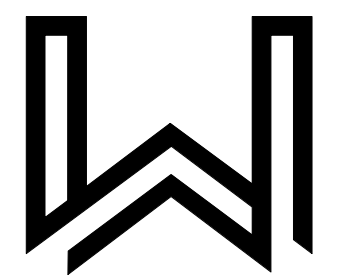

WALLIS DESIGN STUDIO
ARCHITECTURE

149 Crown Point Ct. Suite C
Grass Valley, CA 95945
(530) 264-7010
WallisDesignStudio.com

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Stamp:



Consultant:

CONSTRUCTION DOCUMENTS


Nevada County Facilities Department
NEVADA COUNTY PROBATION DEPARTMENT & PUBLIC DEFENDER
109 1/2 Pine Street
Nevada City, CA 95959
APN: 05-570-04

No.	Description	Date

Proj. No.: 2016015
Date: 08/03/2016
Scale: As indicated
Drawn By: JMT

S2.0

STRUCTURAL FRAMING

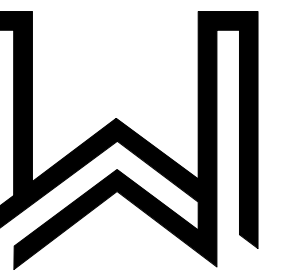


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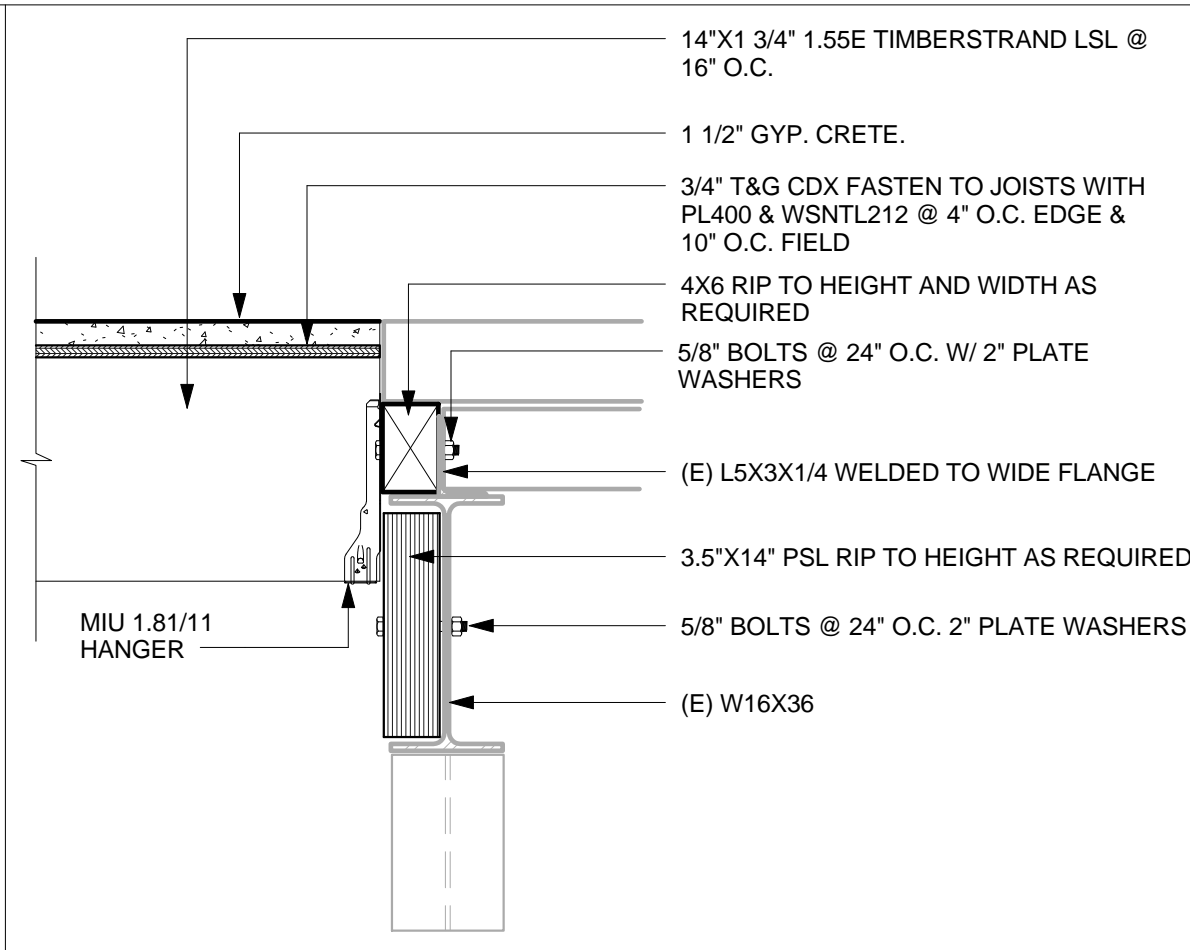
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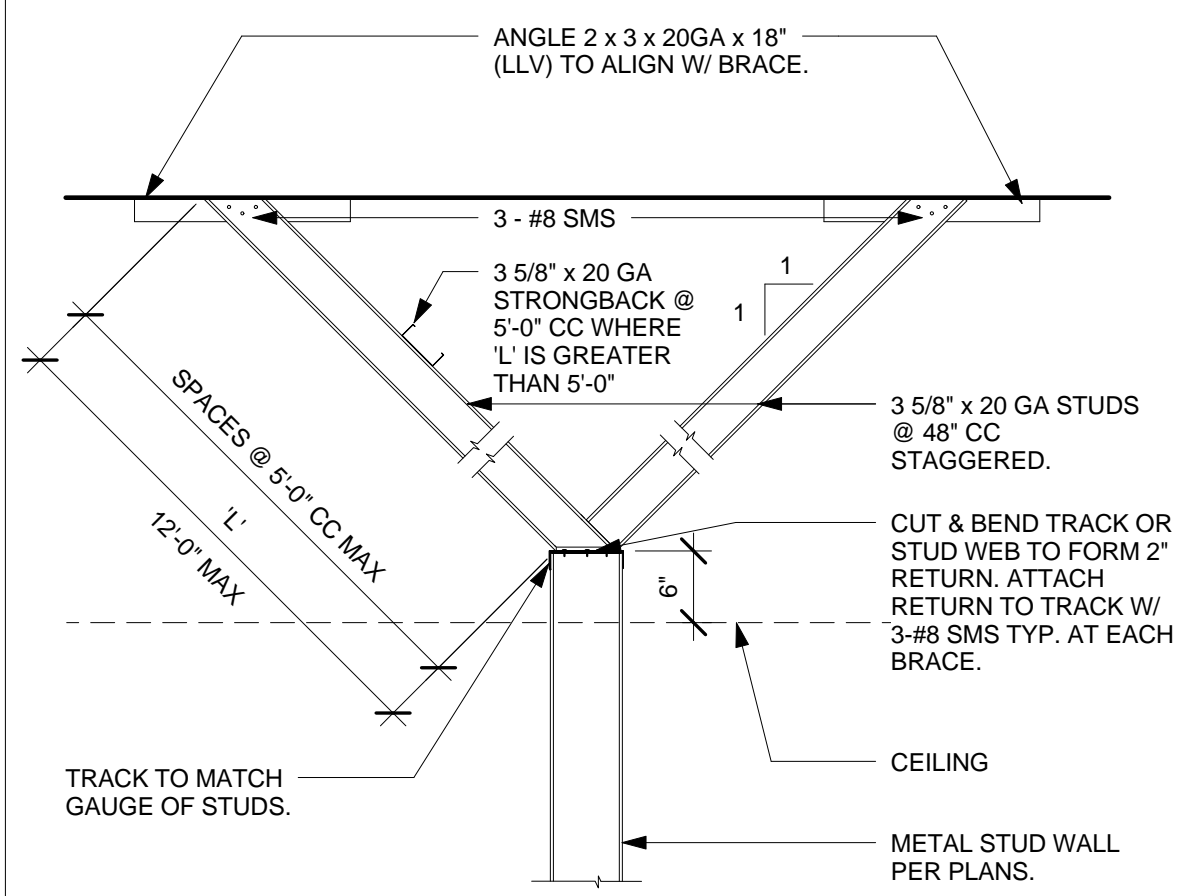
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Proj. No.: 2016015
Date: 08/03/2016
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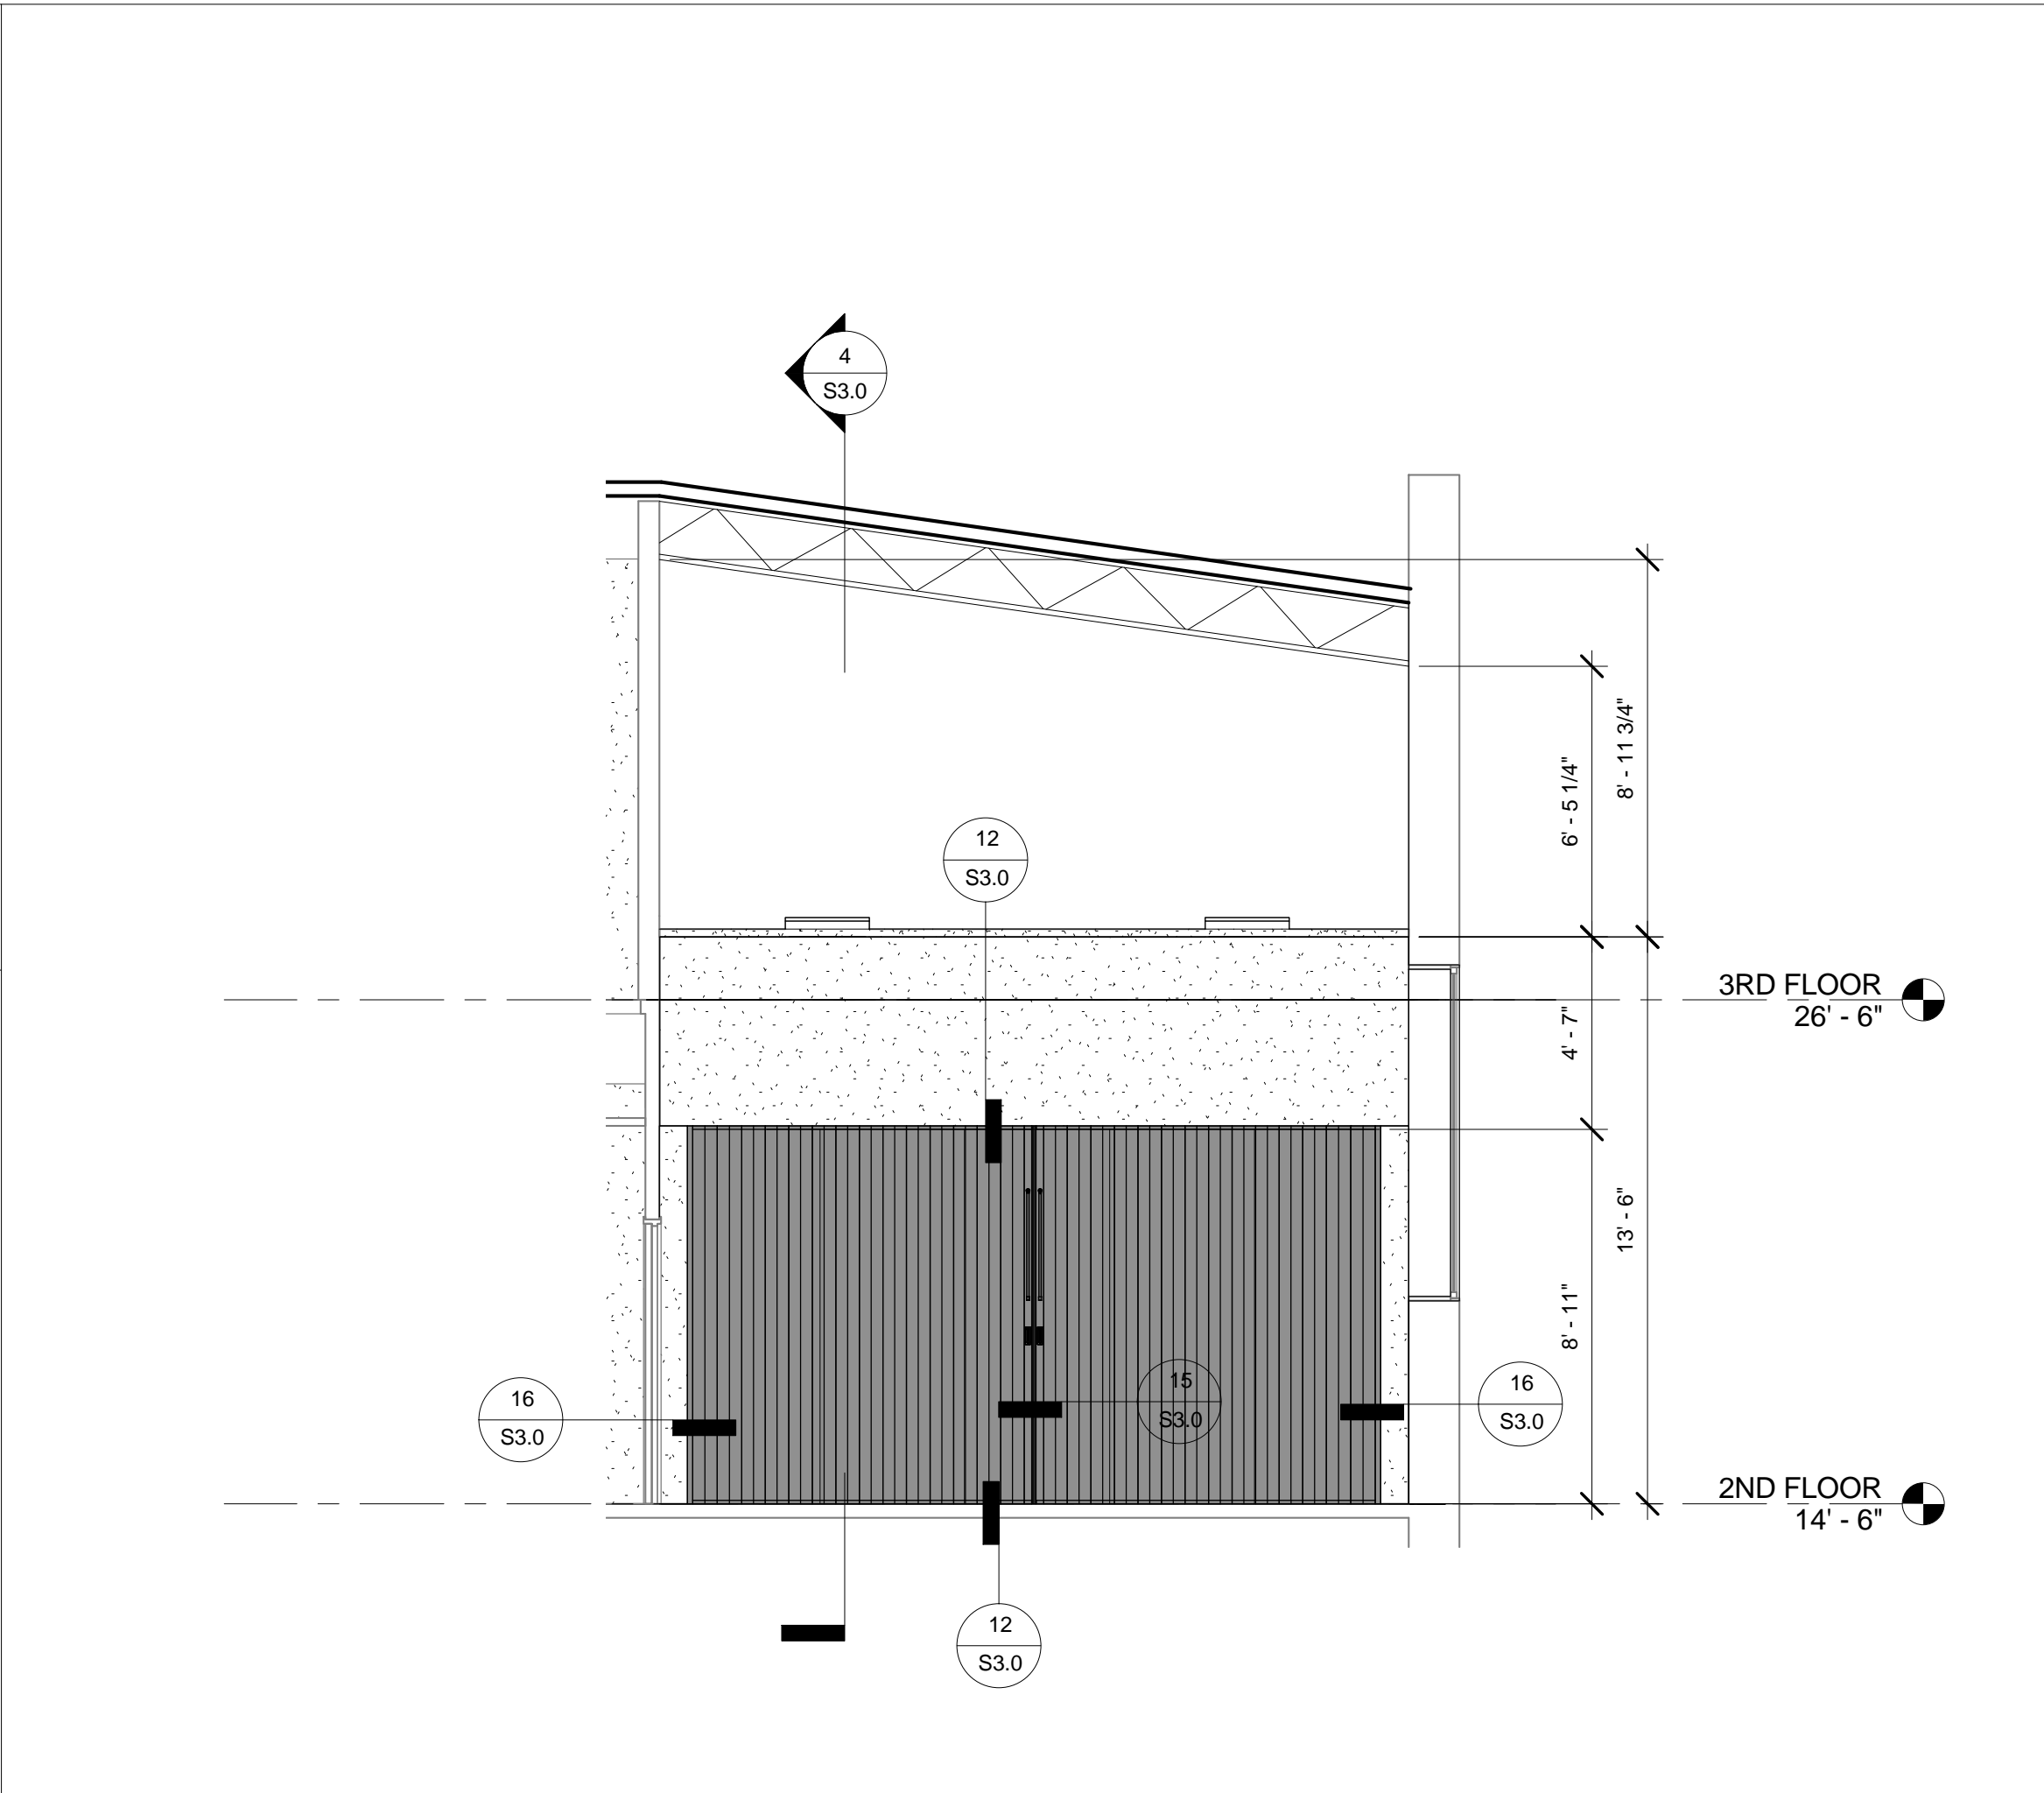
S3.0
STRUCTURAL DETAILS




9 FRM - (N) FLR TO (E) FLR
1" = 1'-0"

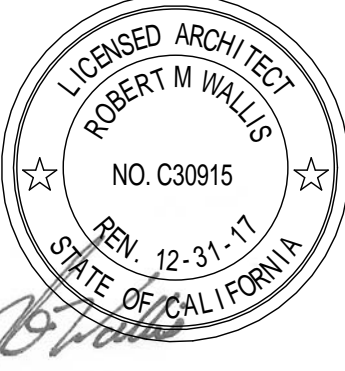


10 METAL FRAMING - WALL BRACING
3/4" = 1'-0"




6 S - CONFERENCE ROOM 201
1/4" = 1'-0"

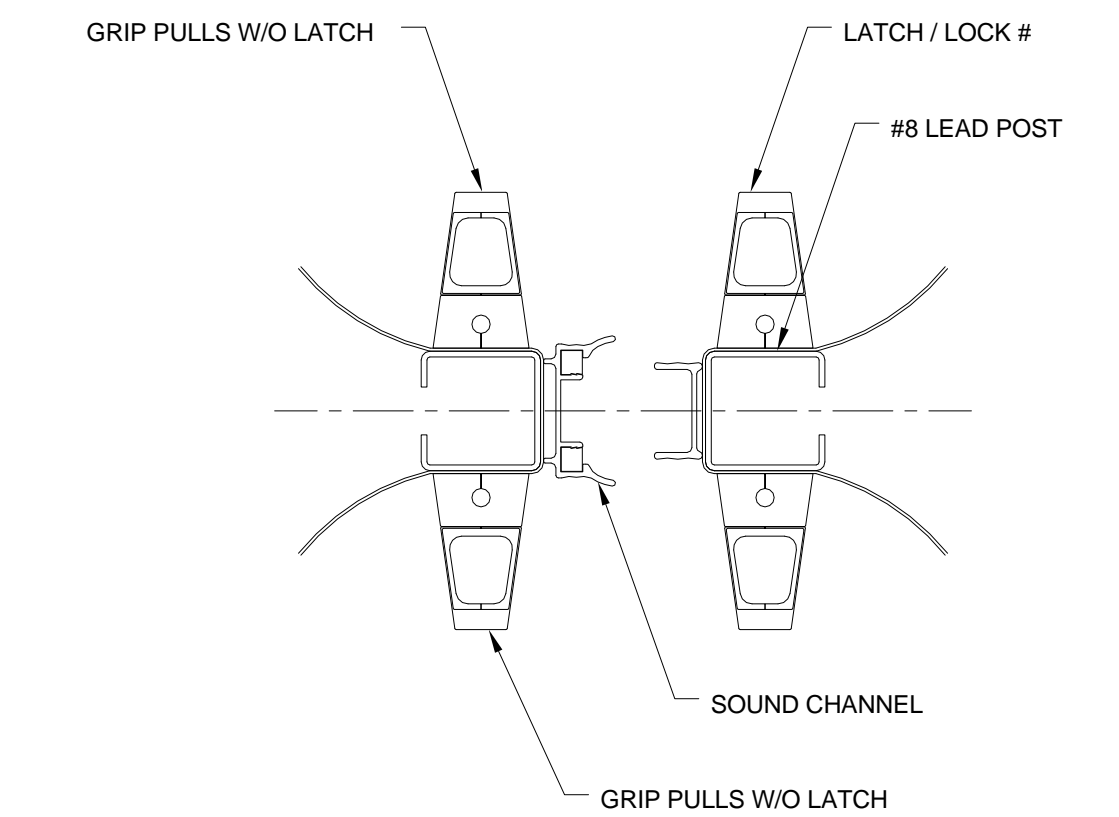


15 MFA - SM8 MEETING POST DETAIL
3" = 1'-0"

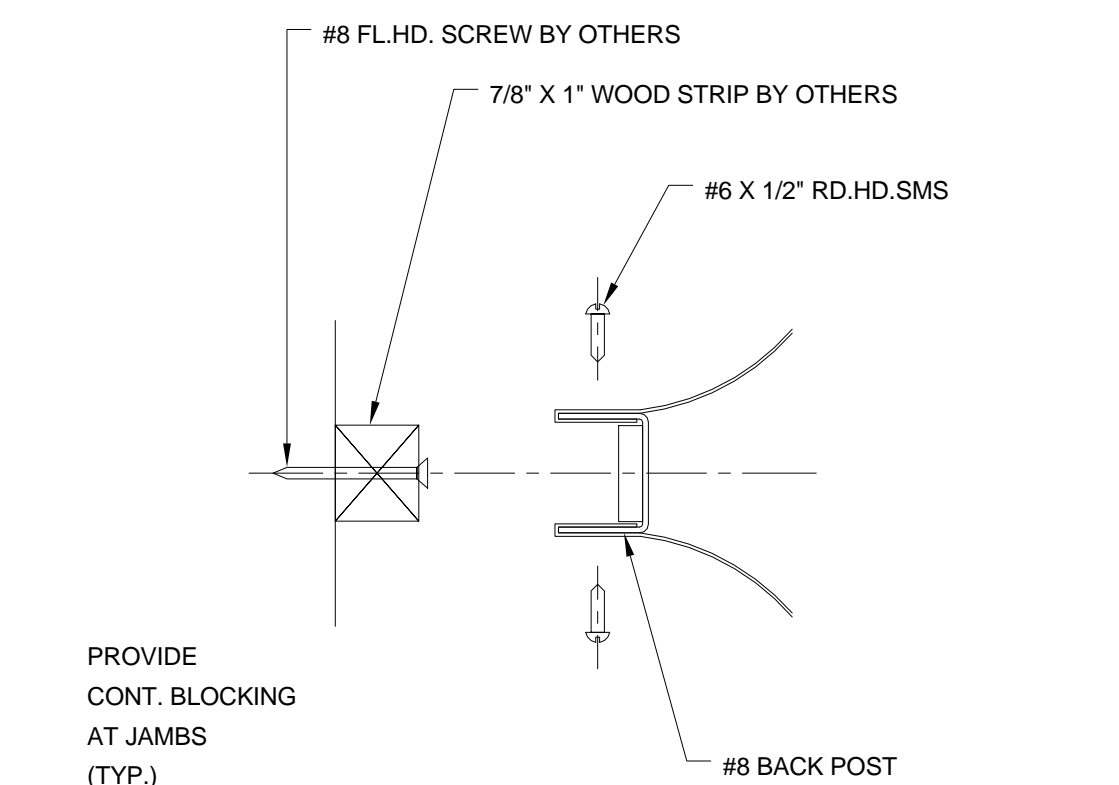

16 MFA - SM8 FIXED JAMB DETAIL
3" = 1'-0"

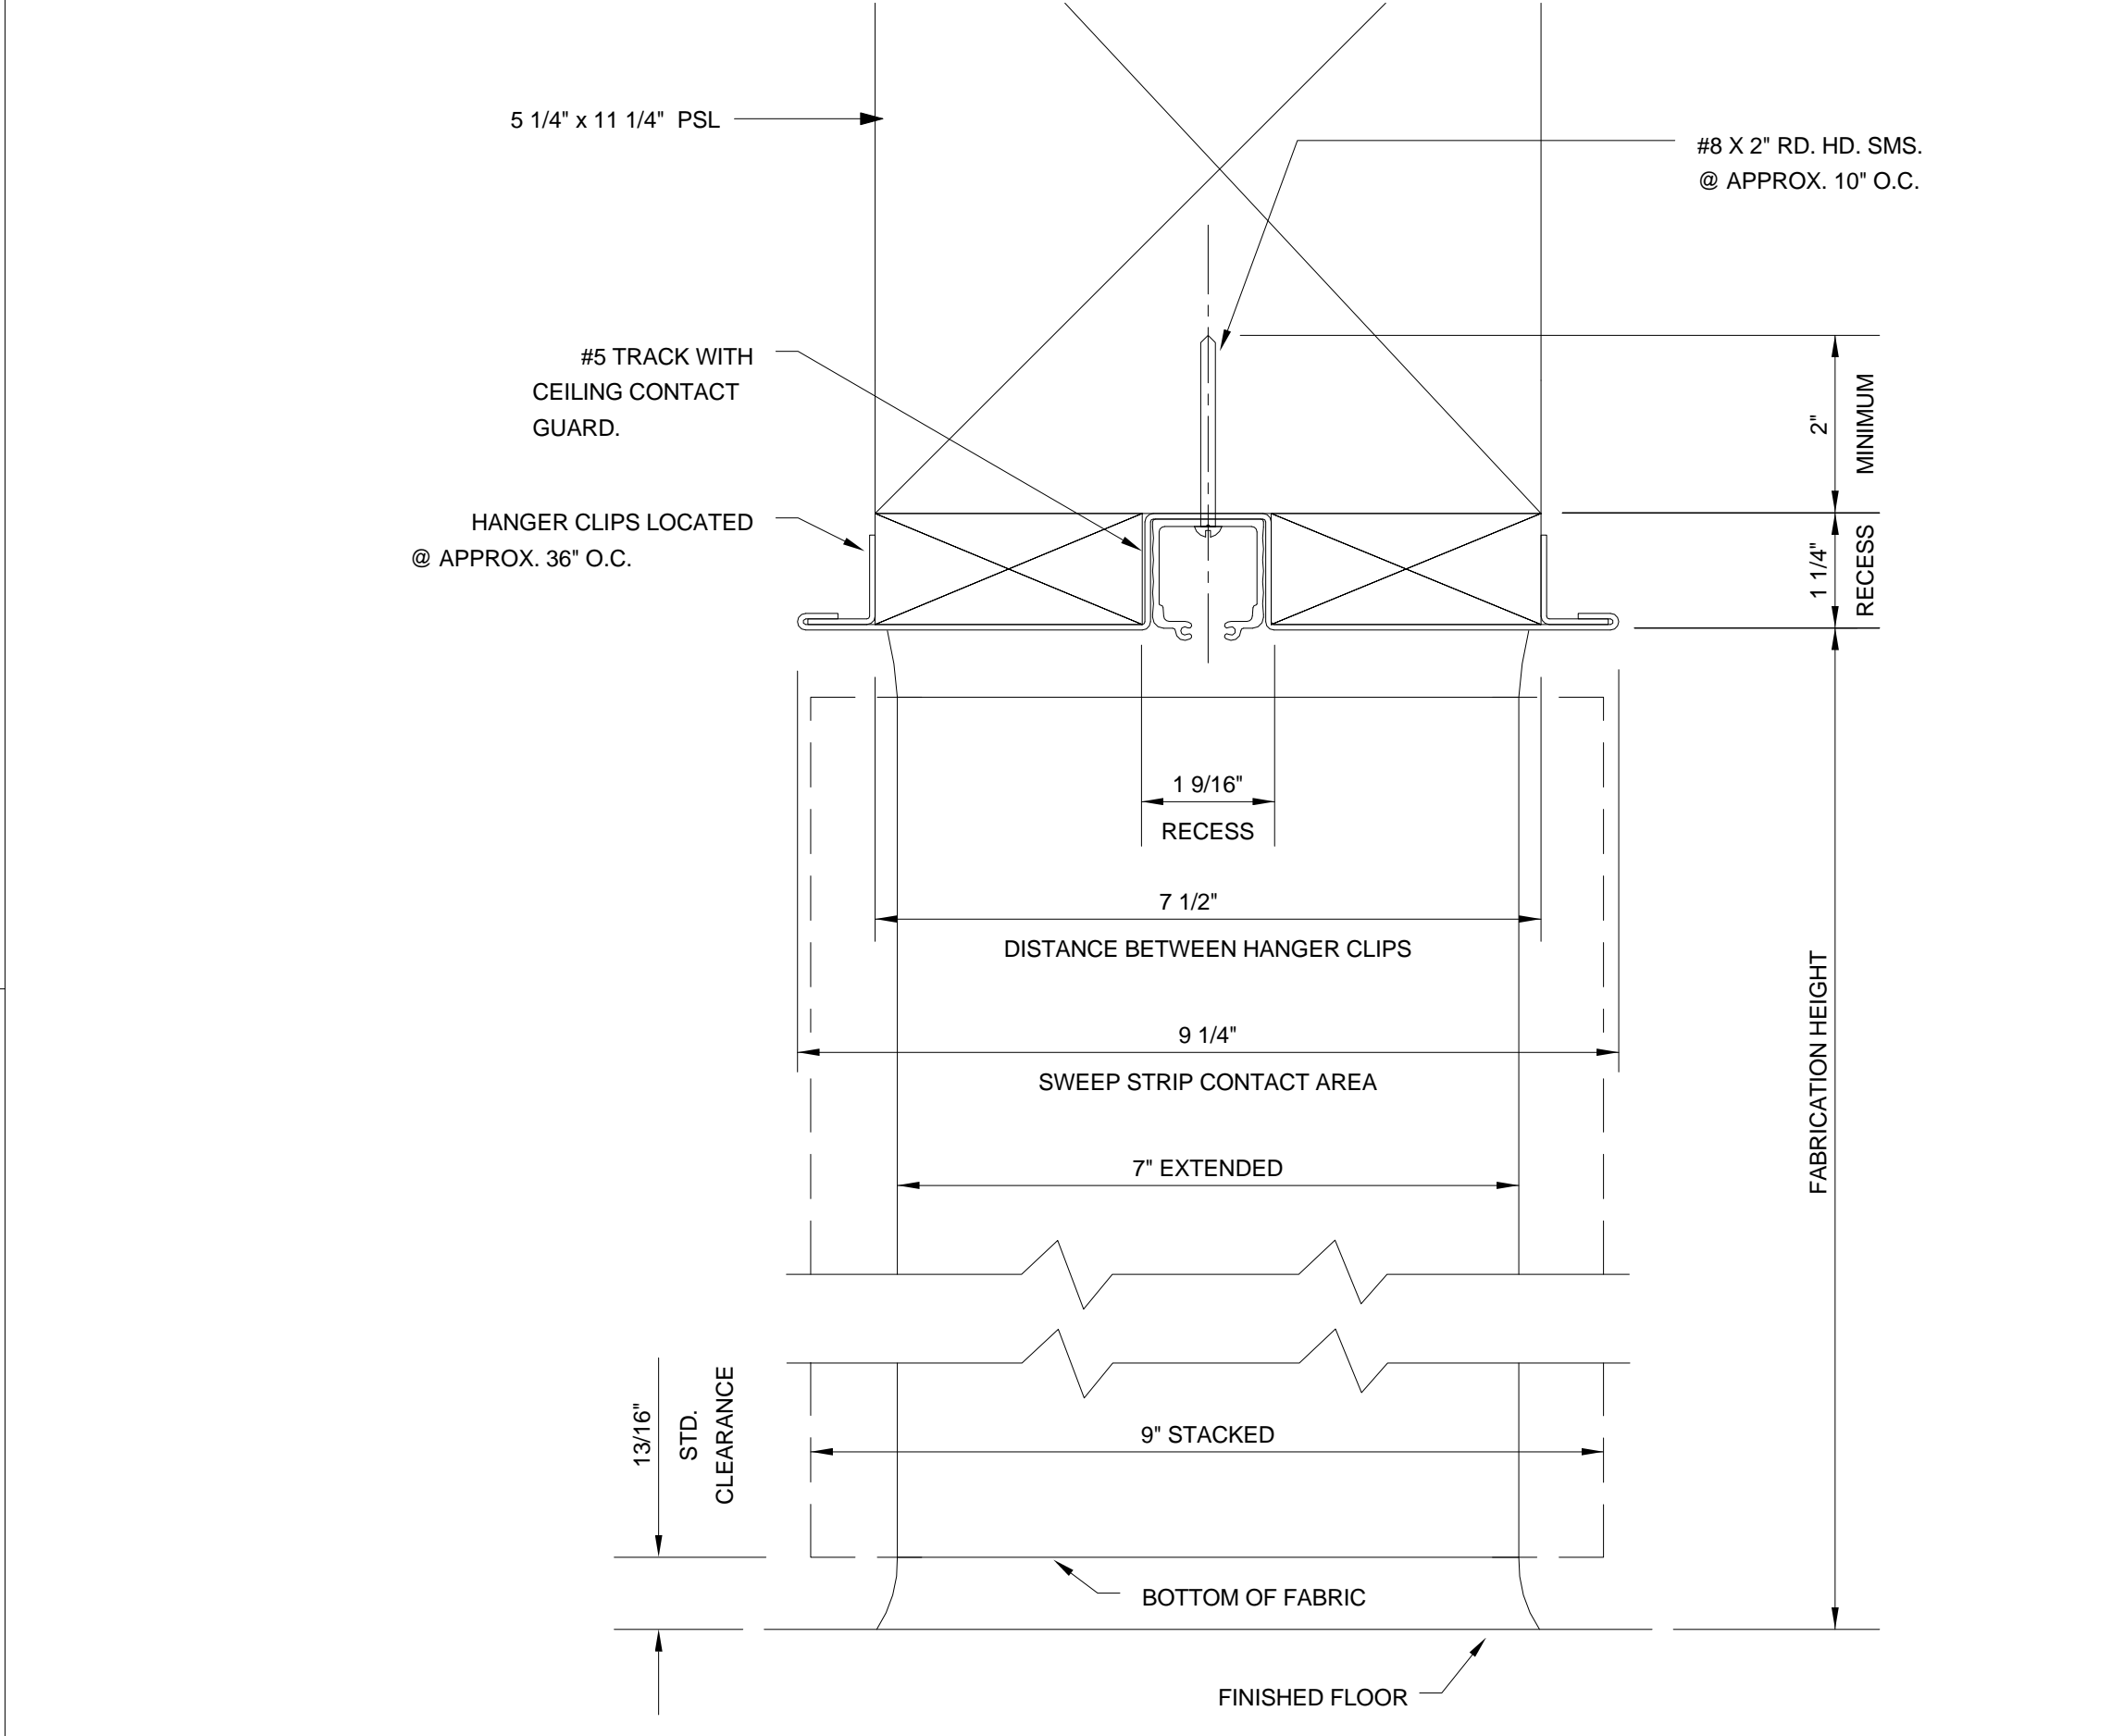

MFA - SM8 HEAD & FLOOR DETAIL - #5 TRACK
3" = 1'-0"

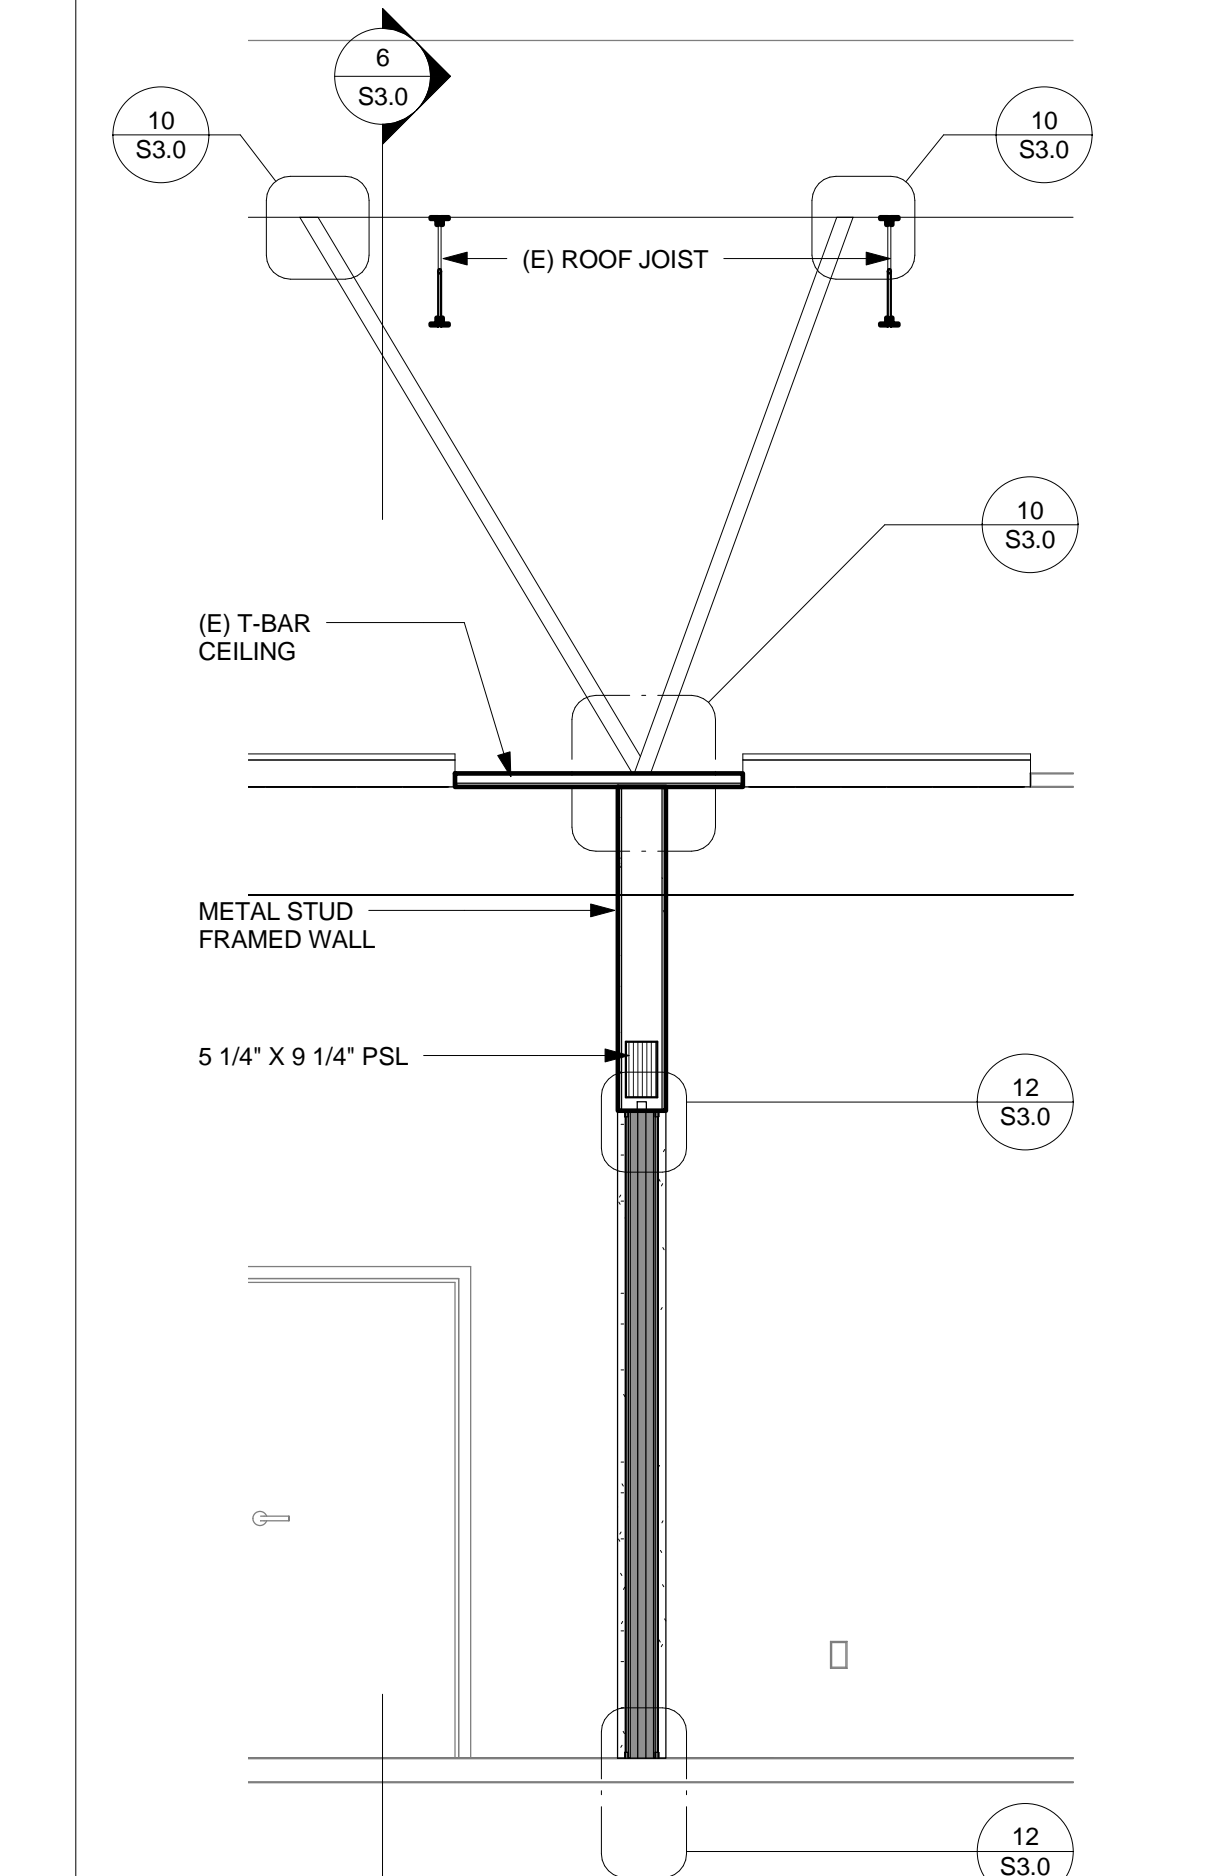

4 S - PARTITION PANEL DOOR SECTION
3/8" = 1'-0"

SECTION 01 01 01
BASIC MATERIALS AND METHODS

PART 1 GENERAL

1.1 CONTRACT PROVISIONS

A. The requirements of this section are in addition to the requirements of Division 1, General Conditions and Supplementary Conditions bound herewith.

1.2 SCOPE

A. Furnish and install all electrical equipment and systems as shown on the Drawings and as described in this Division of the Specifications to provide a complete and functional electrical installation. This work includes but is not limited to: all labor and material required for installation of power, grounding, lighting and special systems complete; and connection (and installation where otherwise not provided for) of electrical equipment furnished by others. Provide and install all items of equipment, devices, supports, etc., which are incidental to the major components shown on the Drawings or specified therein.

1.3 RELATED WORK INCLUDED IN OTHER DIVISIONS

A. Finish painting except factory applied finishes and repair thereto. Coordinate "painting" requirements of this division with other trades as required to assure timely and satisfactory completion of required work. In finished areas, all exposed raceway, boxes, galvanized steel box covers (where allowed) and other electrical "structure" shall be finished to match adjacent structures. Verify that all raceway openings are closed and box covers are in place prior to finishing work done by others.

1.4 APPLICATION OF OTHER DIVISIONS

A. Where carpentry, masonry, concrete work, painting, etc., is required in the installation of equipment specified under this Division, the work shall be done in accordance with the applicable Division of these Specifications. This work could include for example: work associated with panelboard installation, equipment pads or bases, support structures, etc.

1.5 DRAWINGS AND SPECIFICATIONS

A. The information presented in these Specifications and on the Drawings is intended to describe the utilitarian and physical aspects of the systems shown as well as the quality of the entire installation. All information is as complete and thorough as possible, but every condition and situation cannot be anticipated. Exact locations, dimensions, elevations, etc. must be determined "on the job" with careful attention to the "intent" of the Drawings and Specifications.

B. The above paragraph shall not be construed as to allow significant deviation from either the Drawings or Specifications without prior approval of the Architect, but minor changes in conduit routing or equipment locations may be required or desired due to specific conditions encountered. This work shall be accomplished in accordance with these Specifications and no "extra charges" are to be created for additional labor or material.

C. The Drawings are necessarily diagrammatic in nature, but the locations or devices, equipment, outlets and lighting fixtures are shown approximately where they are intended to be installed.

D. If significant departures from the Drawings or Specifications are considered necessary by the Contractor, details of the changes and the reasons therefor shall be submitted to the Architect as soon as possible within thirty days after award of contract. Prior written approval of the Architect is required for these departures.

E. Where existing underground or otherwise concealed facilities are indicated on the Drawings, these are located as well as can be determined from available information. The Contractor is required to verify actual locations as necessary for this construction.

1.6 RULES, SCODES AND REGULATIONS

A. All work and materials shall be in full accordance with the latest rules, codes and / or regulations as follows: California Building Code (CBC); NFPA Bulletins; California Electrical Code (CEC); Utility rules and regulations; and all other applicable regulatory documents.

1.7 WORKMANSHIP

A. High quality workmanship shall be evidenced in the installation of all electrical equipment and materials. Use the National Electrical Contractor's Association "Standard of Installation" as a guide to the workmanship required. Be prepared to replace or repair any material or equipment damaged by or installed in a manner exhibiting evidence of poor workmanship.

1.8 COORDINATION

A. Examine the Electrical; Drawings and refer to the Drawings and Specifications describing other work to be accomplished. Coordinate work planning and all work in the field to avoid conflicts, errors and / or delays. No compensation will be allowed for extra work necessitated by lack of coordination.

1.9 AUTHORITY OF THE ARCHITECT

A. As used in this paragraph only, the work "Architect" shall mean the Architect of Record or his designated representative.

B. The authority of the Architect shall be absolute with respect to all performance under this specification. In case of dispute, the decision of the Architect shall be final.

C. Where optional materials, methods or installation techniques are allowed under the provisions of this Specification, they may be used at the discretion of the Architect. The Architect may require specific materials, methods or techniques to be used in specific situations where use of other materials, methods or techniques might result in his judgment result in the loss of aesthetics, accidental damage, life safety hazard, or loss of utility over the system design lifetime.

D. No additional charges will be allowed for work or material to be supplied under the conditions of this paragraph unless the need for such material or work could not have been anticipated by thorough study of the site, Drawings, and Specifications and knowledge of all applicable codes, laws and ordinances.

1.10 EXAMINATION OF THE SITE

A. The contractor is to have visited the site of construction prior to bid to determine existing conditions and their effect upon the work he will be required to perform. No additional compensation will be allowed for any extra expense incurred by the failure to detect and evaluate all existing conditions which will affect his work.

1.11 PERMITS, FEES AND INSPECTIONS

A. Obtain all permits and licenses required and pay all fees incidental to construction

B. All required utility fees and extension charges shall be determined and itemized for payment by the owner as required. A complete itemized list of these fees and charges shall be provided with the bid including the amounts to be paid where these amounts can be determined prior to the bid.

C. Inspections required by Utilities, prevailing Local Authorities, and / or ordinances shall be arranged for by the contractor. Provide the Architect with a schedule of inspections, where applicable, and submit all certificates of inspection to him.

1.12 GUARANTEE

A. All electrical work, material and equipment shall be guaranteed to be free from defects in workmanship or material for a period of one (1) year from date of final acceptance. Repair or replace all such defects in a timely manner and any damage to the owner's property resulting from such defect or repair thereof. All equipment and material provided and all work accomplished under the requirements of this section shall be at no expense to the owner.

1.13 OPERATING INSTRUCTIONS

A. Instruct the Owner or his designated representative as to function, operation maintenance and adjustment of each system and piece of equipment provided.

1.14 AS-BUILT DRAWING

A. The contractor shall keep a separate set of Electrical Drawings at the jobsite to be used as As-Built Drawings. These Drawings are to be kept current and in a neat and clean condition at all times. They are to be available for inspection by the Architect at any time during site visitations. These Drawings shall be "red lined" to indicate all changes in equipment, device and outlet locations; and to indicate the true locations of all concealed or underground work where permanently marked "As Built".

1.14 Upon completion of the project and prior to final payment, purchase a fresh set of prints from the Architect and transfer all as-built information to it. All information shall be clearly drawn with ink. Deliver the original and final as-built sets to the Architect for approval and delivery to the Owner.

1.15 WIRING METHODS

A. Wiring methods shall be as noted on the Drawings and specified therein. All wiring shall be installed in raceway.

B. Where not noted otherwise, use EMT in interior locations, ENT may not be used in this installation.

C. PVC schedule 40 shall be used underground, in, and under slabs.

D. Rigid steel shall be used where indicated on the Drawings and wherever conduit might be subject to physical abuse either during construction or facility utilization.

E. Liquid-tight flexible metal conduit shall be used for final connection to vibrating or moveable equipment eg: motors, water heaters, HVAC equipment, etc. In locations where cleaning operations, abnormal operating conditions or equipment or device failure could cause water, refrigerant, oil or other liquid to be directed to or spilled onto the raceway; liquid-tight flexible metal shall be used.

F. Galvanized flexible metal conduit may be used for final connection to recessed lighting fixtures where shown on the Drawings and to other relocatable or vibratory equipment in dry locations only. Flexible metal conduit may be used in concealed areas where other materials are not suitable. The Architect must approve each of these locations prior to installation.

PART 2 PRODUCTS

2.1 MATERIALS

A. Unless specifically indicated otherwise, all material shall be new and free from defects, it shall be listed by Underwriter Laboratories where applicable, and it shall have been

manufactured in the United States. Like items shall be of the same manufacturer (except lighting fixtures – which should be as specified).

B. Except as noted otherwise, where materials of a specific manufacturer is specified, the intent is to describe the quality and function of the item. The term "...or approved equal" is implied. A substitution of any of these items will require the item be represented in a submittal whether specifically listed in the "Submittals" paragraph or not.

2.2 SUBMITTALS

A. Material submittals shall be complete and submitted all at the same time. The individual groups of the same types (eg lighting fixtures, wiring devices, distribution equipment, etc.) MUST be prefaced with a list of contents identifying each item by it's project name or symbol, manufacturer and complete catalog number. Each copy of each submittal group shall have the list of contents attached. These lists shall be used to report submittal comments. The contractor is responsible for submitting this information in a timely manner so that material may be ordered early enough to meet the construction schedule. If material is not ordered in time for whatever reason, pay such premium prices and special handling charges as are required to meet the construction schedule. No substitution of an "accepted" item will be allowed to failure to plan for adequate material procurement lead time.

B. Submittals are required for at least the following items:

- 1. SWITCHBOARDS
- 2. SERVICE EQUIPMENT
- 3. LIGHTING FIXTURES AND BALLASTS
- 4. PANELBOARDS / PANELS
- 5. IN-GROUND PULLBOXES
- 6. WALL SWITCHES
- 7. RECEPTACLES
- 8. SAFETY SWITCHES
- 9. EQUIPMENT ENCLOSURES
- 10. FIRE ALARM / LIFE SAFETY DEVICES

C. Substitutions – Only one substitution will be considered for any item. Substitute materials must be equal in quality and function to that specified. Allowance of a substitution does not permit any reduction of system performance or utility, and the contractor is responsible for additional costs incurred due to use of a substituted item. If the proposed substitute item is "rejected" the specified item shall be provided (resubmittal required).

Part 3 EXECUTION

3.1 INSTALLATION

A. All equipment shall be set square and plumb, securely mounted, adequately supported and permanent. Provide workspace around items of electrical equipment as required by NEC. In general, equipment is to be installed in accordance with manufacturer's instructions; but the requirements of these Specifications shall take precedence where conflicts exist.

3.2 ELECTRICAL PARAPHERNALIA

A. Retain and safeguard all detachable and spare devices, equipment and literature (instruction books, wiring diagrams, test reports, keys, fixtures, etc.) until completion of work. At this time all items will be delivered to the Owner as directed by the Architect.

3.3 TESTS


A. Test all wiring for continuity and ground before any fixtures or equipment are connected. Where such tests indicate faulty installation or other defects, the faults shall be located and repaired at the contractor's expense. The repaired installation shall then be retested.

B. Verify rotation of all three phase motors and reconnect if necessary.

C. Verify the resistance of the grounding electrode system(s). Grounds to meet or exceed performance requirements of NEC.

D. Balance all loads on each panelboard and all other types of distribution equipment as applicable.

END OF SECTION

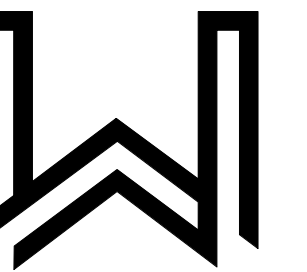


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ARCHITECTURE

149 Crown Point Ct., Suite C
Grass Valley, CA 95945
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Stamp:



Consultant:

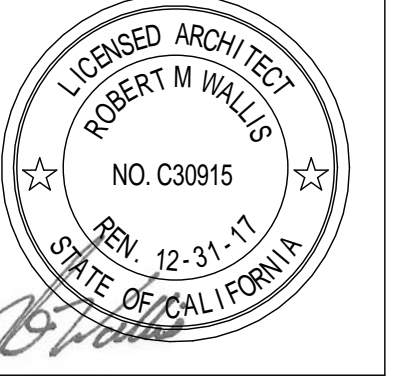CONSTRUCTION
DOCUMENTS

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NEVADA COUNTY PROBATION
DEPARTMENT & PUBLIC DEFENDER
109 1/2 Pine Street
Nevada City, CA 95959
APN: 05-570-04

No.	Description	Date

Proj. No.: 2016015

Date: 08/03/2016


Scale: 1" = 1'-0"

Drawn By: JMT

E1.0

ELECTRICAL NOTES

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
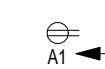
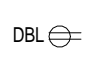



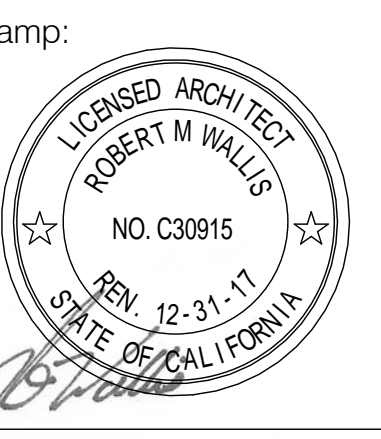



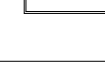
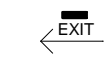




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LEGEND


-  SUSPENDED ACOUSTICAL CEILING WORK
-  DUPLEX RECEPTACLE PANEL (LETTER) - CIRCUIT (#), REFER TO PANEL SCHEDULE
-  DOUBLE DUPLEX RECEPTACLE
• MOUNT AT 15" AFF UNLESS NOTED OTHERWISE
-  TEL/DATA + FOURPLEX + ALARM WIRE FLOOR RECEPTACLE, WALKER RFB4
-  TELEPHONE/DATA
• MOUNT AT 15" AFF UNLESS NOTED OTHERWISE
-  FIXTURE TAG, REFER TO SCHEDULE
-  PANEL (LETTER) CIRCUIT (#), REFER TO PANEL SCHEDULE
-  CARD ACCESS
-  2X4 RECESSED LIGHT FIXTURE, REFER TO SCHEDULE
-  RELOCATED 2X4 TROFFER LIGHT
-  NEW 2X4 TROFFER LIGHT
-  2X4 RECESSED CEILING MOUNTED FIXTURE, REFER TO SCHEDULE
-  LINEAR LIGHT FIXTURE, REFER TO SCHEDULE
-  ILLUMINATED EXIT SIGN, BATTERY BACK-UP TYPICAL
DIRECTIONAL SIGN WHERE INDICATED

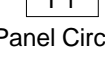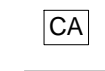GENERAL NOTES


- A. ALL WORK SHALL COMPLY WITH THE 2013 CALIFORNIA ENERGY AND ELECTRICAL CODE.
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- C. MECHANICAL, ELECTRICAL AND PLUMBING SYSTEMS ARE FOR INTENT ONLY. THESE SYSTEMS SHALL BE ENGINEERED BY OTHERS. THE CONTRACTOR SHALL BE RESPONSIBLE FOR PROPER INSTALLATION AND PLACEMENT.
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- F. ALL WIRING THAT SUPPLIES 125 VOLT, SINGLE PHASE 15 AND 20 AMP OUTLETS (RECEPTACLES) IN BEDROOMS SHALL BE PROTECTED BY AN ARC-FAULT CIRCUIT INTERRUPTER LISTED TO PROVIDE PROTECTION FOR THE ENTIRE BRANCH CIRCUIT. ART. 210-12 NEC.
- G. ALL REQUIRED SMOKE DETECTORS IN EXISTING STRUCTURE SHALL BE IN PLACE AND FIELD VERIFIED @ TIME OF FRAMING INSPECTION.
- H. ILLUMINATED EXIT SIGNS SHALL BE CENTERED ABOVE DOOR OPENINGS. UNO.
- I. ALL ELECTRICAL RECEPTACLES IN OFFICES AND WORK STATIONS/AREAS SHALL BE DOUBLE DUPLEX TYPE.
- J. (N) AND (R) FIXTURES TO USE EXISTING CIRCUITRY. UNO.
- K. LIGHTING CALCULATIONS PER CEC CHAPTER 6 TABLES 140.0.E & F, EXISTING (103) - RELOCATED 8 FIXTURES + NEW 2 FIXTURES (10/103 = 9.70% OF TOTAL FIXTURES RELOCATED < 10%)

SHEET NOTE

1. TELE DATA FOR CONFERENCE TV. VERIFY MOUNTING HEIGHT W/ TENANT.
2. *KIOSK* LOCATION VERIFY HEIGHT AND EQUIPMENT REQUIREMENTS BEFORE INSTALLATION.
3. VERIFY ELECTRICAL REQUIREMENTS FOR TENANT SUPPLIED SYSTEM FURNITURE, CEILING DROPS AT (E) COLUMNS.

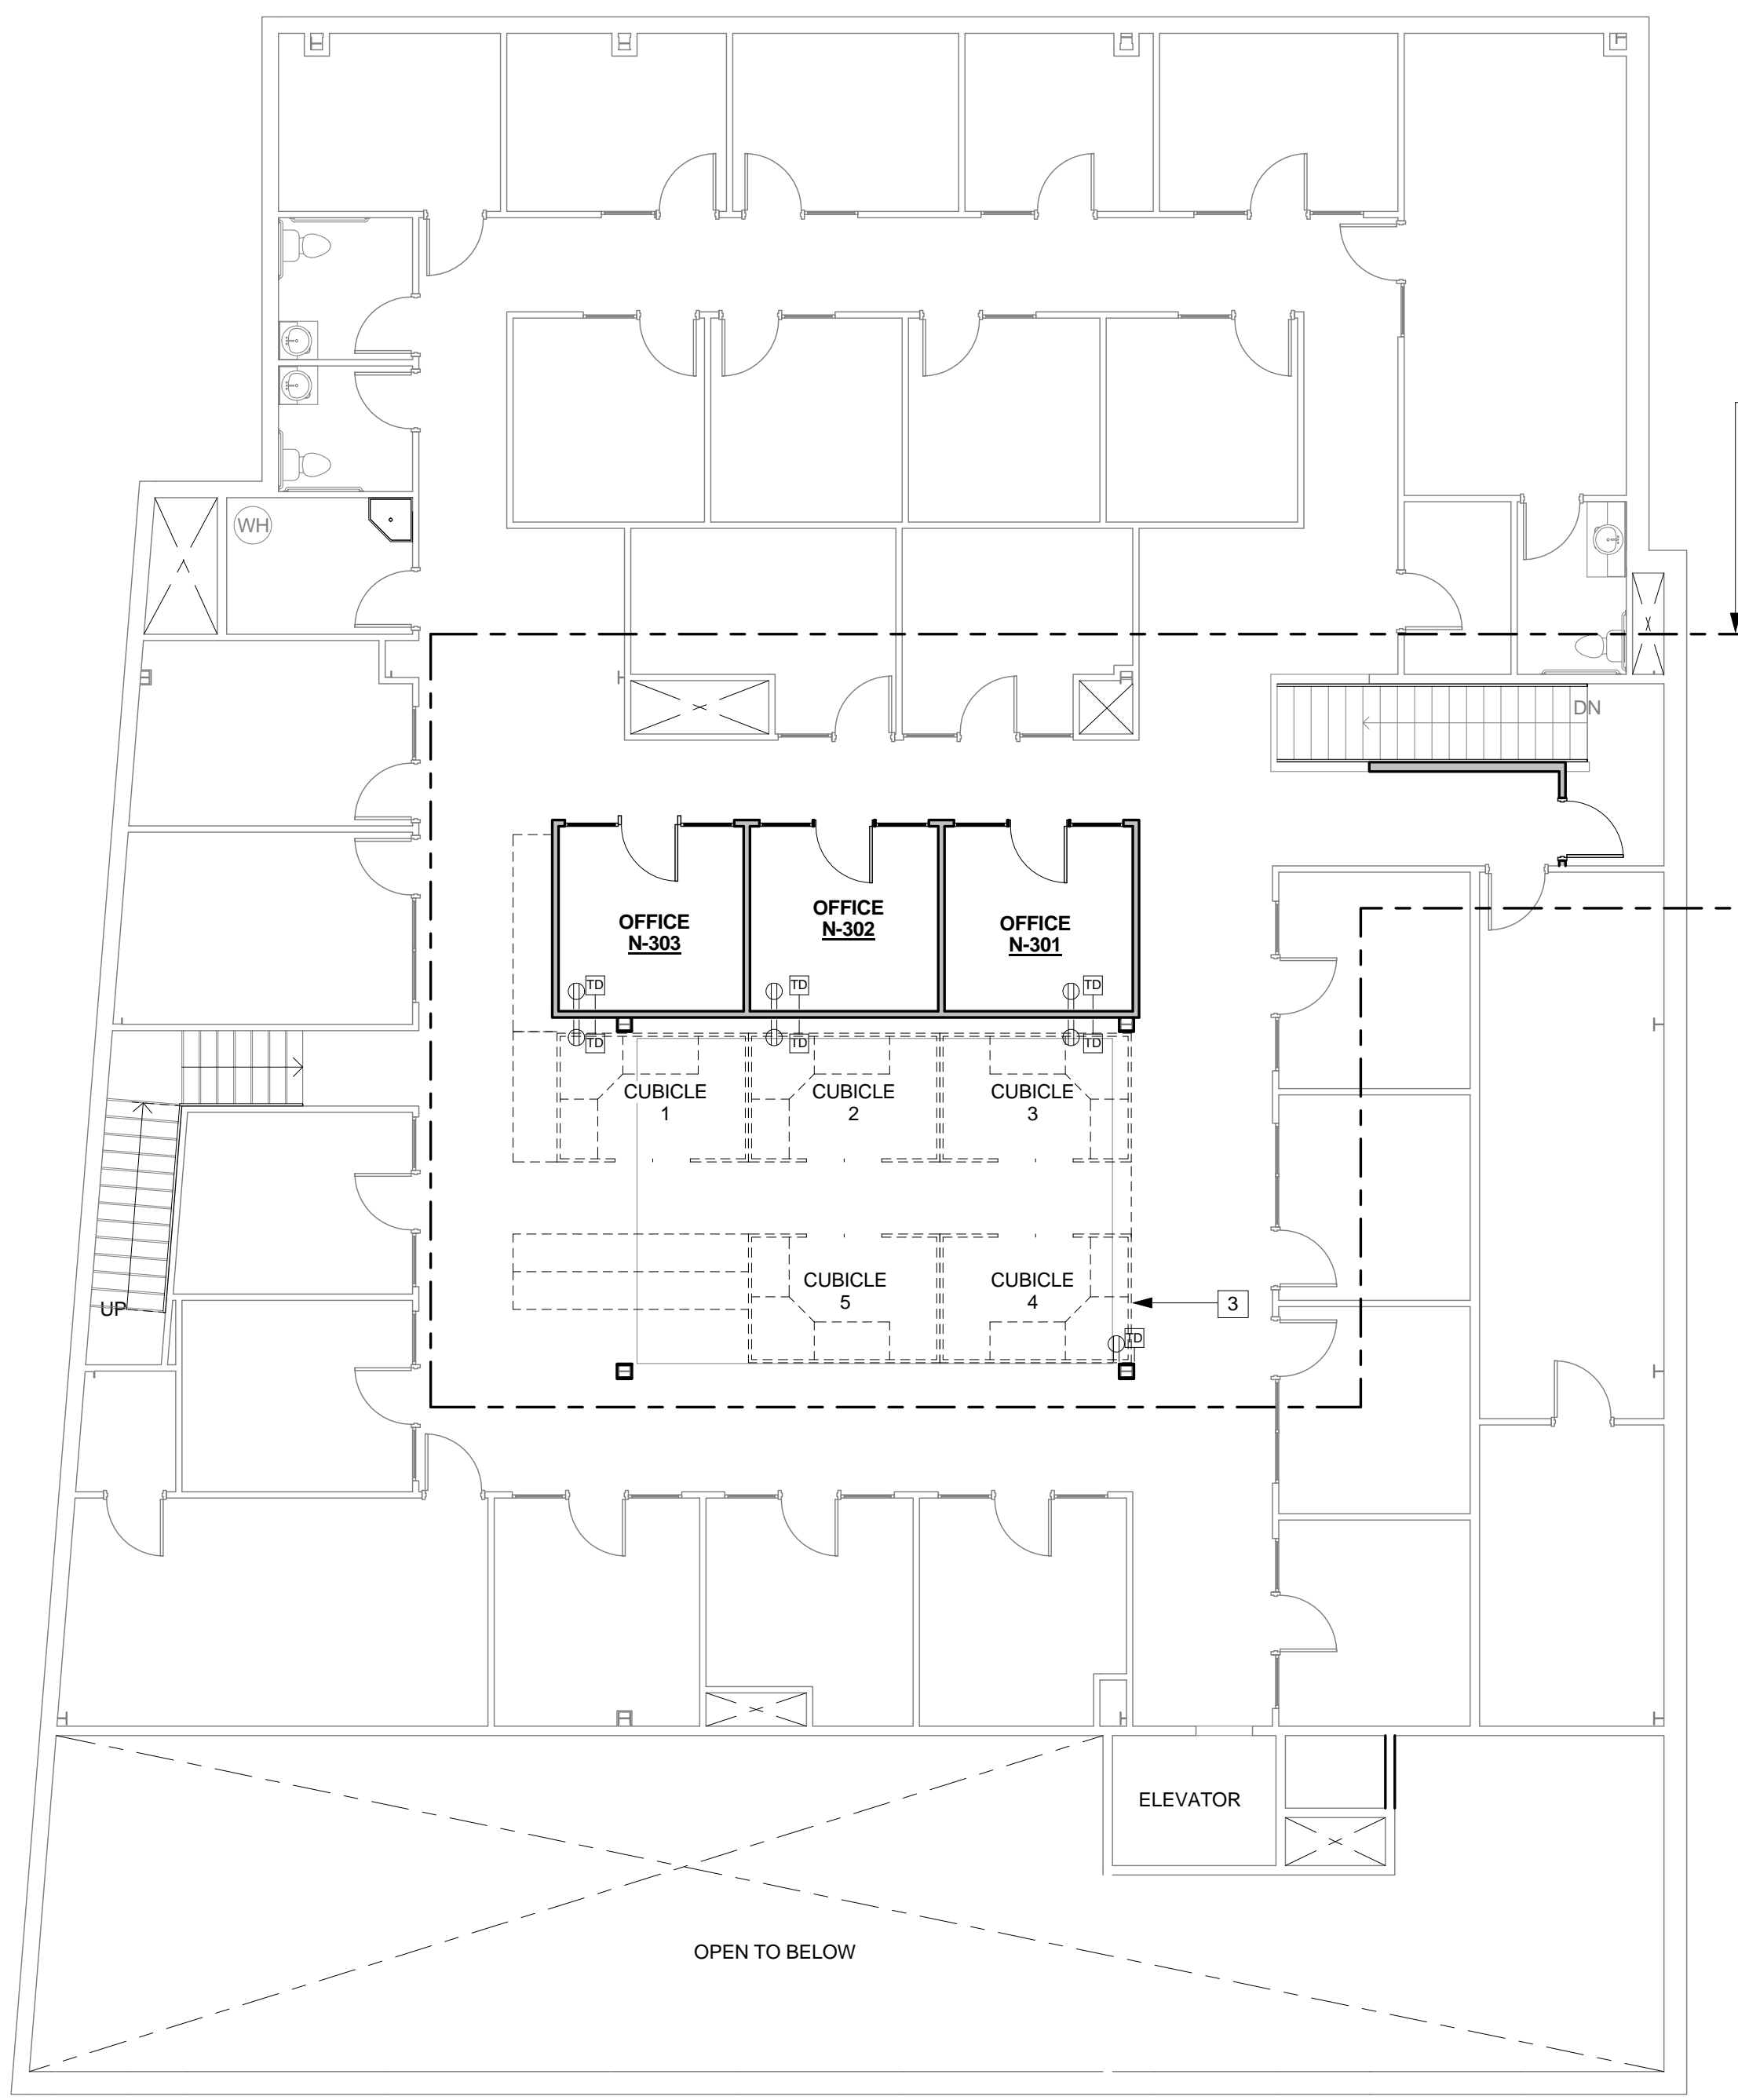


3RD FLOOR - OVERALL POWER & SIGNAL PLAN
②
1/8" = 1'-0"

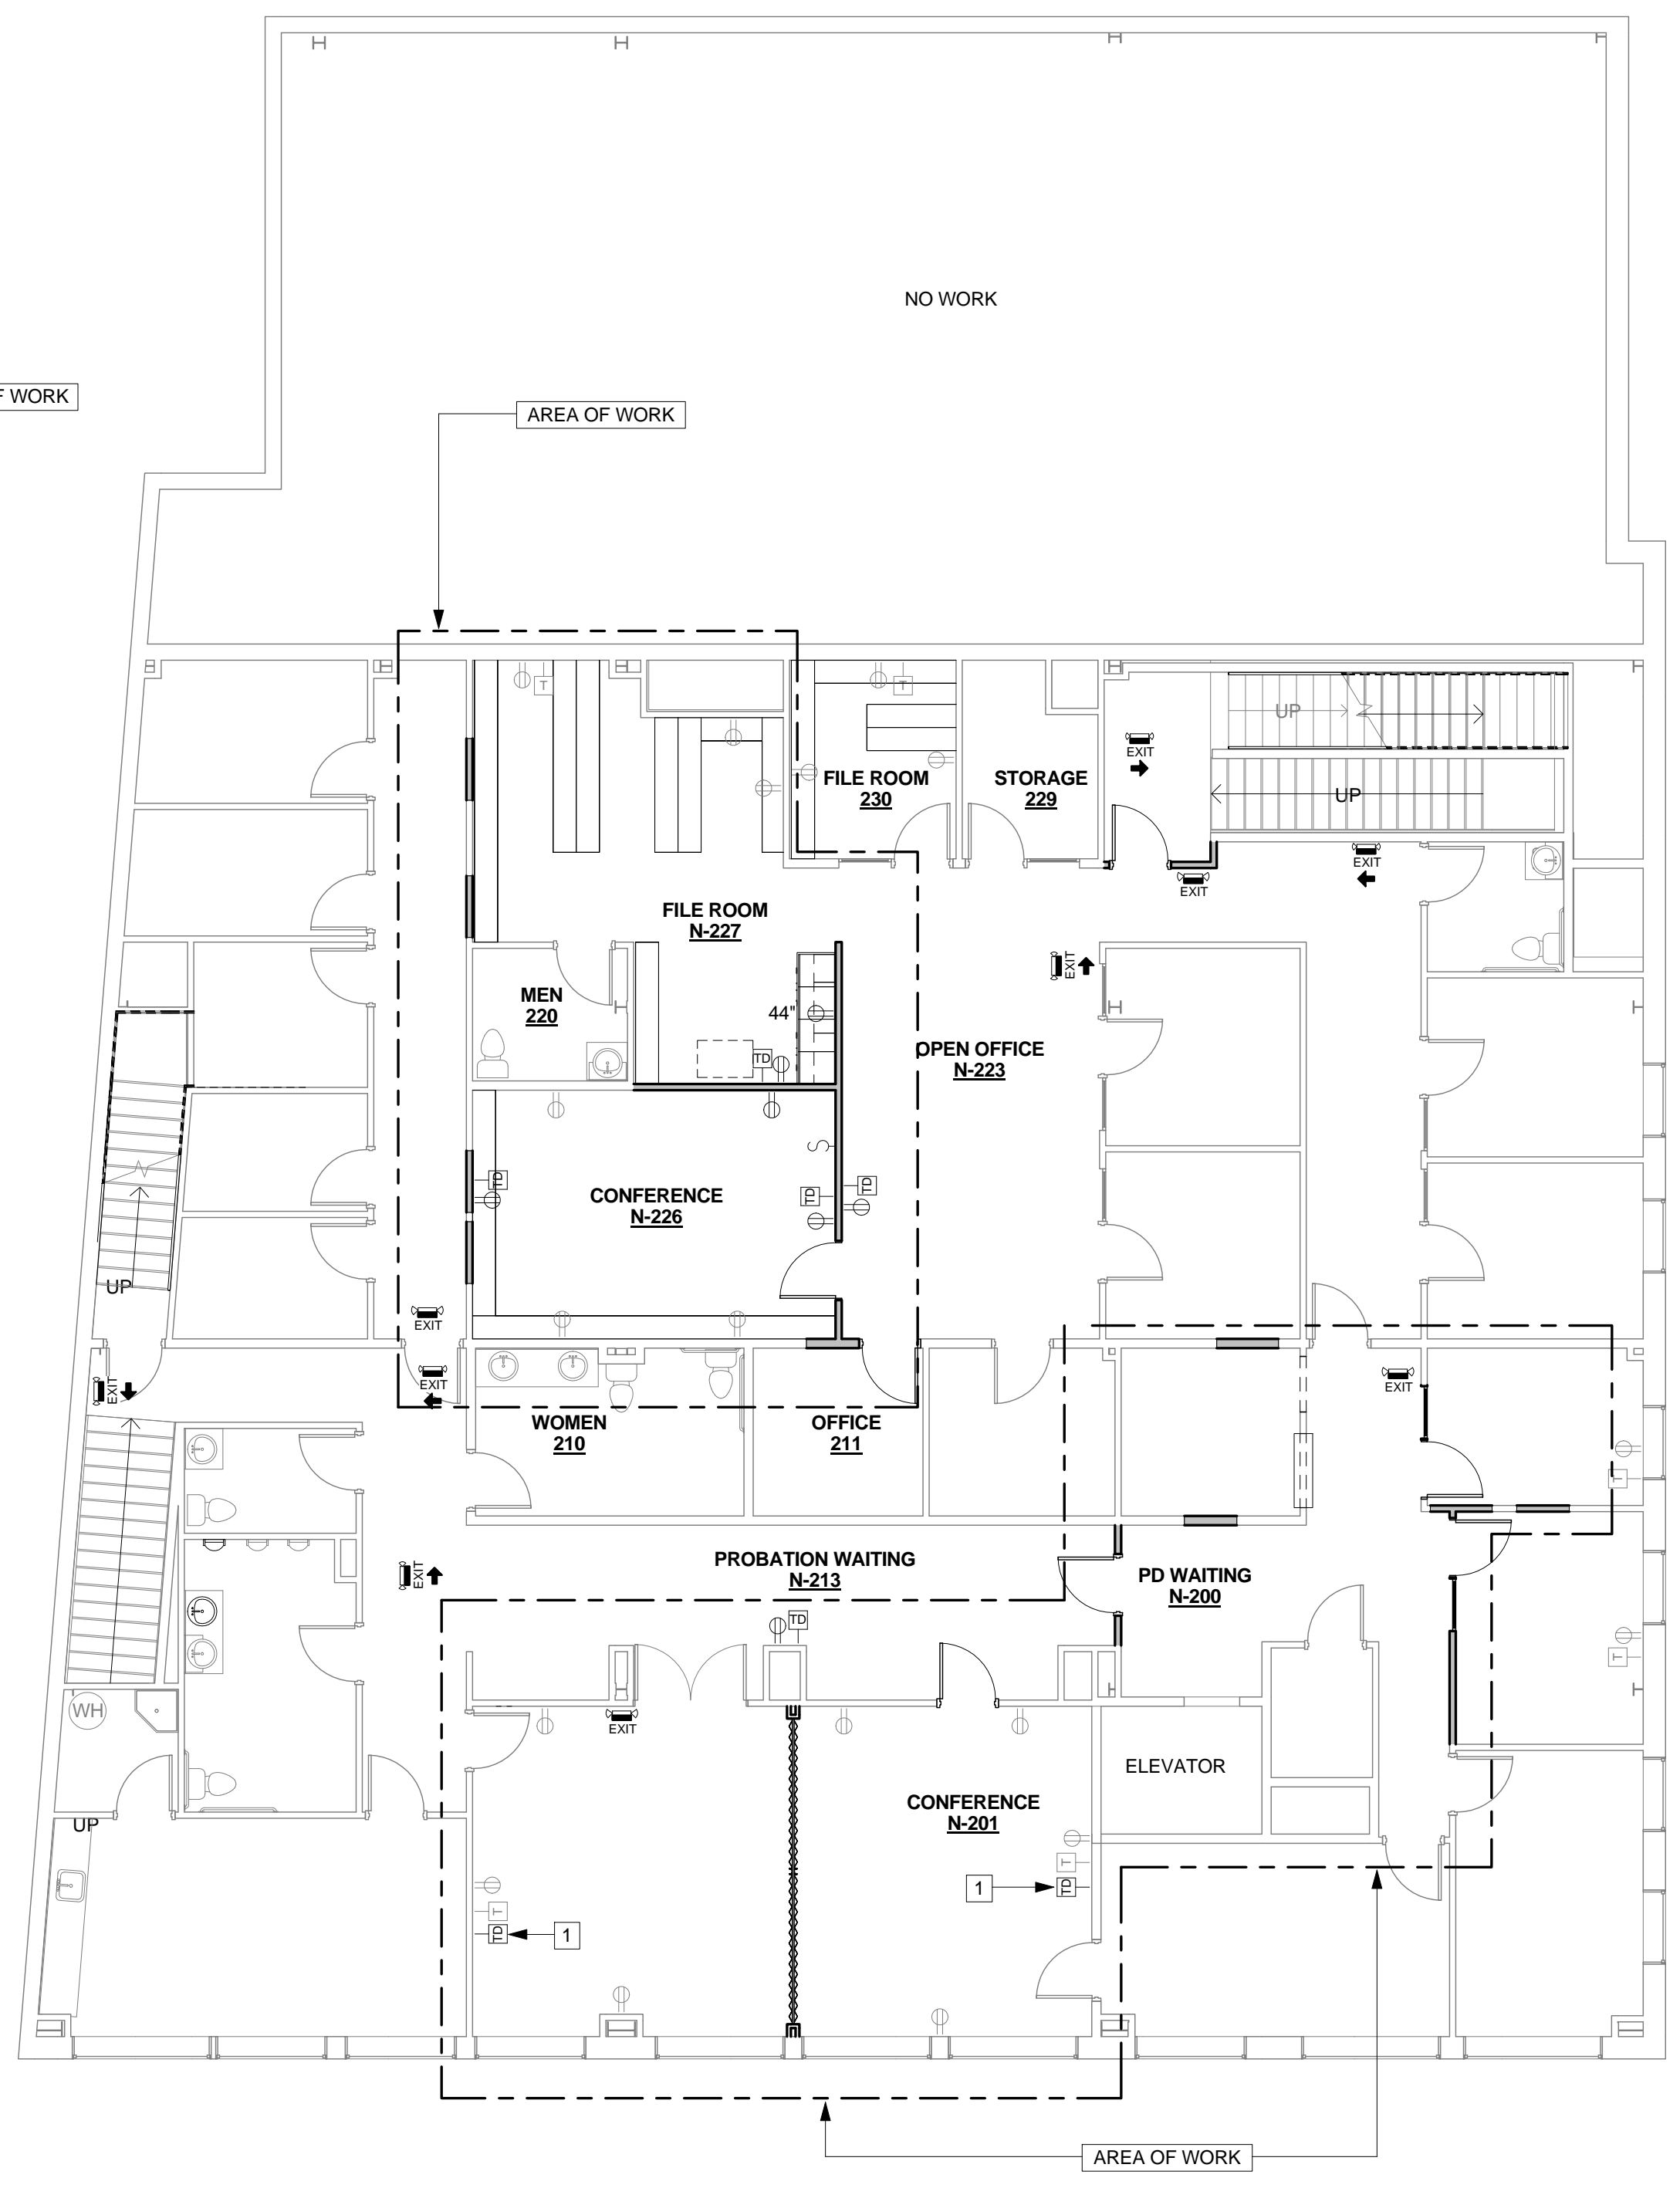

2ND FLOOR - OVERALL POWER & SIGNAL PLAN
①
1/8" = 1'-0"


No.	Description	Date

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Scale: As indicated
Drawn By: JMT

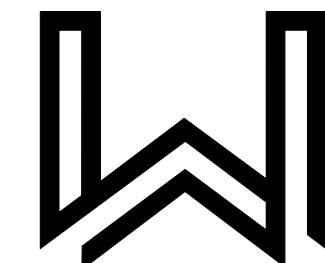

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Drawn By: JMT

E3.0
2ND & 3RD FLOOR
LIGHTING PLAN

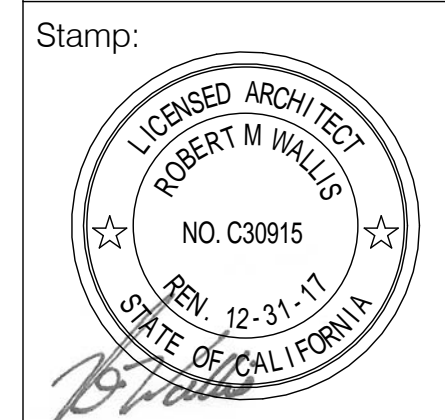8/4/2016 8:39:41 AM


LEGEND

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Schedule - Lighting Fixtures					
Type	Family and Type	Mfg	Model	Lamp	Notes
F2	Troffer Light - 2x4: LF-2	Cree	ZR24-40L-35K-10V	LED	L



LIGHTING FIXTURES:
EXISTING 40
RELOCATED 2
TOTAL 42

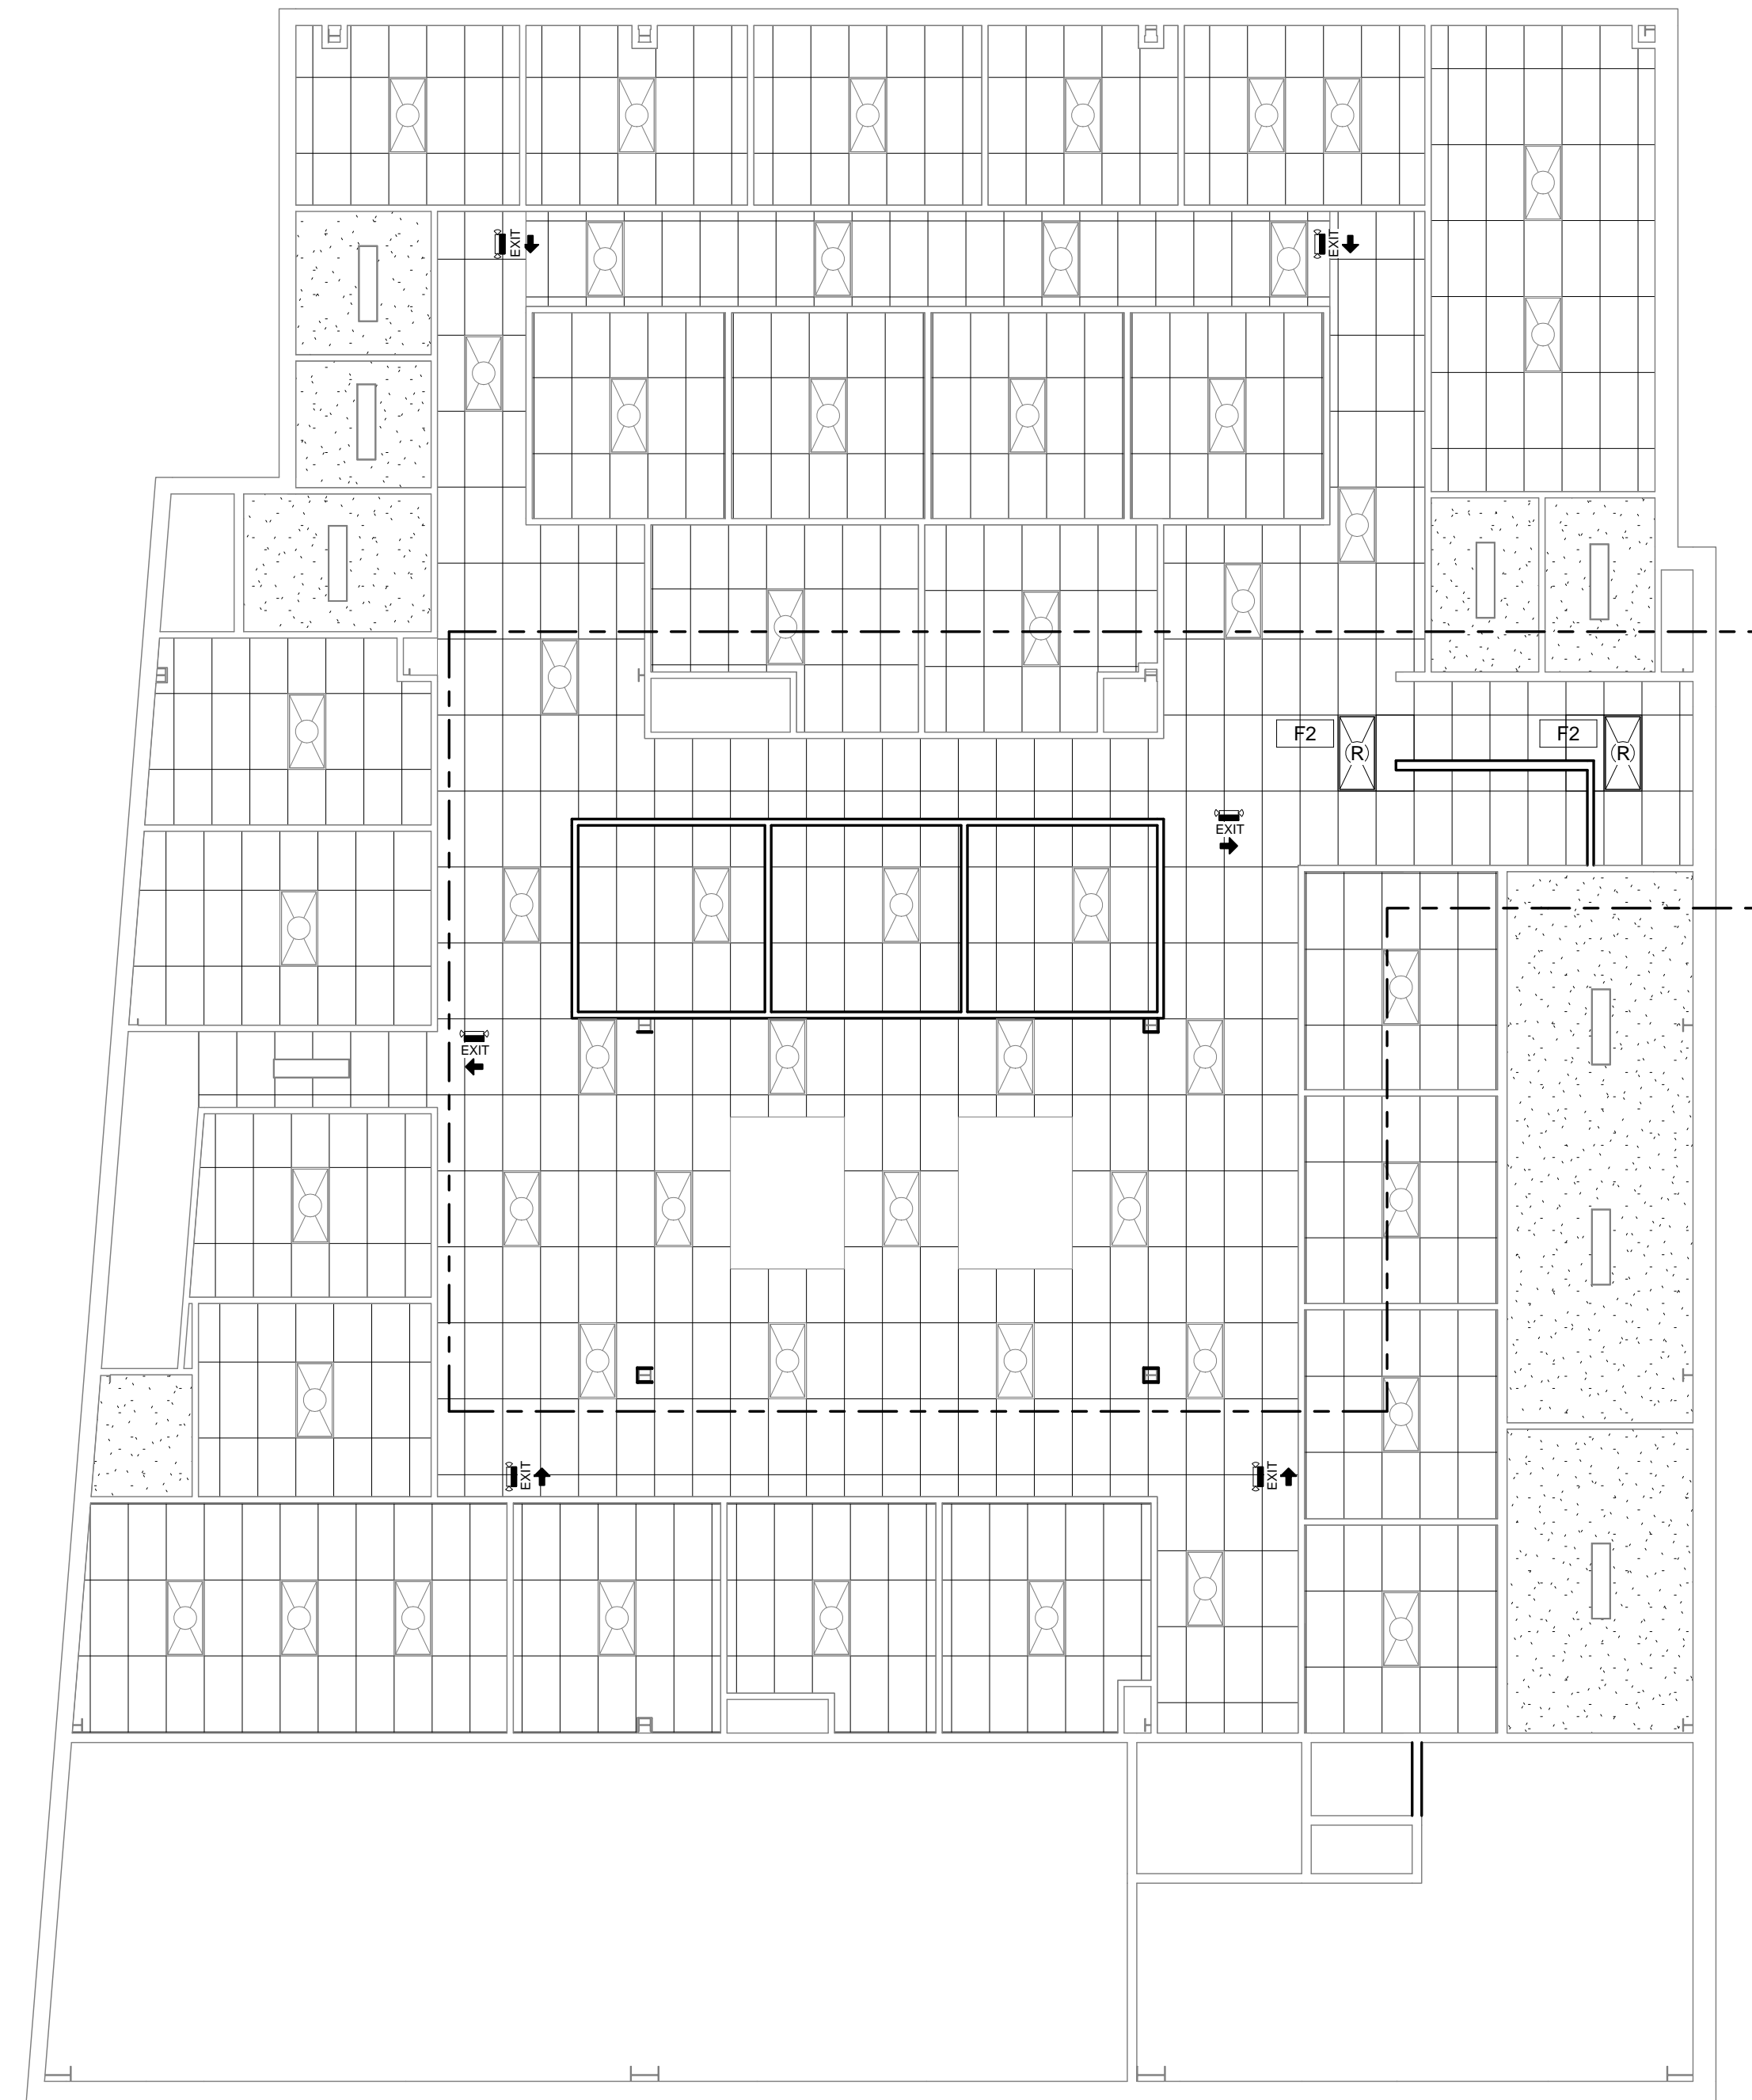

LIGHTING FIXTURES:
EXISTING 55
RELOCATED 6
TOTAL 61

② 3RD FLOOR - OVERALL LIGHTING PLAN
1/8" = 1'-0"

① 2ND FLOOR - OVERALL LIGHTING PLAN
1/8" = 1'-0"