

# RESOLUTION No.

# 21-108

# OF THE BOARD OF SUPERVISORS OF THE COUNTY OF NEVADA

RESOLUTION APPROVING AMENDMENT NO. 2 TO THE SITE LEASE AGREEMENT BETWEEN THE COUNTY OF NEVADA AND T-MOBILE WEST, LLC, FOR TOWER RENTAL LOCATED AT 980 HELLING WAY IN NEVADA CITY TO INCREASE THE RENTAL SPACE FOR INSTALLATION OF A POWER GENERATOR AND AUTHORIZING THE CHAIR OF THE BOARD OF SUPERVISORS TO EXECUTE THE AMENDMENT


WHEREAS, the County of Nevada and T-Mobile West, LLC, March 22, 2011, through Resolution 11-119, a ten (10) year lease agreement was entered into for the rental of space on the County-owned Telecommunications Tower and Equipment Room located at 980 Helling Way, Nevada City, CA, 95959, APN 05-020-018; and subsequently amended on February 11, 2020 through Resolution 20-040 to provide four (4) additional five (5) year terms; and

WHEREAS, both parties desire to amend their Agreement to increase the rental space for installation of a power generator.

NOW THEREFORE, BE IT RESOLVED that the Nevada County Board of Supervisors hereby directs that:

- 1. That the Board Chair hereby approves and is authorized to execute on behalf of the County of Nevada Amendment No. 2 to the Lease Agreement "Site Lease with Options" with T-Mobile West, LLC, for the rental of tower and ground space located at 980 Helling Way, Nevada City, CA, 95959, APN 05-020-018 to provide additional space on the premises for the installation of a power generator.
- 2. Rent will increase by \$400.00 per month for the additional space on the first day of the month following the completion of construction for the modification of the equipment. Additionally, the Insurance provision has been updated.
- 3. This Amendment shall be effective as of the date of execution by the last party to sign the Amendment.
- 4. That the Director of Facilities Management is authorized to sign applications and documents related to the installation of the Generator.
- 5. That in all other respects the terms of the Lease Agreement shall remain the same except as amended herein.

Revenue Account: 0101-10702-415-1000/430200

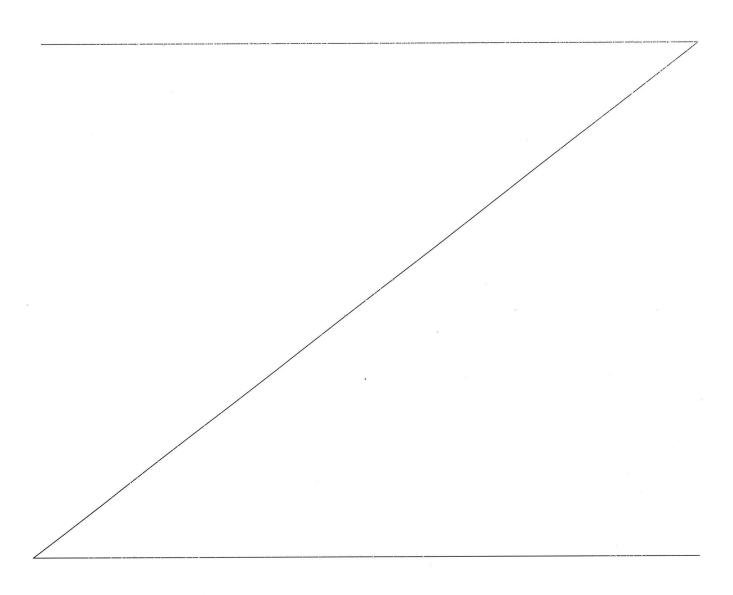

PASSED AND ADOPTED by the Board of Supervisors of the County of Nevada at a regular meeting of said Board, held on the <u>13th</u> day of <u>April</u>, <u>2021</u>, by the following vote of said Board:

Ayes:

Supervisors Heidi Hall, Edward Scofield, Dan Miller, Susan

K. Hoek and Hardy Bullock.

Noes:

None.

Absent:

None.

Abstain:

None.

ATTEST:

JULIE PATTERSON HUNTER Clerk of the Board of Supervisors

By

Dan Miller, Chair

4/13/2021 cc:

Facilities\* AC\* TMW, LLC

# AMENDMENT NO. 2 TO THE SITE LEASE WITH OPTION (RESO 11-119)

This Amendment No. 2 to the Site Lease with Option (the "Second Amendment") is effective as of the date of execution by the last party to sign (the "Effective Date"), by and between County of Nevada, a political subdivision of the State of California ("Landlord"), and T-Mobile West LLC, a Delaware limited liability company ("Tenant")(each a "Party", or collectively, the "Parties").

# Recitals

The parties hereto recite, declare and agree as follows:

A. Landlord and Tenant (or as applicable, their respective predecessors in interest) entered into a Site Lease with Option dated March 22, 2011, as amended by that certain Amendment No.1 dated February 11, 2020 (the "First Amendment") (collectively, the "Lease"), with respect to Premises located at 980 Helling Way, Nevada City, CA 95959 (Nevada County Assessor's Parcel Number 005-020-018) (the "Property").

B. Landlord and Tenant desire to enter into this Second Amendment in order to modify and amend certain provisions of the Lease.

NOW, THEREFORE, in consideration of the mutual covenants and agreements herein contained and other good and valuable consideration, the receipt and sufficiency of which are hereby acknowledged, Landlord and Tenant covenant and agree as follows:

- 1. Landlord hereby grants Tenant the right and consents to Tenant's expansion of the Premises and the installation of a power generator as described and depicted in on Exhibit "B-1", which is attached hereto and by this reference incorporated herein, which equipment shall be considered part of the "Permitted Use" and the "Antenna Facilities" under the Lease.
- 2. The Parties acknowledge and agree that pursuant to the First Amendment, at the commencement of the First Renewal Term (March 21, 2021), Tenant shall pay Landlord Two Thousand Two Hundred and No/100 Dollars (\$2,200.00) per month ("Rent"). And, pursuant to this Second Amendment, the Rent that Tenant pays Landlord will be increased by Four Hundred and No/100 Dollars (\$400.00) per month as of the first day of the month following the completion of construction for the modification of the additional equipment. Thereafter, Rent shall be payable in accordance with the terms of the Lease.
  - 3. Paragraph 10(a) of the Lease is hereby deleted in its entirety and replaced with the following:

"Tenant shall procure and maintain for the duration of the Lease insurance against claims for injuries to persons or damage to property which may arise from or in connection with Tenant's operations and use for the leased premises. The cost of such insurance shall be borne by the Tenant. Commercial general liability (CGL) coverage shall be at least as broad as Insurance Services Office From CG 00 01 covering on an "occurrence" basis including products and completed operations, property damage, bodily injury and personal and advertising injury with limits no less than \$1,000,000 per occurrence and \$2,000,000 general aggregate. The Landlord, its officers, officials, and employees are to be covered as additional insureds on the CGL policy with respect to liability arising out of work or operations performed or on behalf of the Tenant including materials, parts, or equipment furnished in connection with the such work or operations. General liability coverage can be provided in the form of an endorsement to the Tenant's insurance (at least as broad as ISO Form CG 20 10). For any claims related to this Tenant, the Tenant's insurance coverage shall be primary insurance, with respect to the negligent acts and willful

T-Mobile Site No: SC56222A

T-Mobile Site Name: SR222 Nevada City

Market: Sacramento

misconduct of Tenant, at least as broad as ISO CG 20 01 04 13 as respects the Landlord, its officers, officials, and employees. Any insurance or self-insurance maintained by the Landlord, its officers, officials, employees, or volunteers shall be excess of the Tenant's insurance and shall not contribute with it, with respect to the negligent acts and willful misconduct of Tenant. Tenant hereby grants to Landlord a waiver of any right to subrogation which any insurer of said Tenant may acquire against the Landlord by virtue of payment of any loss under such insurance. Tenant agrees to obtain any endorsement that may be necessary to affect this waiver of subrogation, but this provision applies regardless of whether or not the Landlord has received a waiver of subrogation endorsement from the insurer. Self-insured retentions must be declared to the Landlord; Tenant shall provide financial guarantee satisfactory to Landlord guaranteeing payment of losses and related investigations, claim administration, and defense expenses; or reduce or eliminate such self-insured retentions. Tenant shall furnish to Landlord original Certificates of Insurance including all required amendatory endorsements (or copies of the applicable policy language effecting coverage required by this clause). However, failure to obtain the required documents prior to the work beginning shall not waive the Tenant's obligations to provide them."

- 4. Except as expressly set forth in this Second Amendment, the Lease otherwise is unmodified. To the extent any provision contained in this Second Amendment conflicts with the terms of the Lease, the terms and provision of this Second Amendment shall control. Each reference in the Lease to itself shall be deemed also to refer to this Second Amendment.
- 5. This Second Amendment may be executed in duplicate counterparts, each of which will be deemed an original. Signed electronic copies of this Second Amendment will legally bind the Parties to the same extent as originals.
- 6. Each of the Parties represents and warrants that it has the right, power, legal capacity and authority to enter into and perform its respective obligations under this Second Amendment. Landlord represents and warrants to Tenant that the consent or approval of a third party has either been obtained or is not required with respect to the execution of this Second Amendment.

IN WITNESS WHEREOF, the parties have executed this Second Amendment on the day and year first written above.

~	,	Chi						

County of Nevada, a political subdivision of the State of California

Tenant:

T-Mobile West LLC, a Delaware limited liability company

Landlord:

Title:

Date:

2

2021.03.

T-Mobile Site No: SC56222A

T-Mobile Site Name: SR222 Nevada City

Market: Sacramento

# **EXHIBIT B-1**

Subject to the terms and conditions of this Second Amendment, the location of the Premises (together with access and utilities) is generally described and depicted as shown below or in the immediately following attachment(s):

However, it is expressly agreed and understood by and between the Landlord and Tenant that the exact and precise location of the Tenant's Antenna Facilities are subject to review and approval by the planning and/or zoning Boards having jurisdiction over the "Premises".

Notwithstanding anything to the contrary, the specific number and type of equipment described in the Exhibit is for illustrative purposes only and in no way limits Tenant's ability to alter, replace, add to, expand, enhance, modify, supplement, replace, refurbish, relocate or upgrade any such equipment within the Premises.

See attachment(s).

T-Mobile Site No: SC56222A

T-Mobile Site Name: SR222 Nevada City

Market: Sacramento

# - Mobile

WEST LLC

# **SR222 NEVADA CITY**

SC56222A

**GENERATOR PROJECT** 980 HELLING WAY

NEVADA CITY, CA 95959 **NEVADA COUNTY** 

APN:

USE:

JURISDICTION: NEVADA CITY

DUILDING CODES:
2019 OUTGRING SULDING CODE CHANGE SUMMARY (PART 2, VOLUMES 1 & 2)
2019 OUTGRING SULDING CODE CHANGE SUMMARY (PART 2, VOLUMES 1 & 2)
2019 OUTGRING LECTRICUL CODE CHANGE SUMMARY (PART 2, VOLUMES 1 & 2)
2019 OUTGRING HECHANGEL CODE CHANGE SUMMARY (PART 3)
2019 OUTGRING PLUMBRING CODE CHANGE SUMMARY (PART 6)
2019 OUTGRING PLUMBRING CODE CHANGE SUMMARY (PART 6)

IF, DURING CONSTRUCTION OR UTILITY PLACEMENT, ANY CULTURAL RESOURCES ARE ENCOUNTERED OR SUSPECTED, WORK SHALL BE HALTED IMMEDIATELY AND THE PLANNING DEPARTMENT CONTACTED. A PROFESSIONAL ARCHAEOLOGIST SHALL BE CONSULTED TO ACCESS ANY DISCOVERIES AND DEVELOP APPROPRIATE MANAGEMENT RECOMMENDATIONS FOR ARCHAEOLOGICAL RESOURCE TREATMENT. IF BONES ARE ENCOUNTERED AND APPEAR TO BE HUMAN, THE NEVADA COUNTY CORONER SHALL BE CONTACTED AND, IF NATIVE AMERICAN RESOURCES ARE INVOLVED, NATIVE AMERICAN ORGANIZATIONS AND INDIVIDUALS RECOGNIZED BY THE COUNTY SHALL BE NOTIFIED AND CONSULTED.

# SITE DIRECTIONS

VICINITY MAP

DEPART 1755 CREEKSIDE OAKS DR. SACRAMENTO, CA. 95833 ON CREEKSIDE OAKS DR (EAST), TURN RIGHT (NORTH-EAST) ONTO MILLCREEK DR. TURN LEFT (NORTH) ONTO TRUXEL RD. TAKE RAMP, TURN LEFT (NORTH) ONTO CA-49, ROAD NAME CHANGES TO CA-20 [CA-49]. TURN LEFT (WEST) ONTO CA-49
[YUBA-DONNER SCENIC BYWAY]. TURN RIGHT (NORTH) ONTO LOCAL ROAD(S). ARRIVE AT THE EXISTING SITE.

# PROJECT DESCRIPTION

THE PROJECT CONSISTS OF INSTALLING (1) 200 AMP GENERAC AUTOMATIC TRANSFER SWITCH, (1) GENERAC 25KW DIESEL GENERATOR ON (E) CONCRETE PAD AND ASSOCIATED EQUIPMENT LOCATED WITHIN AN EXISTING CHAIN LINK COMPOUND.

DEVELOPMENT AND CONSTRUCTION OF THIS PROJECT WILL COMPLY WITH ALL APPLICABLE CODES AND ORDINANCES.

THIS PROJECT DOES NOT INCLUDE WATER OR SEWER.

EXISTING PARKING IS NOT AFFECTED BY THIS PROJECT.

- PROJECT INFORMATION AND DATA GENERAL NOTES SITE PLAN
- ENLARGED SITE PLAN
- · A-3 ELEVATIONS
- DETAILS GENERATOR SIGNAGE · A-5
- ELECTRICAL DETAILS GROUNDING DETAILS
- E-1 E-2 E-3 ELECTRICAL DETAILS

1755 CREEKSIDE OAKS DRIVE SUITE 190 SACRAMENTO, CA 95833

PROPERTY OWNER: COUNTY OF NEVADA DEPT OF GEN SERVICES 12548 LOMA RICE DR GRASS VALLEY, CA 95945

PROJECT MANAGER: T-MOBILE WEST, LLC 1755 CREEKSIDE OAKS DRIVE SUITE 190 SACRAMENTO, CA 95833 CONTACT: JIM MORAN PHONE: (707) 450-5653

SITE ACQUISITION: T-MOBILE WEST, LLC 1755 CREEKSIDE OAKS DRIVE SUITE 190 SUITE 190 SACRAMENTO, CA 95833 CONTACT: JEFF LIENERT PHONE: (916) 505-3683 CONSULTING FIRM: SINGLE SOURCE INC 22972 S. 193 STREET QUEEN CREEK, AZ 85142 CONTACT: JEREMY WATTERBERG PHONE: (602) 910-6030

- PARENT PARCEL: - ACRES EXISTING LEASE AREA: - SQ. FT
  - 2. THIS WIRELESS TELECOMMUNICATIONS FACILITY WILL MEET THE REGULATIONS OF THE FEDERAL COMMUNICATIONS CO REGARDING PHYSICAL AND ELECTROMAGNETIC INTERFERENCE.
  - LIGHTING OR SIGNS WILL BE PROVIDED ONLY AS REQUIRED BY FEDERAL OR STATE AGENCIES.

- THIS WIRELESS TELECOMMUNICATIONS FACILITY WILL MEET THE HEALTH AND SAFETY STANDARDS FOR ELECTROMAGNETIC FIELD EMISSIONS AS ESTABLISHED BY THE FEDERAL COMMUNICATIONS COMMISSION OR ANY SUCCESSOR THEREOF, AND ANY OTHER FEDERAL OR STATE AGENCY.

LATITUDE: 39" 16' 12.2694" NORTH (NADB3) LONGITUDE: -121" 01' 23.2104" WEST (NADB3)

POLE COORDINATES

## APPROVALS

DATE-T-MOBILE (RF): \_ T-MOBILE (CONST.): \_\_ T-MOBILE (RE): \_ DATE:

DATE:\_

T · Mobile WEST LLC

1755 CREEKSIDE OAKS DRIVE SUITE 190 SACRAMENTO, CA 95833



22972 SOUTH 193 STREET, QUEEN CREEK AZ 85142

PROJECT NO:	0000
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CHECKED BY:	CH

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A		ISSUE FOR REVIEW
REV	DATE	DESCRIPTION



# SR222 NEVADA CITY

SC56222A 980 HELLING WAY

NEVADA CITY, CA 95959 NEVADA COUNTY

PROJECT INFORMATION AND



#### GENERAL NOTES:

- FOR THE PURPOSE OF CONSTRUCTION DRAWING, THE FOLLOWING DEFINITIONS SHALL APPLY: CONTINUETOR TEX SUBCONTINUETOR CENERAL CONTRACTOR (CONSTRUCTION) UNICE T-MUSIEL CM ORIGINAL EQUIPMENT MANUFACTURE
- PROR TO THE SUBMISSION OF BIDS, THE BIDDING SUBCONTRACTOR SHALL VISIT THE CELL SITE TO
  FAMILHARIZE WITH THE EXISTING CONCIDING AND TO CONFIRM THAT THE WORK CAN BE
  ACCOMPLISHED AS SHOWN ON THE CONSTRUCTION DIRBRINGS. ANY DISCREPANCY FOUND SHALL
  BE BROUGHT TO THE ATTENTION OF CONTRACTOR.
- 3. ALL WHITEMAL TREMENDO AND WRITEMAL TO MALL ME IN STREET ECOMMUNICATION. AND APPROPRIATE COORDINATES WHITE MALL APPROPRIATE COORTIS REGULATION, WHITE MALL LIMIT, ORIGINATIONS FROM COORTIS AND COMPUTED AND COMPUT
- DRAWINGS PROVIDED HERE ARE NOT TO BE SCALED AND ARE INTENDED TO SHOW OUTLINE ONLY.
- 6. DELETED.

- SUBCONTRACTOR SHALL DETERMINE ACTUAL ROUTING OF CONDUT, POWER AND T1 CARLES, ORDINANO CARLES AS SHOWN ON THE POWER, ORDINANG, AND TLOC PLAN DEMBNO. SUBCONTRACTOR SHALL FULLE SETTING TRANS AND/OR SHALL AND NEW TRAYS AS RECESSARY, SUBCONTRACTOR SHALL LOWER THE ACTUAL ROUTING WITH THE CONTRACTOR, ROUTING OF THERCHORY SHALL BE APPROPED BY CONTRACTOR.

- ALL CONCRETE REPAIR WORK SHALL BE DONE IN ACCORDANCE WITH AMERICAN CONCRETE INSTITUTE (ACI) 301.
- 14. ANY NEW CONCRETE NEEDED FOR THE CONSTRUCTION SHALL HAVE 4000 PSI STRENGTH AT 28 DAYS UNLESS OTHERWISE SPECIFICALL CONCRETING WORK SHALL BE DONE IN ACCORDANCE WITH ACT 318 CODE REQUIREMENTS.
- 15. ALL STRUCTURAL STEEL WORK SHALL BE DONE IN ACCORDANCE WITH AISC SPECIFICATIONS.
- CONSTRUCTION SHALL COMPLY WITH SPECIFICATION 25741-000-3APS-AGOZ-D0002, "GENERAL CONSTRUCTION SERVICES.
- 17. SUBCONTRACTOR SHALL VERRY ALL EXISTING DIMENSIONS AND CONDITIONS PRIOR TO COMMENCING ARY WORK. ALL DIMENSIONS OF EXISTING CONSTRUCTION SHOWN ON THE DRIANNOS MUST BE VERRIED SUBCONTRACTOR SHALL NOTIFY THE CONTRACTOR OF ANY DISCREPANCIES PRIOR TO ORDERING MATERIAL OR PROCEEDING WITH CONSTRUCTION.
- 18. THE ENSTRUC COLL CITE IS IN FULL COMMERCIAL OFFENDING, MICH CONSTRUCTION, WITH CONSTRUCTION WHO RE SUSCIONARCHE SHALL COMMERCIAL OFFENDING, AND CONSTRUCTION WAS VERBOR OF THE DESTRUCTION AND VERBOR OFFENDING, AND VERBOR OFFENDING, AND VERBOR OFFENDING AND V
- 19. SINCE THE CELL SITE MAY BE ACTIVE, ALL SAFETY PRECAUTIONS MUST BE TAKEN WHEN WORKING AROUND HIGH LEVELS OF ELECTROMAGNETIC ROUNDON, EQUIPMENT SHOULD BE SWITDOWN PROOK TO PERFORMEN ANY WORK THAT COULD EPPOSE THE WORKERS TO DAMESE, PREPSOUND, RE EXPOSURE MONITORS ARE REQUIRED TO BE WORN TO ALERT OF ANY DANGEROUS DIPPOSURE LEVALS.

# CONCRETE AND REINFORCING STEEL NOTES:

- ALL CONCRETE WORK SHALL BE IN ACCORDANCE WITH THE ACI 301, ACI 318, ACI 336, ASTM A184, ASTM A185 AND THE DESIGN AND CONSTRUCTION SPECIFICATION FOR CAST—IN-PLACE CONCRETE.
- ALL CONCRETE SHALL HAVE A MINIMUM COMPRESSIVE STRENGTH OF 4000 PSI AT 28 DAYS, UNLESS NOTED OTHERWISE.
- RENFORCING STEEL SHALL CONFORM TO ASTM A 615, CRADE 60, DEFORMED UNLESS NOTED OTHERWISE. WELDED WRIE FABRIC SHALL CONFORM TO ASTM A 185 WELDED STEEL WRIE FABRIC UNLESS NOTED OTHERWISE. SPLICES SHALL BE CLASS "B" AND ALL HOOKS SHALL BE STANDARD, URD.
- 4. THE FOLLOWING MINIMUM CONCRETE COVER SHALL BE PROVIDED FOR REINFORCING STEEL UNLESS SHOWN OTHERWISE ON DRAWINGS:

CONCRETE EXPOSED TO EARTH OR WEATHER: 

 CONCRETE NOT EXPOSED TO EARTH OR WEATHER OR NOT CAST AGAINST THE GROUND:
 3/4 IN.

 SLAB AND WALL
 1-1/2 IN. BEAMS AND

A CHAMFER  $3/4^{\circ}$  SHALL BE PROVIDED AT ALL EXPOSED EDGES OF CONCRETE, UNO, IN ACCORDANCE WITH ACI 301 SECTION 4.2.4.

- AN ORDER CHARGE TOTS IN OR REQUIRED FOR SUID ON ORDER WENT CONCRETE IS LESS THAN 50 CARE THROUGH (BET INDICALS) IN THAT DOUT THE FOLLOWING RECORDS SHALL BE PROVIDED BY A PROVIDED BY A

#### GROUNDING NOTES:

- THE SUBCONTINUTOR SHALL REVIEW AND INSPECT THE DISTING FACILITY CHOLORISM SYSTEM AND LIGHTHMAN PROTECTION SYSTEM (SO DESCRIBED AND INSPECTION FOR STREET COMPUNIES PROTECTION COST, AND CARRIES, COMPUNIES WITH TERRORS AND THE REPORT AND STANDARDS, THE SUBCONTRACTOR SHALL REPORT ANY VOLATIONS ON ADVENCE PROMOS TO THE CONTINUED ON RESOLUTION.
- 2. ALL GROUND ELECTRODE SYSTEMS (INCLUDING TELECOMMUNICATION, RADIO, LIGHTNI
- 3. THE SUBCONNECTION SHALL PREFORM EXTENSIVE WITH THE MIC.

  3. THE SUBCONNECTION SHALL PREFORM EXTENSIVE TO LARTH
  TESTING FIRE SET 1100 AND 81) FOR NEW GOLDON ELECTROCE SYSTEMS. THE
  SUBCONNECTION SHALL PRIMER AND ROBATIL SUPERIDINATE, GROWN ELECTROCES AND IN
  ACCORNACE WITH 26471-000-3PS-E000-2001, DESDA & TESTING OF PACIFITY GROWNERS FOR
  CLL SITES.
- METAL PACEWAY SHALL NOT BE USED AS THE NEC REQUIRED EQUIPMENT GROUND CONDUCTOR. STRANDED COPPER CONDUCTORS WITH ORDER INSULATION, SIZED IN ACCORDANCE WITH THE NC., SHALL BE FURNISHED AND INSTALLED WITH THE POWER CIRCUITS TO BTS EQUIPMENT.
- 6. EXOTHERMIC WELDS SHALL BE USED FOR ALL GROUNDING CONNECTIONS BELOW GRADE.
- APPROVED ANTIOXIDANT COATINGS (I.E., CONDUCTIVE GEL OR PASTE) SHALL BE USED ON ALL COMPRESSION AND BOLTED GROUND CONNECTIONS.
- ALUMINUM CONDUCTOR OR COPPER CLAD STEEL CONDUCTOR SHALL NOT BE USED FOR GROUNDING CONNECTIONS.
- MISCELLANEOUS ELECTRICAL AND NON-ELECTRICAL METAL BOXES, FRAMES AND SUPPORTS SHALL BE BONDED TO THE GROUND RING, IN ACCORDANCE WITH THE NEC.
- METAL CONDUIT AND TRAY SHALL BE GROUNDED AND MADE ELECTRICALLY CONTINUOUS USTED BONDING FITTHINGS OR BY BONDING ACROSS THE DISCONTINUITY WITH 6 AWG COFWIRE UL APPROVED GROUNDING TYPE CONDUIT CLAMPS.
- 12. GROUND CONDUCTORS USED IN THE FACULTY GROUND AND USHTHING PROTECTION SYSTEMS SMALL, NOT BE ROUTED THROUGH METALLIC GREETS THAT TIME A RISK AROUND THE SMALLS GREET CONTROL OF THE ROUTED THROUGH THROUGH THE RESEARCH OF THE ROUTED THROUGH TO METALL GREET GROUNDERS OF THROUGH AND THE ROUTED AND CONDUCT SMALL BE USED. WHERE USE OF WALL CONDUCT SAWL GREEN CONTROL FROM THE RESEARCH OF WALL CONDUCT SAWL GREEN CONTROL FROM THE RESEARCH OF WALL CONDUCT SAWL GREEN CONTROL FROM THE RESEARCH SAWL CONTROL OF MALKONDOWN CON-MICROLIC CONDUCT PROVINGED BY LOCAL CODE) THE GROUND CONDUCTOR SHALL BE BONDED TO EACH END OF THE METAL
- 13, ALL MONOPOLE GROUNDING SYSTEMS SHALL COMPLY WITH THE REQUIREMENTS OF ANSI/TIA 222. FOR MONOPOLES BEING BUILT TO REV G OF THE STANDARD, THE WIRE SZE OF THE BURIED GROUND RING AND CONNECTIONS BETWEEN THE WORKPOLE AND THE BURIED GROUND RING SHALL BE CHANCED FROM 2 AND TO 2 OF ARC. IN ADDITION, THE MINIMUM LENGTH OF THE GROUND ROOS SITE WAS ARCHIVEN AND ADDITION. TO FEET.
- THE SUBCONTRACTOR SHALL CONTACT UTILITY LOCATING SERVICES PRIOR TO THE START OF CONSTRUCTION
- ALL DISTING ACTIVE SEWER, WATER, CAS, LILCTRIC, AND OTHER UTLITIES WHERE DECOAMTED IN THE KNOW, SHALL BE PROTECTED AT ALL TRUES, AND WHERE REQUIRED CONTRACTORS, LITERATURE CAUTION SHALL BE USED BY THE ASSOCIATION WHEN EXCAMATION OF DEPLOY CAUTION SHALL BE USED BY THE ASSOCIATION SHALL PROTECTION OF A SHALL BE USED AS THE ASSOCIATION SHALL PROTECTION OF A SHALL BE USED ASSOCIATION SHALL BE USED AS A SHALL BE USED.
- 3. ALL SITE WORK SHALL BE AS INDICATED ON THE DRAWINGS AND PROJECT SPECIFICATIONS IF NECESSARY, RUBBISH, STUMPS, DEBRIS, STICKS, STONES AND OTHER REFUSE SHALL BE REMOVED FROM THE SITE AND DISPOSED OFF LEGALLY.
- ALL EVISTING INACTIVE SEWER, WATER, CAS, ELECTRIC AND OTHER UTILITIES, WHICH INTERFER WITH THE EXECUTION OF THE WORK, SHALL BE REMOVED AND/OR CAPPED, PLUGGED ON ENTERMISE DESCRIFTING AT POINTS WHICH WILL NOT INTERFERE WITH THE EXECUTION OF THE WORK, SUBJECT TO THE APPROVAL OF CONTRACTOR, OWNER AND/OR LOCAL UTILITY.
- 6. SUBCONTRACTOR SHALL MINIMIZE DISTURBANCE TO EXISTING SITE DURING CONSTRUCTION.
- THE SUBCONTRACTOR SHALL PROVIDE SITE SIGNAGE IN ACCORDANCE WITH THE VERIZON WIRELESS SPECIFICATION FOR SITE SIGNAGE.
- THE SITE SHALL BE GRADED TO CAUSE SURFACE WATER TO FLOW AWAY FROM THE BTS EQUIPMENT AND MONOPOLE AREAS.
- NO FILL OR EMBANKMENT MATERIAL SHALL BE PLACED ON FROZEN GROUND. FROZEN MATERIALS. SNOW OR ICE SHALL NOT BE PLACED IN ANY FILL OR EMBANKMENT.
- THE SUB GRADE SHALL BE COMPACTED AND BROUGHT TO A SMOOTH UNIFORM GRADE PRIOR TO PRISHED SURFACE APPLICATION.
- 11. THE AREAS OF THE OWNERS PROPERTY DISTURBED BY THE WORK AND NOT COVERED BY THE MONOPOLE, EQUIPMENT OR DRIVEWAY, SHALL BE GRADED TO A UNIFORM SLOPE, AND STABILIZED TO PREVENT EROSION.
- SUBCONTRACTOR SHALL MININEZE DISTURBANCE TO EXISTING SITE DURING CONSTRUCTION, ERROGION CONTROL MESSIRES, IF REQUIRED DURING CONSTRUCTION, SHALL BE IN CONFIDEMANCE WITH THE LOCAL JURISDICTION'S GUIDELINES FOR EROSION AND SEDIMEN CONTROL.

#### ELECTRICAL INSTALLATION NOTES:

- WRING, RACEWAY, AND SUPPORT METHODS AND MATERIALS SHALL COMPLY WITH THE REQUIREMENTS OF THE NEC AND TELCORDIA.
- SUBCONTRACTOR SHALL MODIFY EXISTING CABLE TRAY SYSTEM AS REQUIRED TO SUPPORT RF AND TRANSPORT CABLING TO THE NEW BTS EQUIPMENT, SUBCONTRACTOR SHALL SUBBINT MODIFICATIONS TO CONTRACTOR FOR APPROVIAL.
- 3. ALL CIRCUITS SHALL BE SECREGATED AND MAINTAIN MINIMUM CABLE SEPARATION AS REQUIRED BY THE NEC AND TRICORDIA.
- 4. CABLES SHALL NOT BE ROUTED THROUGH LADDER-STYLE CABLE TRAY RUNGS.
- EACH END OF EVERY POWER, ORDUNDING, AND T1 CONDUCTOR AND CABLE SHALL BE USELED WITH COCKE-COORD INSULATION OR ELECTRICAL TAPE (IN BRAND, 1/2 INCH PLASTIC ELECTRICAL TAPE WITH UV PROTECTION, OR EQUAL). THE EMPHRENATION METHOD SHALL CONFORM WITH NEC & CORM, AND MATCH EXISTING RISTALLATION REQUIREMENTS.
- 6. POWER PHASE CONDUCTORS (I.E., HOTS) SHALL BE LABELED WITH COLOR-COORD INSULATION OR ELECTRICAL TAPE (SM BOAND, 1/6 NICH PUSTIC BLECTRICAL TAPE WITH LAY PROTECTION, OR EQUAL), PHASE CONDUCTOR COLOR CODES SHALL CONFORM WITH THE NEC & OSHA AND MATCH EXISTING RISTALATION RECOMMENTS.
- ALL ELECTRICAL COMPONENTS SHALL BE CLEARLY LABELED WITH ENGRANDE LAMACOD PLASTIC LABELS, ALL EQUIPMENT SHALL BE LABELED WITH THEIR VOCTAGE RATING, PHASE COMPROGRANDIG, WIRE CONFUNCTION, PORCE OR AMPACITY RATING, AND BRANCH CIRCUIT ID NUMBERS (I.E., PANELBOARD AND CIRCUIT (D'S).
- PANELBOARDS (ID NUMBERS) AND INTERNAL CIRCUIT BREAKERS (CIRCUIT ID NUMBERS) SHALL BE CLEARLY LABELED WITH ENGRAVED LAWACOID PLASTIC LABELS.
- 10. POMER, CONTROL, AND EQUIPMENT CROUND WRING IN TUBING OR CONDUIT SHALL BE SINGLE CONDUCTOR (12 AND OR LARGER), 600 V. OIL, RESISTANT THEN OR THAN-2, CLASS B STRANDED COPPER CALE PARTE OF 80 OF (WET AND DIV) OPERATION, LEICH OR HABELED FOR THE LOCATION AND RACEWAY SYSTEM USED, LINLESS OTHERWISE SPECIFED.
- 11, SUPPLEMENTAL COUPMENT GROUND WIRING LOCATED INDOORS SHALL BE SHOLE CONDUCTOR (6 AND OR LARGER), 600 Y, OIL RESISTANT THING OR THAN-2 DEEDN MISULATION, CLASS B STRANGED COPPER CHALE RATED FOR 90 °C (MIXT AND DRY) OPERATION; LISTED OR LARGELED FOR THE LOCATION AND PROCERNY SYSTEM USED, UNLESS OTHERWISE SPECIFIED.
- SUPPLEMENTAL EQUIPMENT GROUND WIRING LOCATED OUTDOORS, OR BELOW GRADE, SHALL BE SINGLE CONDUCTOR 2 AWG SOLID TINNED COPPER CABLE, UNLESS OTHERWISE SPECIFIED.
- 13. POMER WIRNO, NOT IN TUBING OR CONDUIT, SHALL BE MULTI-CONDUCTOR, TYPE TO CHALE (12 AND OR LANGER), 600 Y. OIL, RESISTANT THHN OR THIM-2, CLASS B STRANGED COPPER CHALE BATTO FOR 90°C (NET AND ERTY) OPERATION, WITH OUTER JACKET; USTED OR LABELED FOR THE LOCATION USED, UNLESS CHILETHINES SPECIFIC.
- 14. ALL POWER AND GROUNDING CONNECTIONS SHALL BE CRIMP-STYLE, COMPRESSION WRIE LUGS AND WREDLITS BY THOMAS AND BETTS (OR EQUAL). LUGS AND WREDLITS SHALL BE RATED FOR OPERATION AT NO LESS THAN 75°C (30°C IF AMALBEL).
- 16. NEW RACEWAY OR CABLE TRAY WILL MATCH THE EXISTING INSTALLATION WHERE POSSIBLE.

- CALVANIZED STEEL INTERMEDIATE METALLIC CONDUIT (IMC) SHALL BE USED FOR OUTDOOR LOCATIONS ABOVE CRUDE.
- LIQUID-TIGHT FLEXIBLE METALLIC CONDUIT (LIQUID-TITE FLEX) SHALL BE USED INDOORS AND OUTDOORS, WHERE VIBRATION OCCURS OR FLEXIBILITY IS NEEDED.
- CONDUIT AND TUBING FITTINGS SHALL BE THREADED OR COMPRESSION—TYPE AND APPROVED FOR THE LOCATION USED, SETSCREW FITTINGS ARE NOT ACCEPTABLE.
- CABINETS, BOXES, AND WIREWAYS SHALL BE LISTED OR LABELED FOR ELECTRICAL USE IN ACCORDANCE WITH NEMA, UL, ANSI/IEEE, AND NEC.
- 24. CABINETS, BOXES, AND WIREWAYS TO MATCH THE EXISTING INSTALLATION WHERE POSSIBLE.
- 25. WREWAYS SHALL BE EPOXY-COATED (GRAY) AND INCLIDE A HINGED COVER, DESIGNED TO SWING OPEN DOWNARDS, SHALL BE PANQUIT TYPE E (OR EDUAL); AND RATED NEMA 1 (OR BETTEN) BROOMS, OR NEMA 3R (OR BETTEN) OUTDOORS.
- 26. EQUIPMENT CABINETS, TERMINAL BOXES, JUNCTION BOXES, AND PULL BOXES SHALL BE CALVANIZED OR EPOXY-COATED SHEET STEEL, SHALL MIET OR EXCEED UL 50, AND RATED NEMA 1 (OR BETTER) INDOORS, OR NEMA 28 (OR BETTER) GUTOORD
- METAL RECEPTACLE, SWITCH, AND DEVICE BOXES SHALL BE CALVANIZED, EPOXY—COATED, OR NON-CORRODING, SHALL MEET OR EXCEED UL SITAA AND NEBA OS 1; AND RATED NEMA 1 (OR BETTER) MOODINS, OR WATHER PROTECTED (MP OR BETTER) OUTDOORS.
- THE SUBCONTRACTOR SHALL NOTIFY AND OBTAIN NECESSARY AUTHORIZATION FROM THE CONTRACTOR BEFORE COMMENCING WORK ON THE AC POWER DISTRIBUTION PANELS.
- 30. THE SUBCONTRACTOR SHALL PROVIDE NECESSARY TAGGING ON THE BREAKERS, CABLES AND DISTRIBUTION PARIES IN ACCORDANCE WITH THE APPLICABLE CODES AND STANDARDS TO SAFEDIAMED AGAINST LIFE AND PROPERTY.

### SOIL COMPACTION NOTES FOR SLAB ON GRADE:

- EXCAVATE AS REQUIRED TO REMOVE VEGETATION & TOPSOIL EXPOSE UNDISTURBED NATURAL SUBGRADE AND PLACE CRUSHED STONE AS
- AS AN ALTERNATIVE TO ITEM 20. THE "UNDISTURBED SOIL" BASE SHALL BE COMPACTED WITH "COMPACTION EQUIPMENT", USTED BELOW, TO AT LEAST 90% MODIFIED PROCTOR MAXIMUM DENSITY PER ASTM D 1557 METHOD C.
- AS AN ALTERNATIVE TO ITEMS 20 AND 25 PROOFFICE THE SUBGRADE SOLES WITH 5 PASSES OF A MEDIAM SIZED VIOLATION PLANT COMPACTOR VIOLATION COMPACTOR VIOLATION FOLIAGE (SUCH AS 1900A BY 555). AN SOLT AMERICA THAT AND COMPACTOR SOLED SEPLACED WITH A WELL-GRADED SCHALLER FLIL, AND COMPACTOR AS STATUS ABOVE.
- COMPACTED SUBBASE SHALL BE UNIFORM & LEVELED. PROVIDE 6" MINIMUM CRUSHED STONE OR GRAVEL COMPACTED IN 3" LIFTS ABOVE COMPACTED SOIL GRAVEL SHALL BE NATURAL OR CRUSHED WITH 100X PASSING 1" SIEVE.

# COMPACTION EQUIPMENT:

HAND OPERATED DOUBLE DRUM, VIBRATORY ROLLER, VIBRATORY PLATE COMPACTOR OR JUMPING JACK COMPACTOR.

SYMBOLS

S/G SOLID GROUND BUS BAR S/N SOLID NEUTRAL BUS BAR

0 0 SUPPLEMENTAL GROUND BAR

SINGLE-POLE THERMAL-MAGNETIC CIRCUIT BREAKER

CHEMICAL GROUND ROD 

DISCONNECT SWITCH

METER

CADWELD TYPE CONNECTION

COMPRESSION TYPE CONNECTION

- - GROUNDING WIRE

# **ABBREVIATIONS**

AGL ABOVE GRADE LEVEL

BTS BASE TRANSCEIVER STATION

(E) EXISTING

NEW NEW

MIN MINIMUM

N.T.S. NOT TO SCALE

REF REFERENCE

RF RADIO FREQUENCY

TYP TYPICAL

REQ REQUIRED

EGR EQUIPMENT GROUND RING

AWG AMERICAN WIRE GAUGE

(MASTER GROUND BAR)

EG EQUIPMENT GROUND

BCW BARE COPPER WIRE SIAD SMART INTEGRATED ACCESS DEVICE

IGR INTERIOR GROUND RING (HALO) SYMBOLS & ABBREVIATIONS

RBS RADIO BASE STATION

PREPARED FOR



1755 CREEKSIDE OAKS DRIVE SUITE 190 SACRAMENTO, CA 95833

CONSULTING FIRM

PROJECT NO:



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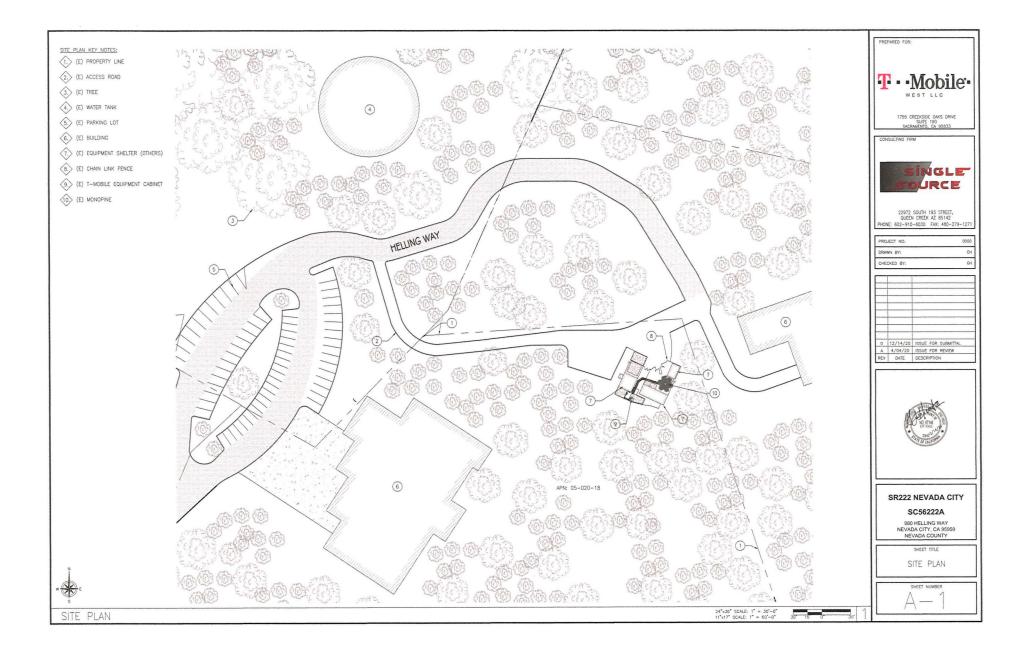
# **SR222 NEVADA CITY**

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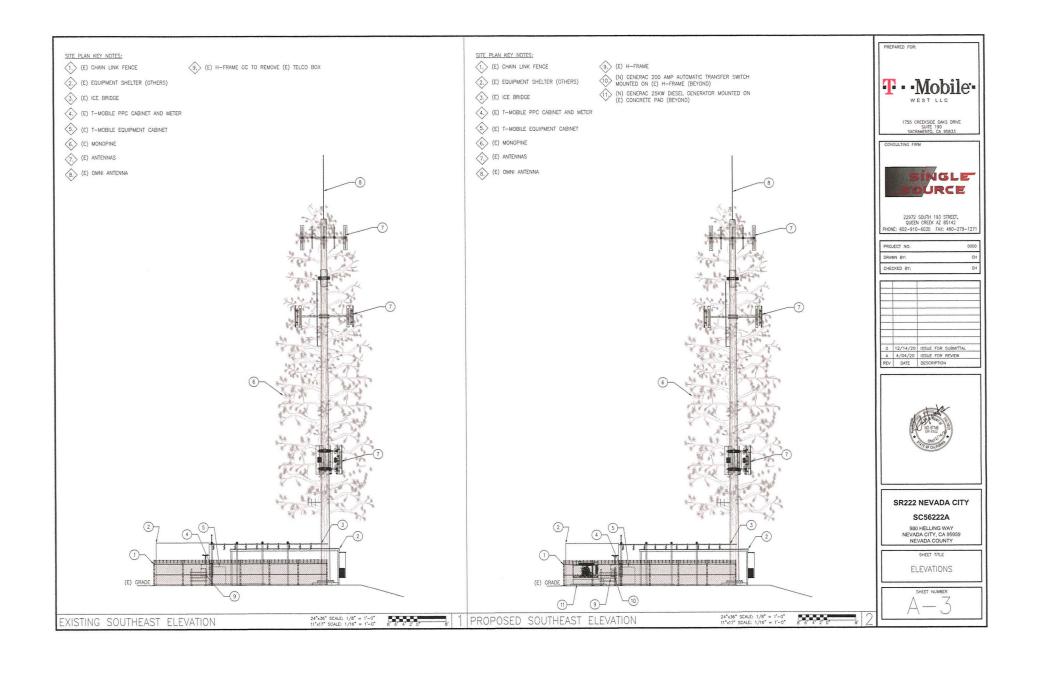
NEVADA CITY, CA 95959 NEVADA COUNTY

GENERAL NOTES

SHEET NUMBER








# SPECIFICATIONS

MODEL	RXSC200A3
AMPS	200
VOLTAGE	120/240, 16
LOAD TRANSITION TYPE (AUTOMATIC)	OPEN TRANSITION
ENCLOSURE TYPE	NEMA/UL 3R
UL RATING	UL/CUL

# DIMENSIONS


MOD	EL	RXSC200A3		
HEIGHT	Н1	17.24/437.9		
(IN./MM)	H2	20/508		
WIDTH	W1	12.5/317.5		
(IN./MM)	W2	14.6/370.8		
DEP (IN./		7.09/180.1		
WEIG		20/9.07		

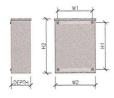



# GENERAC 200 AMP AUTOMATIC TRANSFER SWITCH

5/8" HILTI KWIK — CONCRETE WALL	NOTES:
OR SLAB	1 CHRETITION OF A HILTI KWIK

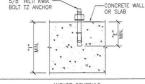


			At	CHOR SCHEE	DULE					
BOLT DIAMETER	3/8	. 1	1,	/2"	5/	8"			3/4	•
BIT DIAMETER	3/8	3/8"		1/2"		5/8"		3/4"		-
"E" MIN. EMBEDMENT DEPTH	2"		2*	3-1/4*	3-1/8"	4	•	3-3	/4"	4-3/4
T" MIN. THICKNESS	4"	5*	4"	6"	5*	6"	8*	6"	8"	8"
MIN. EDGE DISTANCE	2-1/	2"	2-	7/8"	3-1/4"	2-3	5/8"	4-1	/4"	4"
PULLOUT STRENGTH CRACKED CONCRETE	2,340	LBS	N/A	3,180 LBS	N/A	5,84	0 LBS	8,110	LBS	N/A


ANCHOR SCHEDULE NOTE: INFORMATION SHOWN IN THIS TABLE IS IN ACCORDANCE WITH: ICC REPORT ESR-1917

SUBSTITUTION OF A HILTI KWIK BOLT TZ ANCHOR WITH OTHER EXPANSION ANCHORS MANUFACTURED BY HILTI OR BY OTHER MANUFACTURED IS NOT ALLOWED WITHOUT THE WRITTEN APPROVAL OF THIS ENGINEERING PRIOR TO INSTALLATION. THE CONTRACTOR SHALL BEAR THE ENTIRE COST OF REPLACEMENT OF NON-APPROVED ANCHORS.

scale: 2

- 2. THE CONTRACTOR SHALL ACCURATELY LOCATE ALL EXISTING REINFORCING BY X-RAY OF EQUIVALENT METHOD, NO REBAR OF RETHONORS SHALL BE CUT. ALL EXPENSES RELATED TO REPAIR OF CUT REBAR OR TENDONS SHALL BE ENTIRELY AT THE EXPENSE OF THE CONTRACTOR.
- SPECIAL INSPECTION IS REQUIRED FOR INSTALLATION OF ANCHORS.
- INSTALLATION OF CONCRETE ANCHORS IN MASONRY IS NOT ALLOWED.
- 5. USE STAINLESS STEEL FOR EXPOSED APPLICATIONS.
- NORMAL-WEIGHT AND SAND-WEIGHT CONCRETE MUST CONFORM TO SECTIONS 1903 AND 1905 OF THE IBC.

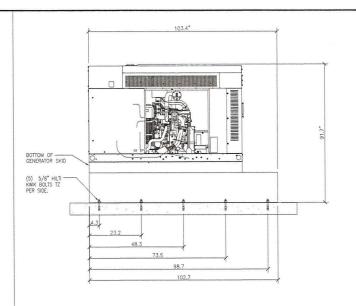

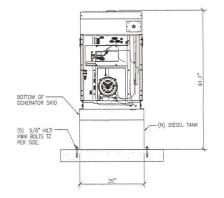

LEVEL 2 SOUND ATTENUATION ENCLOSURE
RUN TIME HOURS: 98
USABLE CAPACITY GAL: 240
L X W X H: 103.4 X

240 103.4 X 35 X 91.7

WEIGHT Ibs (with skid): SOUND LEVEL:

2,161 65 dBA







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# SR222 NEVADA CITY

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980 HELLING WAY NEVADA CITY, CA 95959 NEVADA COUNTY

> SHEET TITLE DETAILS

SCALE: 3 GENERAC 25KW DIESEL GENERATOR

HILTI KWIK BOLT TZ ANCHOR

SCALE: NTS

- ALL SIGNS SHALL BE UV-RESISTANT FOR OUTDOOR USE.
- 2. ALL SIGNS SHALL HAVE A MINIMUM 5-YEAR GUARANTEE WITHOUT SHOWING ANY SIGNS OF FADING OR DEGRADATION
- ALL SIGNS SHALL HAVE ROUNDED CORNERS WITH PRE-DRILLED HOLES AND WEATHER PROOF PRESSURE SENSITIVE ADHESIVE BACKING FOR MOUNTING.
- ALL SIGNS SHALL BE PROVIDED PER THEIR SPECIFIC REQUIREMENTS, UNLESS OTHERWISE SPECIFIED DUE TO SIZE RESTRAINTS OR LANDLORD DEMANDS.

GENERAL SIGNAGE NOTES

# NO SMOKING OR OPEN FLAMES WITHIN 25 FEET

SIGN REQUIREMENTS:

MATERIAL 8 1/2"x11" 60ML THICK WHITE PLASTIC.

COLOR AND LETTERING PER OSHA 1910.145:
RECULATIONS OF ACCIDENT PREVENTION SIGNS AND TAGS.


MOUNTING - VERTEY MOUNTING LOCATION WITH LOCAL FIRE INSPECTIOR

DANGER SIGNAGE


## SPECIFICATIONS:

- FONT STYLE USED:
   NUMBERS-HELVETICA BOLD EXTENDED
   LETTERS-HELVETICA BLACK BT
- NUMBERS SHALL BE A MINIMUM OF 3-1/2" HIGH WITH 11/16" STOKE WIDTH
- 3. LETTERING FOR WHITE SPECIAL HAZARD BOX:
  ONE LINE: 1-3/4" HIGH WITH 9/16" STROKE WIDTH
  TWO LINES: 1-3/8" HIGH WITH 7/16" STROKE WIDTH
  THREE LINES: 1-1/4" HIGH WITH 3/8" STROKE WIDTH
- NUMBERS AND LETTERS ARRANGED BY COLOR AS SHOWN ABOVE.
- SIGN SHALL BE POSTED AT LOCATION APPROVED BY THE CITY'S FIRE DEPARTMENT

TANK SIGNAGE SPECIFICATIONS

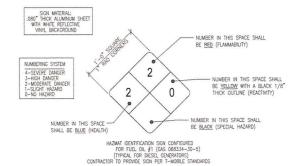

TANK SIGNAGE

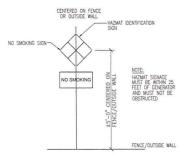

HAZMAT SIGNAGE

PREPARED FOR:



1755 CREEKSIDE OAKS DRIVE SUITE 190 SACRAMENTO, CA 95833

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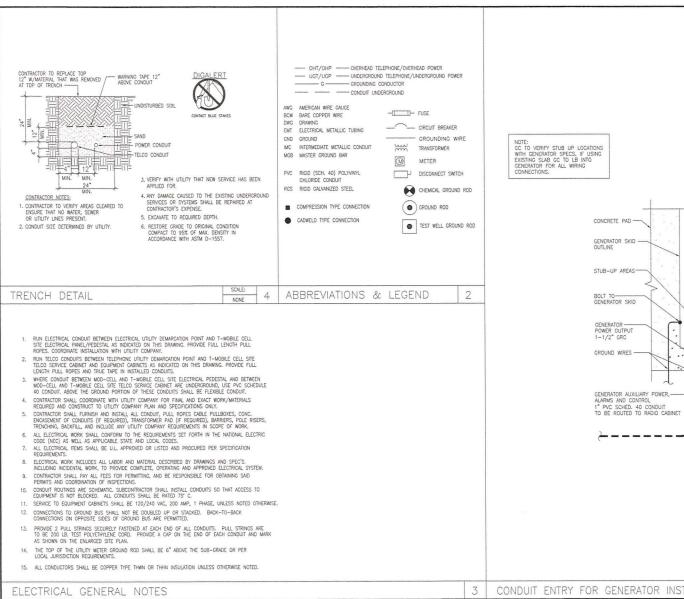
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980 HELLING WAY NEVADA CITY, CA 95959 NEVADA COUNTY

> GENERATOR SIGNAGE



GENERATOR SIGNAGE



T · Mobile 1755 CREEKSIDE OAKS DRIVE SUITE 190 SACRAMENTO, CA 95833

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# SR222 NEVADA CITY SC56222A

980 HELLING WAY NEVADA CITY, CA 95959 NEVADA COUNTY

> SHEET TITLE ELECTRICAL DETAILS

SHEET NUMBER

CONDUIT ENTRY FOR GENERATOR INSTALLATIONS

Pres

1. 111


1 111 111

1 411

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- SUBCONTRACTOR SHALL FIELD VERIFY, WITHIN THE SCOPE OF WORK, THAT ALL EXISTING CONDUITS, CONDUCTORS, CONDUIT
  STUB-UPS, AND ELECTRICAL EQUIPMENT/RATINGS ARE INSTALLED PER NEC AND LOCAL AUTHORITIES HAVING JURISDICTION.
- 2. FOR COMPLETE INTERNAL WIRING AND ARRANGEMENT REFER TO DRAWINGS PROVIDED BY EQUIPMENT MANUFACTURERS.
- PROWDE SIGNS AT SERVICE ENTRANCE EQUIPMENT AS REQUIRED BY NEC ARTICLE 702.8 INDICATING SITE HAS ON-SITE AUTOMATIC START STANDBY GENERATOR.
- 4. THIS SITE IS NOT REQUIRED BY A DETERMINING AGENCY TO BE A LEGALLY REQUIRED SYSTEM.
- 5. THE PROPOSED STANDBY GENERATOR IS NOT A SEPARATELY-DERIVED POWER SYSTEM.
- 6. THE GENERATOR SIZE HAS BEEN SPECIFIED BY THE CLIENT. THE CLIENT SHALL BE SOLELY RESPONSIBLE FOR ASSURING THAT THE LOAD
- THE CONTRACTOR SHALL VERRY THE AVAILABLE FAULT CURRENT WITH THE SERVING UTILITY AND SHALL USE THAT DATA TO CALCULATE THE AVAILABLE FAULT CURRENT AT THE AUTOMATIC TRANSFER SWITCH. THE AUTOMATING TRANSFER SWITCH SHALL BE SUITABLE FOR USE AT THE CALCULATED THAT CURRENT.



STANDBY GENERATOR SINGLE-LINE DIAGRAM

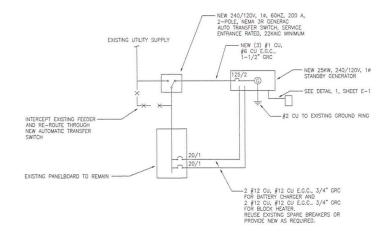- (N) GENERAC 25KW DIESEL GENERATOR GROUND TO GROUND RING (FIELD VERIFY LOCATION)
- (N) GENERAC 200 AMP AUTOMATIC TRANSFER SWITCH GROUND TO GROUND RING (FIELD VERIFY LOCATION)

NOTE: CONTRACTOR TO FIELD VERIFY LOCATION OF (E) EQUIPMENT GROUND RING



1755 CREEKSIDE DAKS DRIVE SUITE 190 SACRAMENTO, CA 95833



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> SHEET TITLE GROUNDING DETAILS





2

25KW STANDBY GENERATOR SINGLE-LINE DIAGRAM

