

NEVADA COUNTY Department of Public Works Project Plans

Combie Road Corridor Improvements

County Contract No. 440814


To be supplemented with Standard Plans and Specifications dated 2015, of the California Department of Transportation
& Nevada County Standard Plans

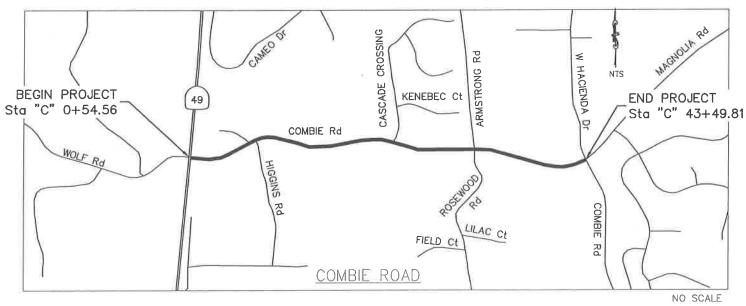

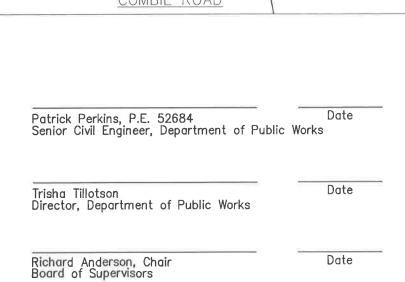

INDEX MAP



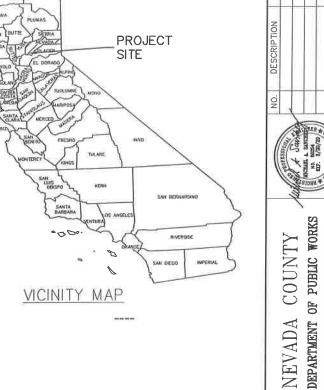



REVISIONS

COMBIE ROAD CORRIDOR IMPROVEMENT PROJECT

DRAWING:N09-300rab001.dag DESIGNED: CHECKED: JOB NO: NO9-300 DATE: Jan 10, 201 SHEET

1 OF1 07 SHEETS

SHEET INDEX SHT NO DESCRIPTION

TYPICAL CROSS SECTIONS

| 5-10 | LAYOUT |
|--------|--|
| 11-14 | PROFILE & SUPERELEVATION |
| 15-32 | CONSTRUCTION DETAILS |
| 33-39 | EROSION CONTROL PLANS, & QUANTITIES |
| 40 | CONTOUR GRADING |
| 41-54 | DRAINAGE PLANS, PROFILE, DETAILS, & QUANTITIES |
| 55-60 | UTILITY PLAN |
| 61 | CONSTRUCTION AREA SIGNS |
| 62-64 | SEWER PLAN & PROFILE |
| 65 | SEWER DETAILS |
| 66-83 | STAGE CONSTRUCTION & TRAFFIC HANDLING PLANS & |
| | QUANTITIES |
| 84-86 | PAVEMENT DELINEATION AND SIGN PLAN |
| 87 | PAVEMENT DELINEATION DETAILS |
| 88-89 | PAVEMENT DELINEATION QUANTITIES |
| 90-91 | SIGN QUANTITIES |
| 92-95 | SUMMARY OF QUANTITIES |
| 96-107 | ELECTRICAL PLANS |

NOTES:

- 1. DIMENSIONS OF THE PAVEMENT STRUCTURES (STRUCTURAL SECTIONS) ARE SUBJECT TO THE TOLERANCES SPECIFIED IN THE STANDARD SPECIFICATIONS.
- 2. SUPERELEVATIONS ARE SHOWN ON THE PROFILE AND SUPERELEVATION SHEETS.

DESIGN DESIGNATION:

ADT (201X) = 18,000

AADT (20XX) = 22,000


= 30 MPH SR49 TO HIGGINS Rd / 35 MPH HIGGINS Rd TO PG&E SUBSTATION / 40 MPH PG&E SUBSTATION TO MAGNOLIA Rd


ABBREVIATIONS:


SR - SUPERELEVATION RATE

SW - SIDEWALK

TBC - TOP BACK OF CURB

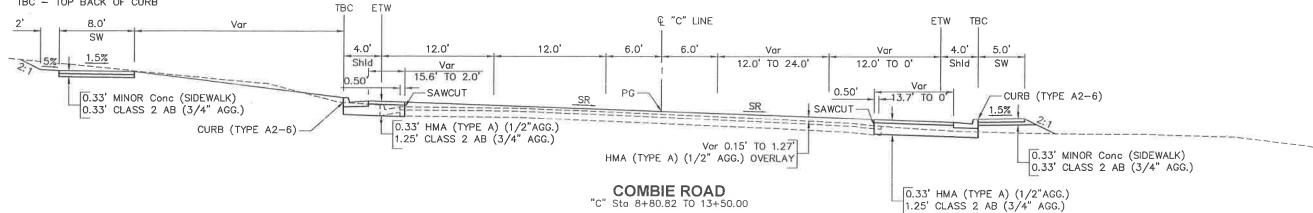

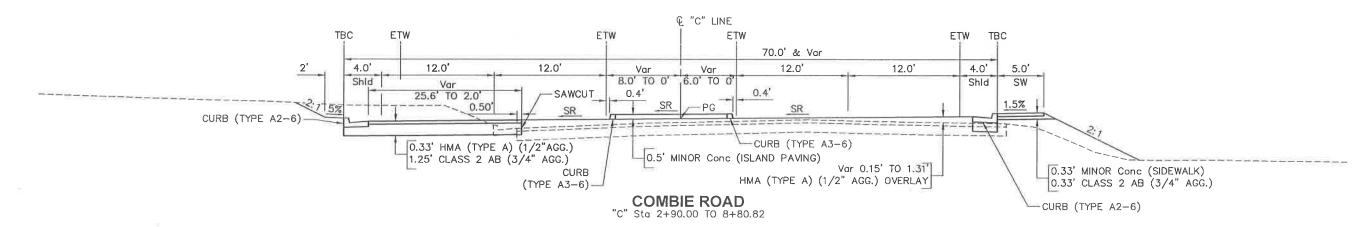

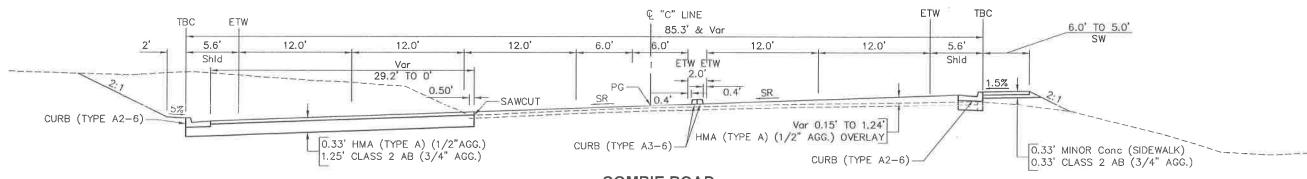

COMBIE ROAD "C" Sta 0+64.69 TO 2+90.00 REVISIONS






OF PUBLIC WORKS DESIGN/CONSTRUCTION DIVISION COUNTY NEVADA DEPARTMENT




CORRIDOR PROJECT SECTIONS COMBIE ROAD O

DRAWING:N09-300rce001.dm DESIGNED: DRAWN: HECKED: JOB NO: NO9-300 DATE: Sep 25, 2018 SHEET

COMBIE ROAD "C" Sta 16+80.91 TO 19+00.00

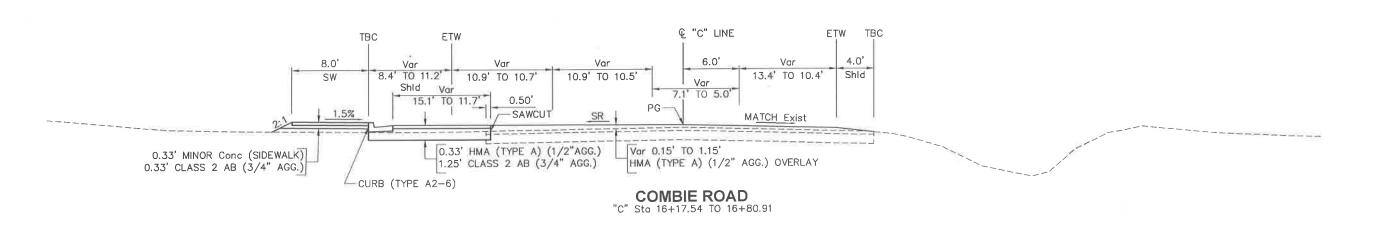

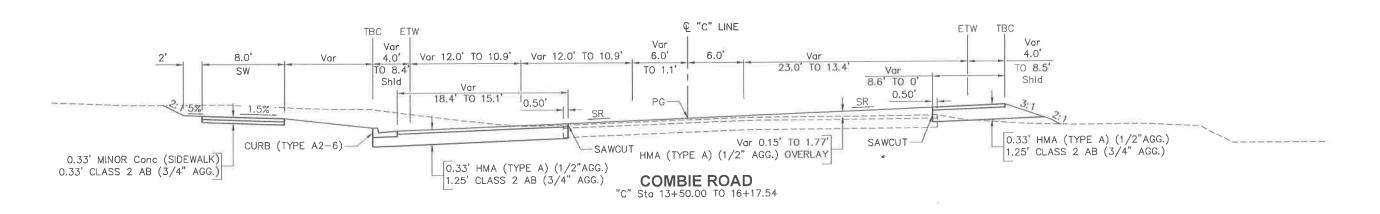

REVISIONS

COUNTY OF PUBLIC WORKS NEVADA COUNT DEPARTMENT OF PUBLIC DESIGN/CONSTRUCTION D



CORRIDOR PROJECT COMBIE ROAD (IMPROVEMENT

DRAWING:N09-300rca002.dw DESIGNED: DRAWN: CHECKED: JOB NO: NO9-300 DATE: Apr 5, 2018 SHEET 3 OF 106 SHEETS



NEVADA COUNTY
DEPARTMENT OF PUBLIC WORKS
DESIGN/CONSTRUCTION DIVISION

N ADD


COMBIE ROAD CORRIDOR IMPROVEMENT PROJECT TYPICAL CROSS SECTIONS

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|--------|-----------------|---------------------------|
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| D: | | JI |
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| AWN: | 20 | |
| SHEE | Т | |
| | 6 | 2 |
| | D: D: Apr | D: D: NO9 Apr 5, |


4 OF 106 SHEETS

NOTES:


- DIMENSIONS OF THE STRUCTURAL SECTION ARE SUBJECT TO THE TOERANCES SPECIFIED IN THE STANDARD SPECIFICATIONS.
- 2. SUPERELEVATION ARE SHOWN ON PROFILE AND SUPERELEVATION SHEETS
- 3. FOR COMPLETE R/W DATA, SEE R/W RECORD MAPS AT THE COUNTY OFFICE.

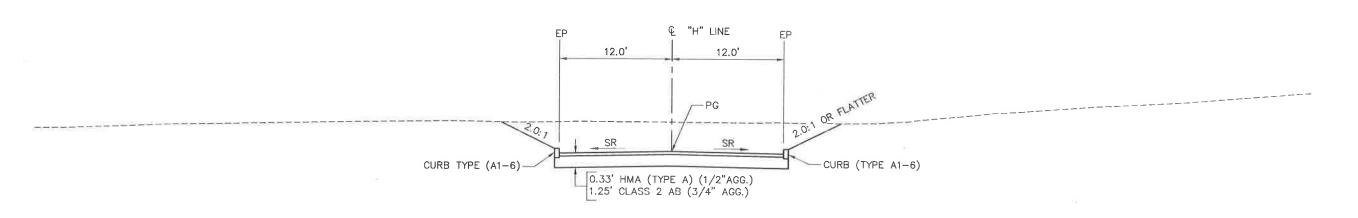


FIRESTATION ROAD "H" Sta 103+89.24 TO 104+05.00

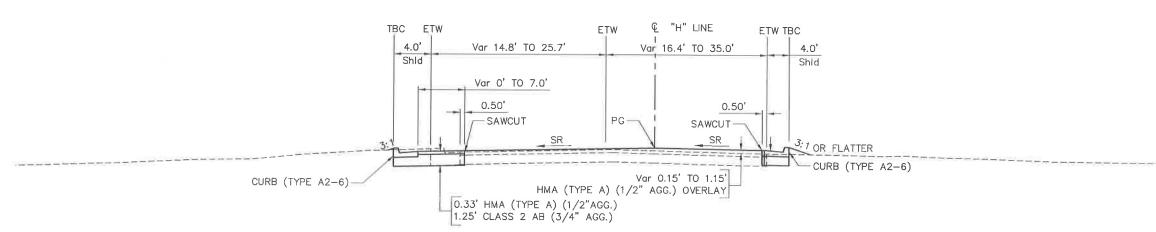

HIGGINS ROAD
"H" Sta 102+00.00 TO 102+94.39

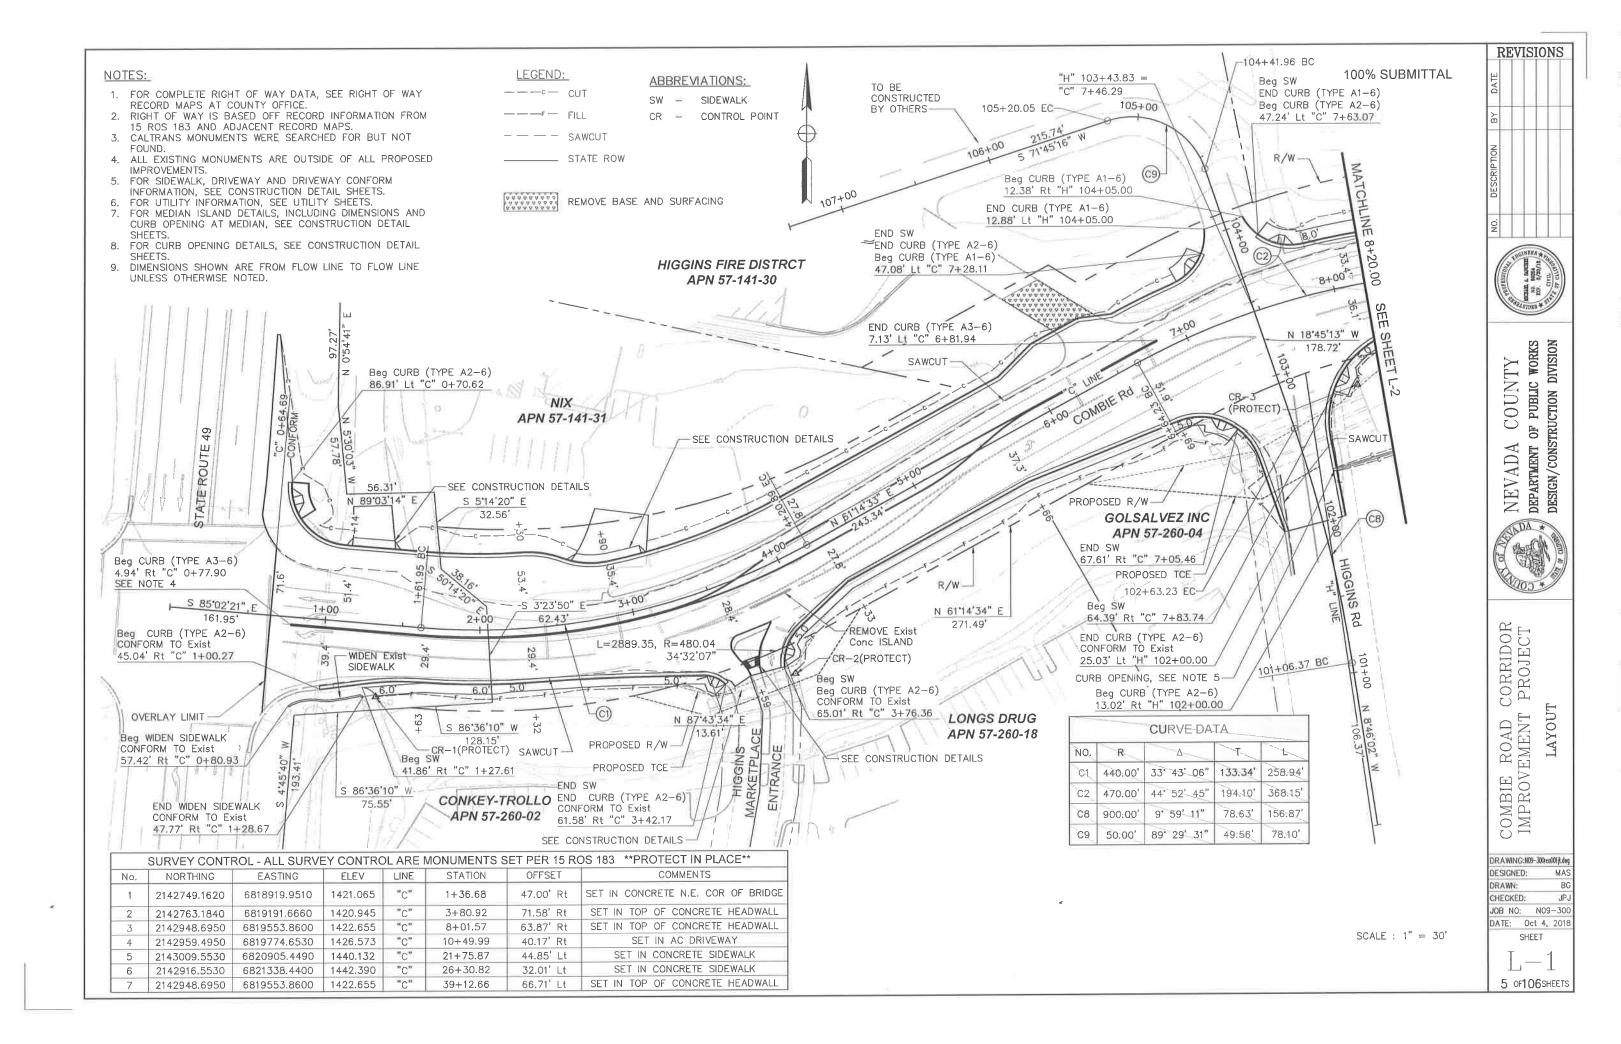

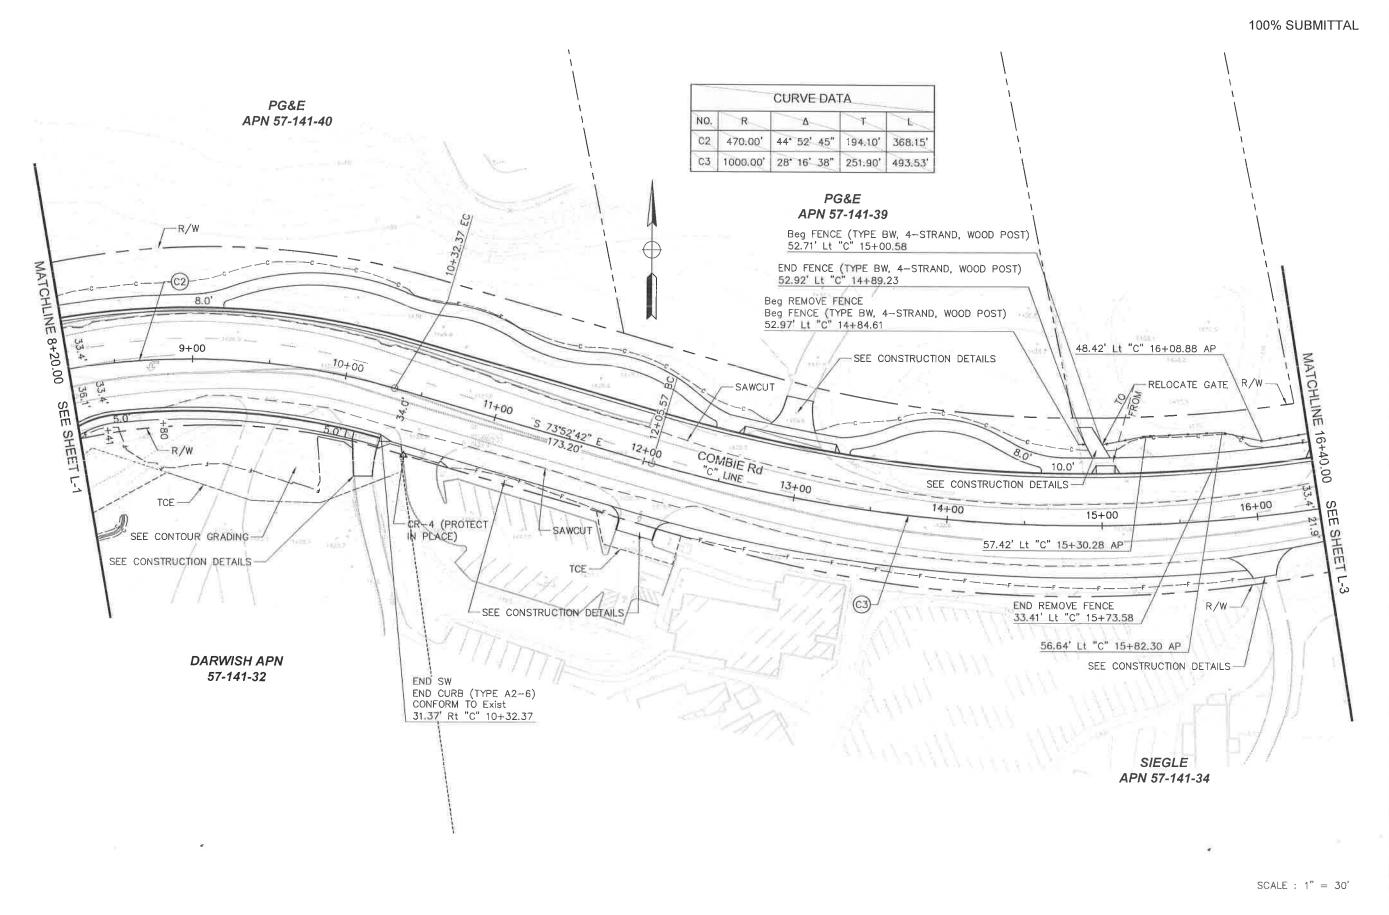





NEVADA COUNTY DEPARTMENT OF PUBLIC WORKS DESIGN/CONSTRUCTION DIVISION




COMBIE ROAD CORRIDOR IMPROVEMENT PROJECT

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NO. DESCRIPTION BY DATE
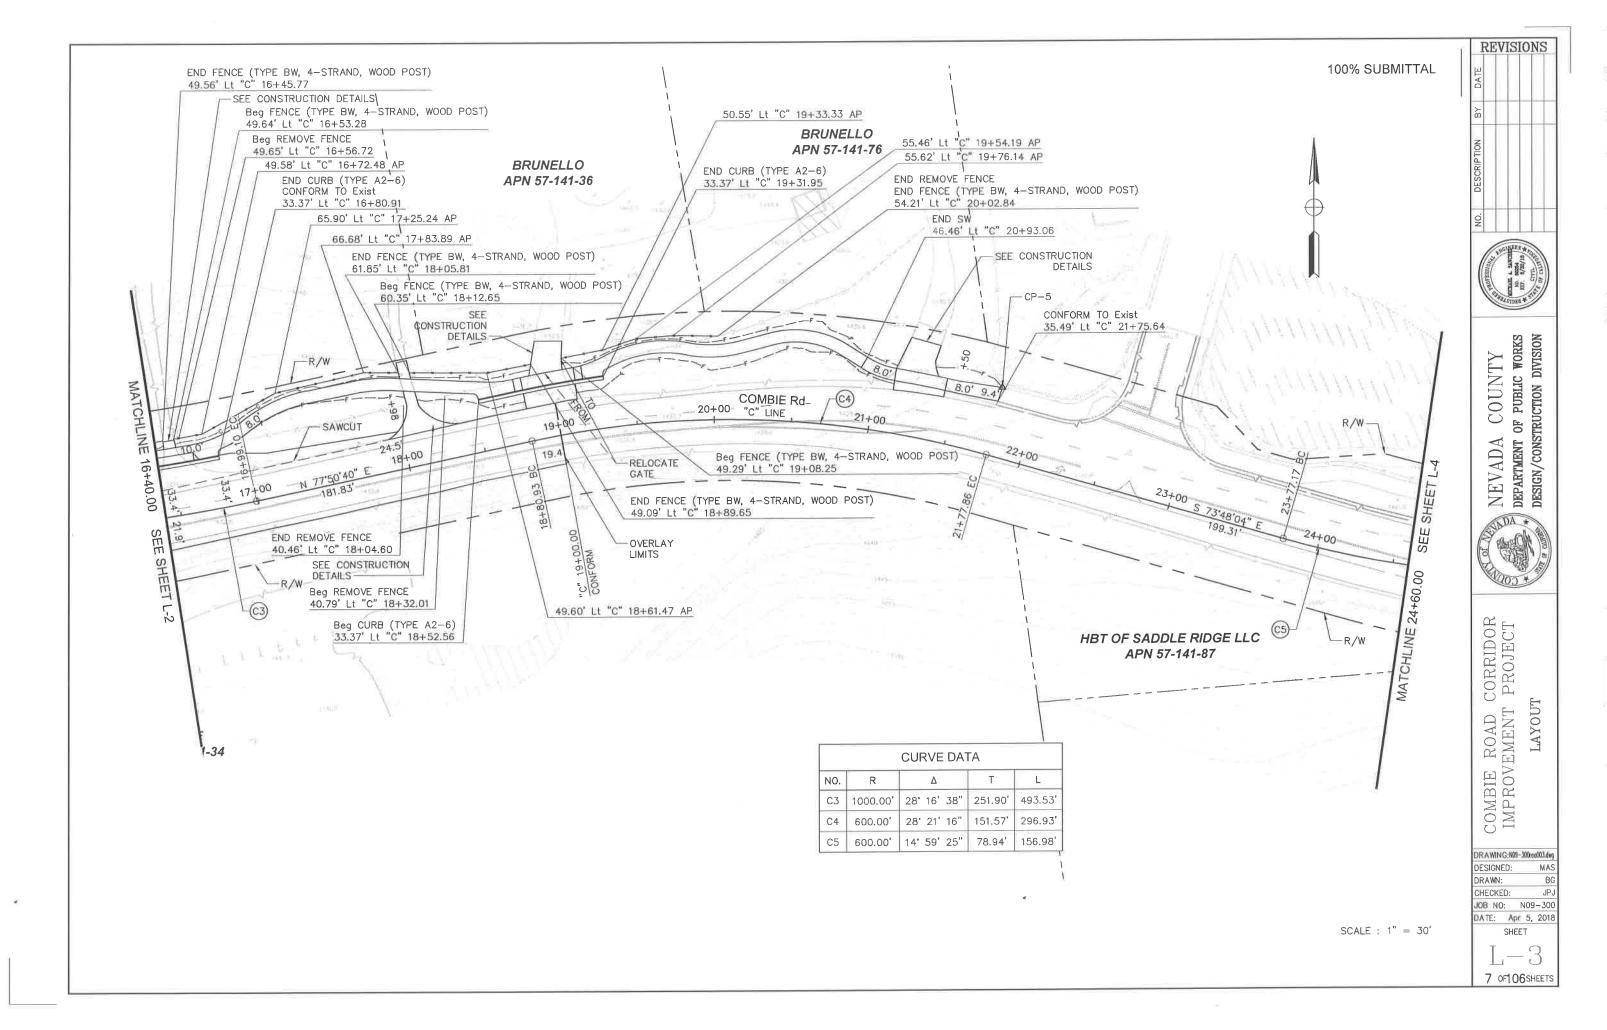
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NEVADA COUNTY
DEPARTMENT OF PUBLIC WORKS
DESIGN/CONSTRUCTION DIVISION

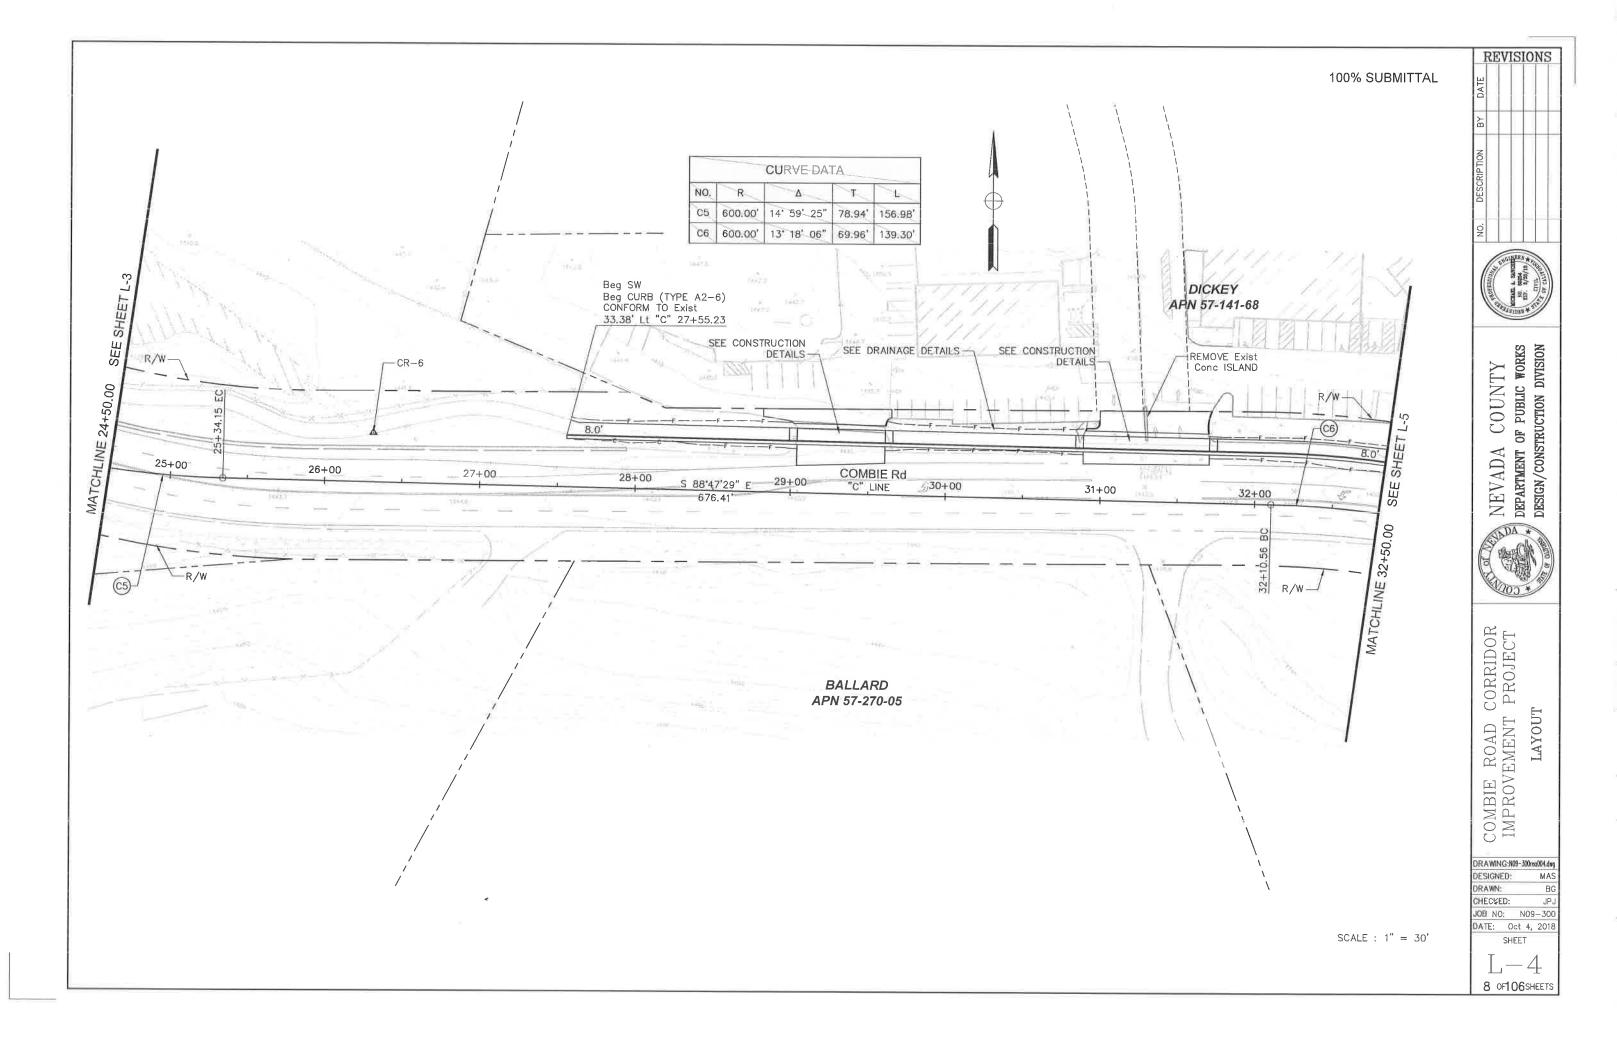
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COMBIE ROAD CORRIDOR IMPROVEMENT PROJECT LAYOUT
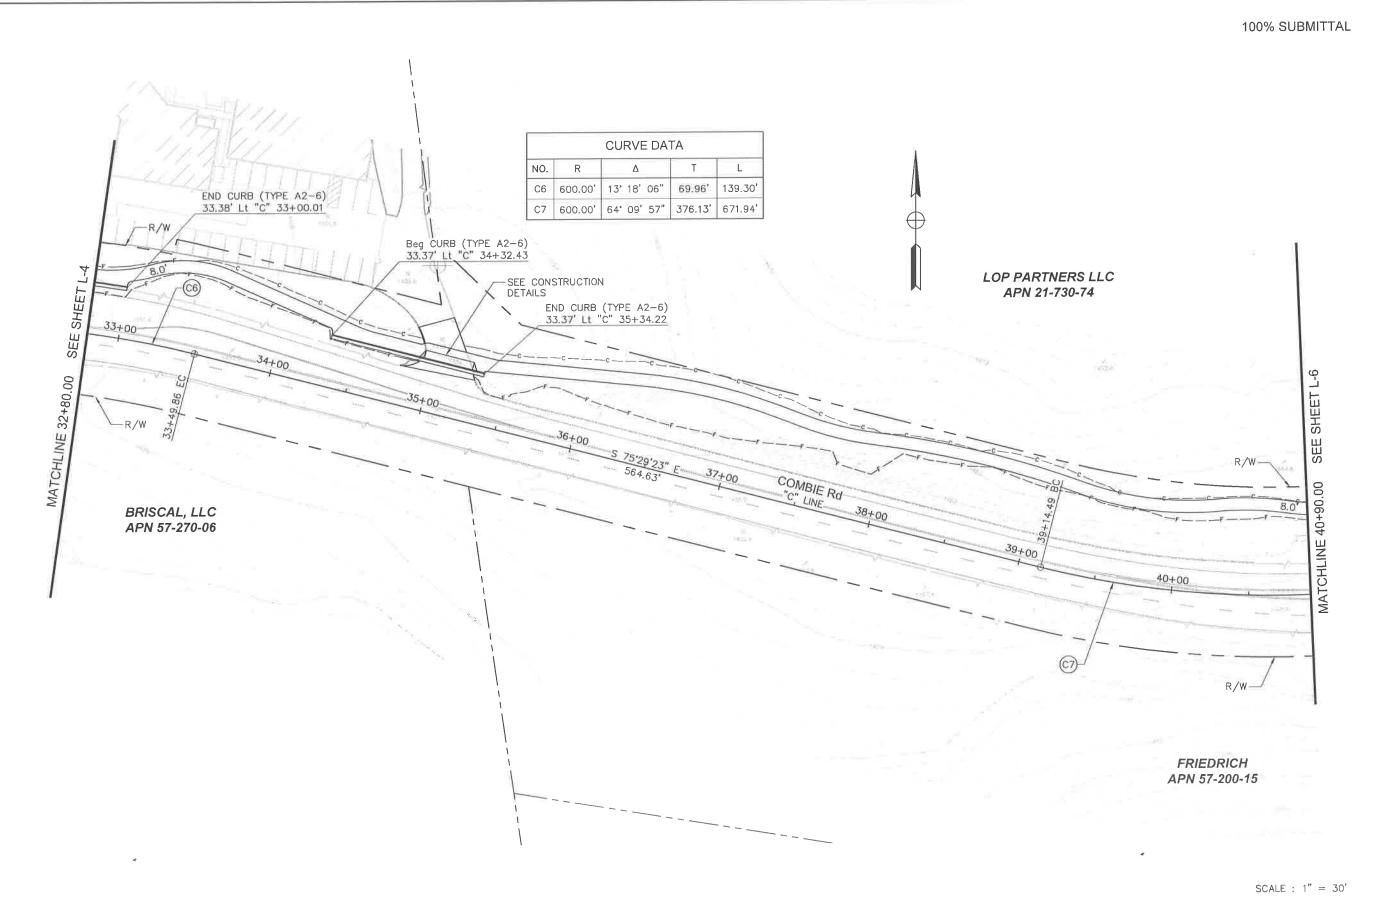
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DESIGNED: MAS
DRAWN: BG
CHECKED: JPJ

CHECKED: JPJ JOB NO: NO9-300 DATE: Apr 5, 2018 SHEET


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9 OF106SHEETS




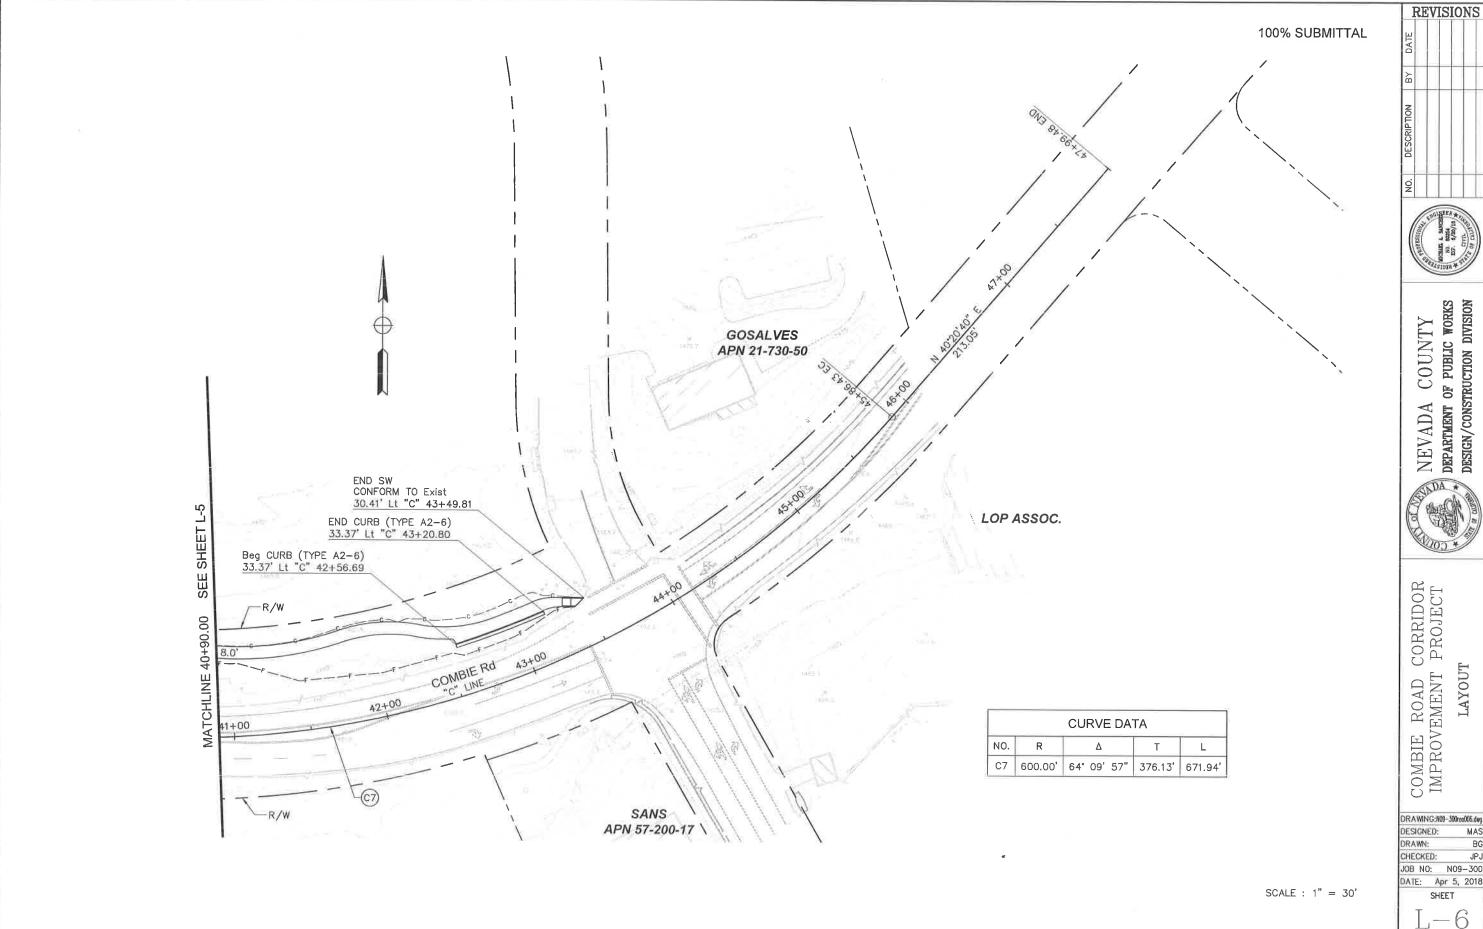






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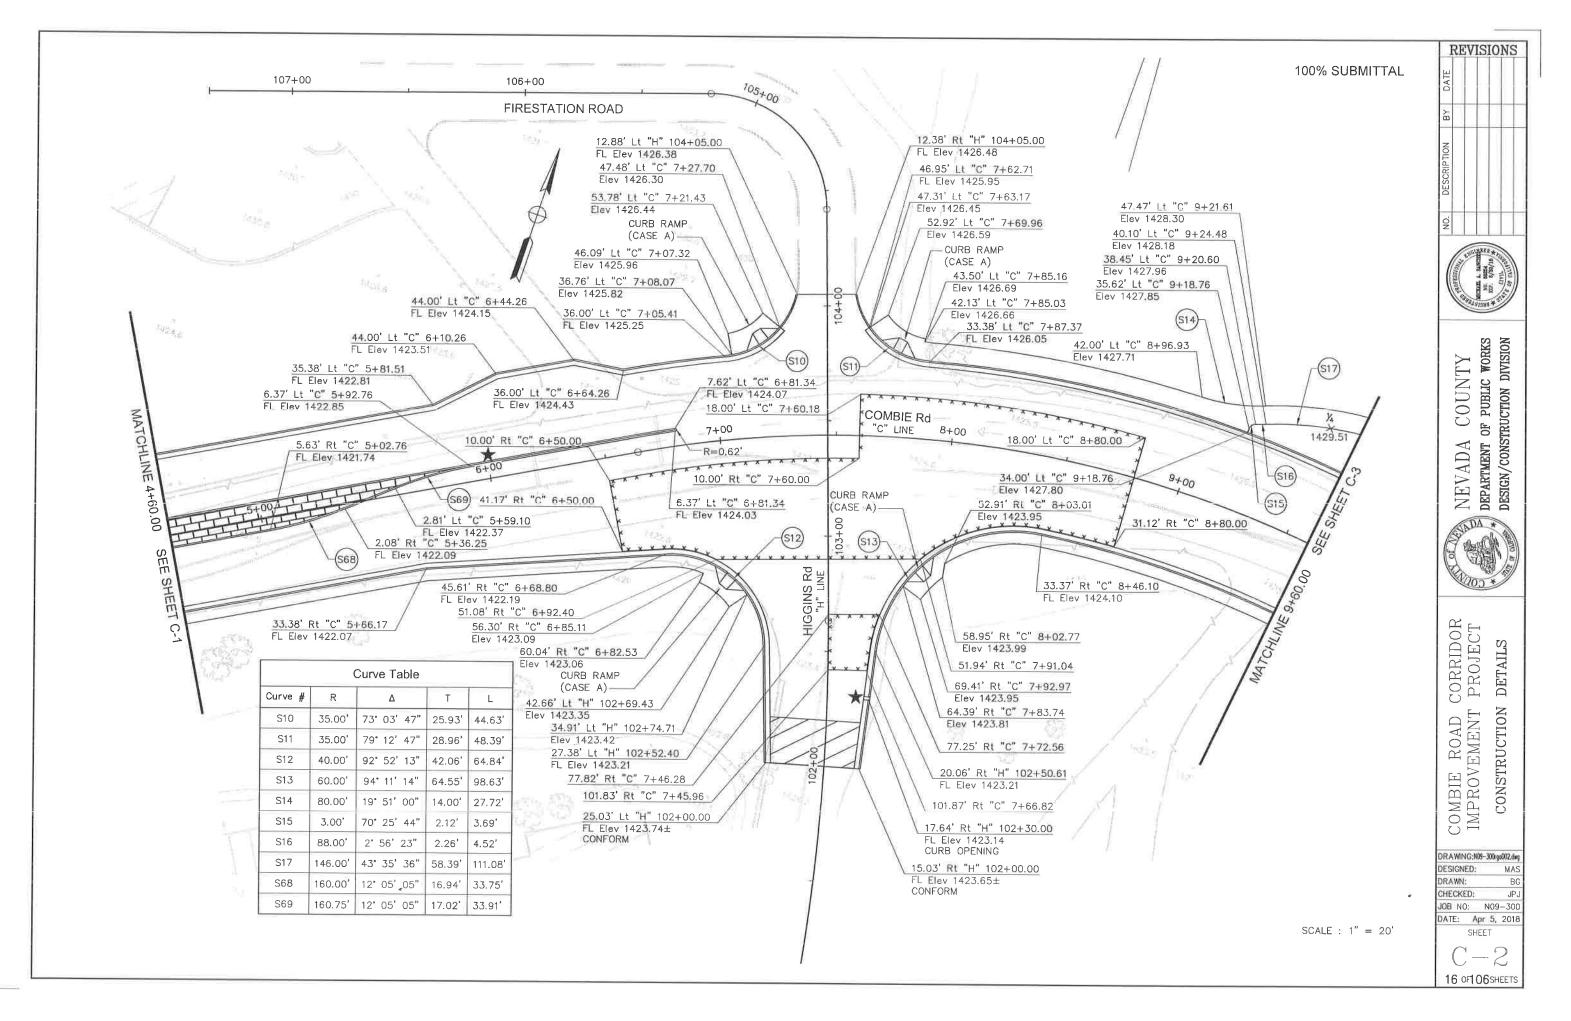


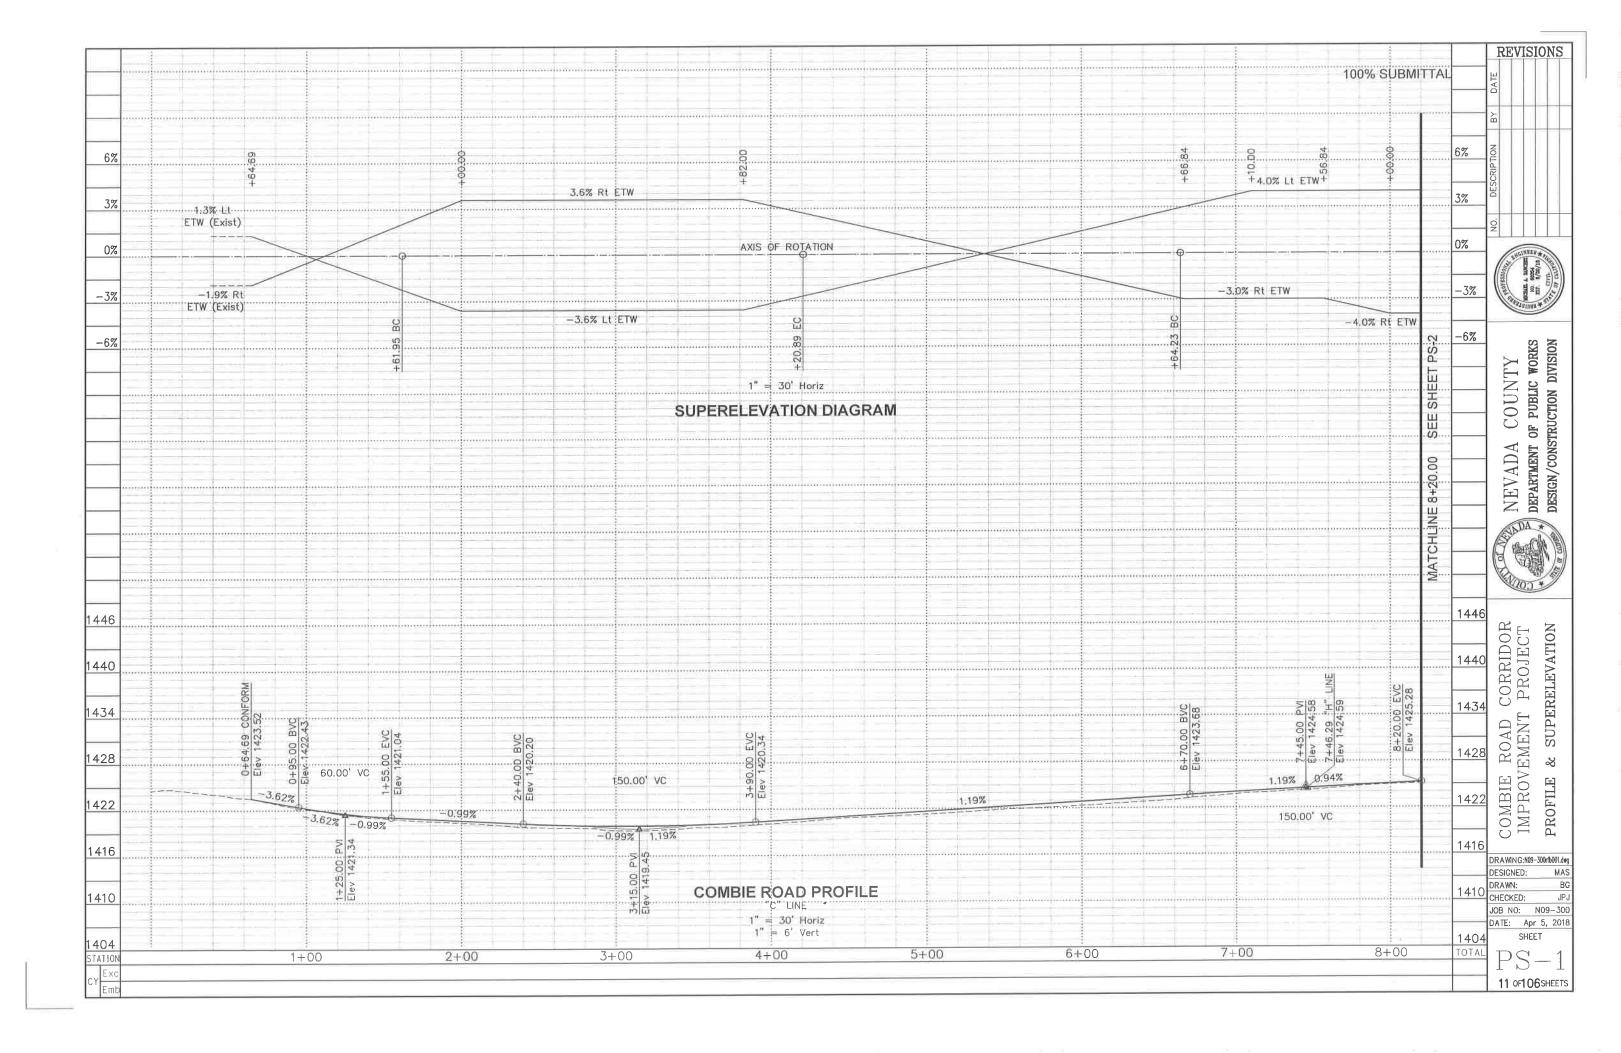


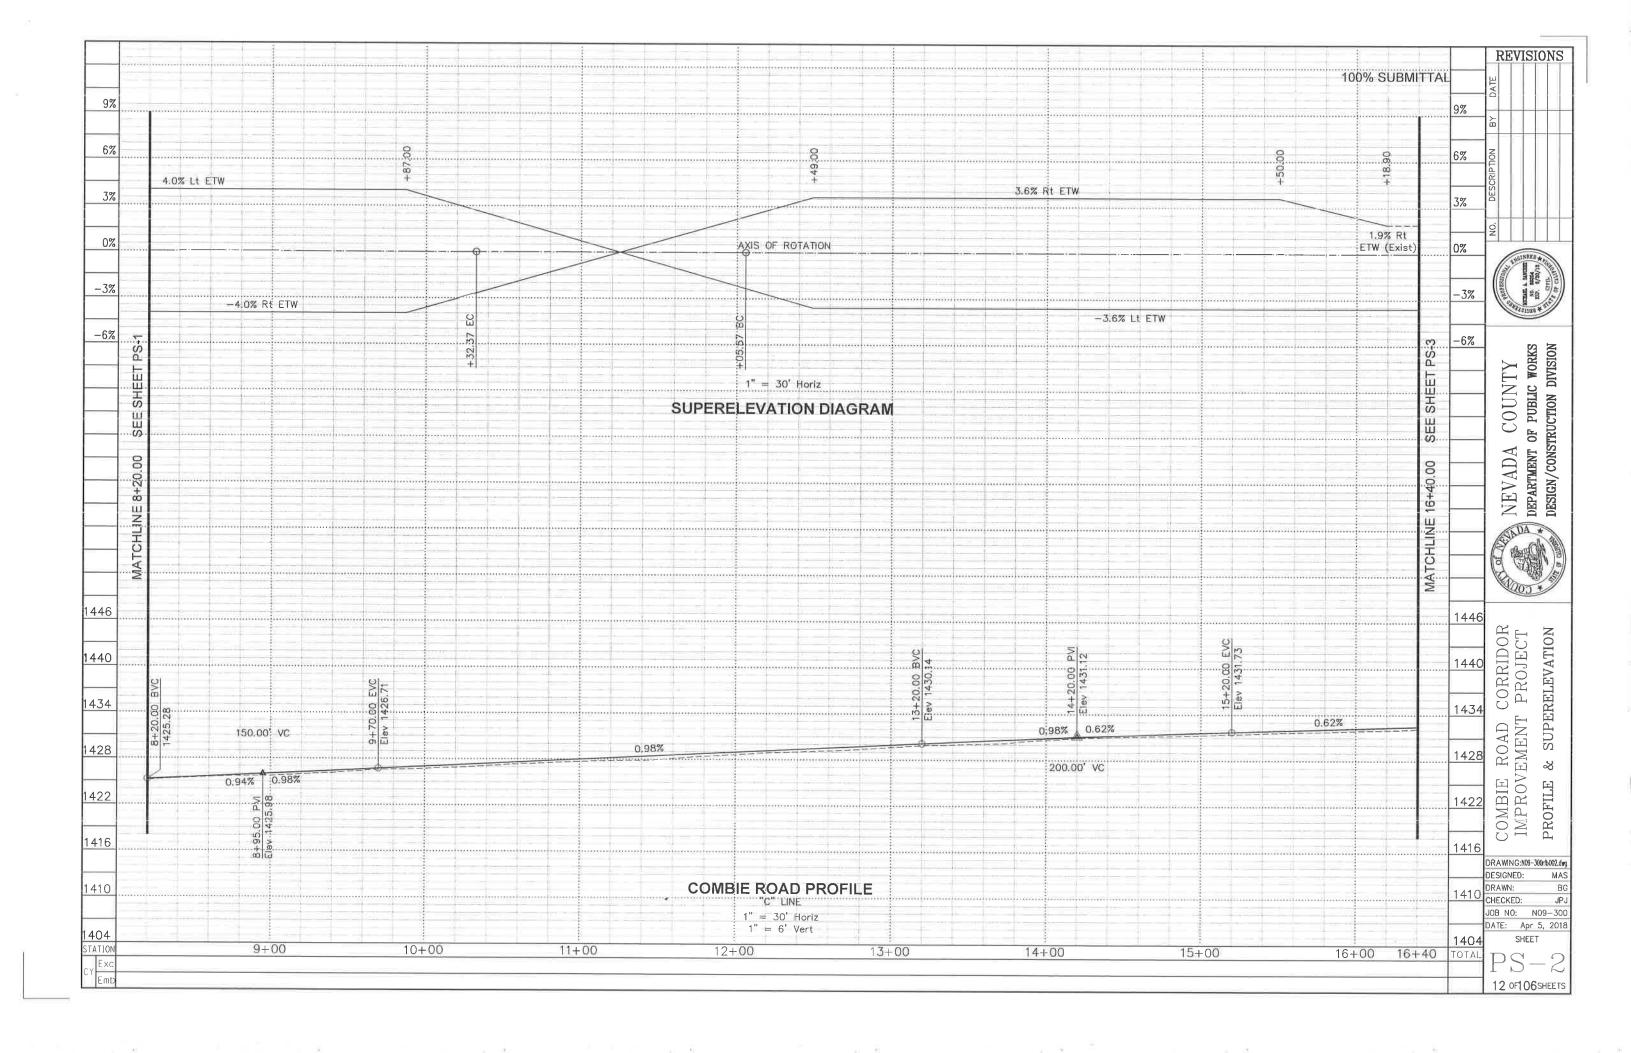

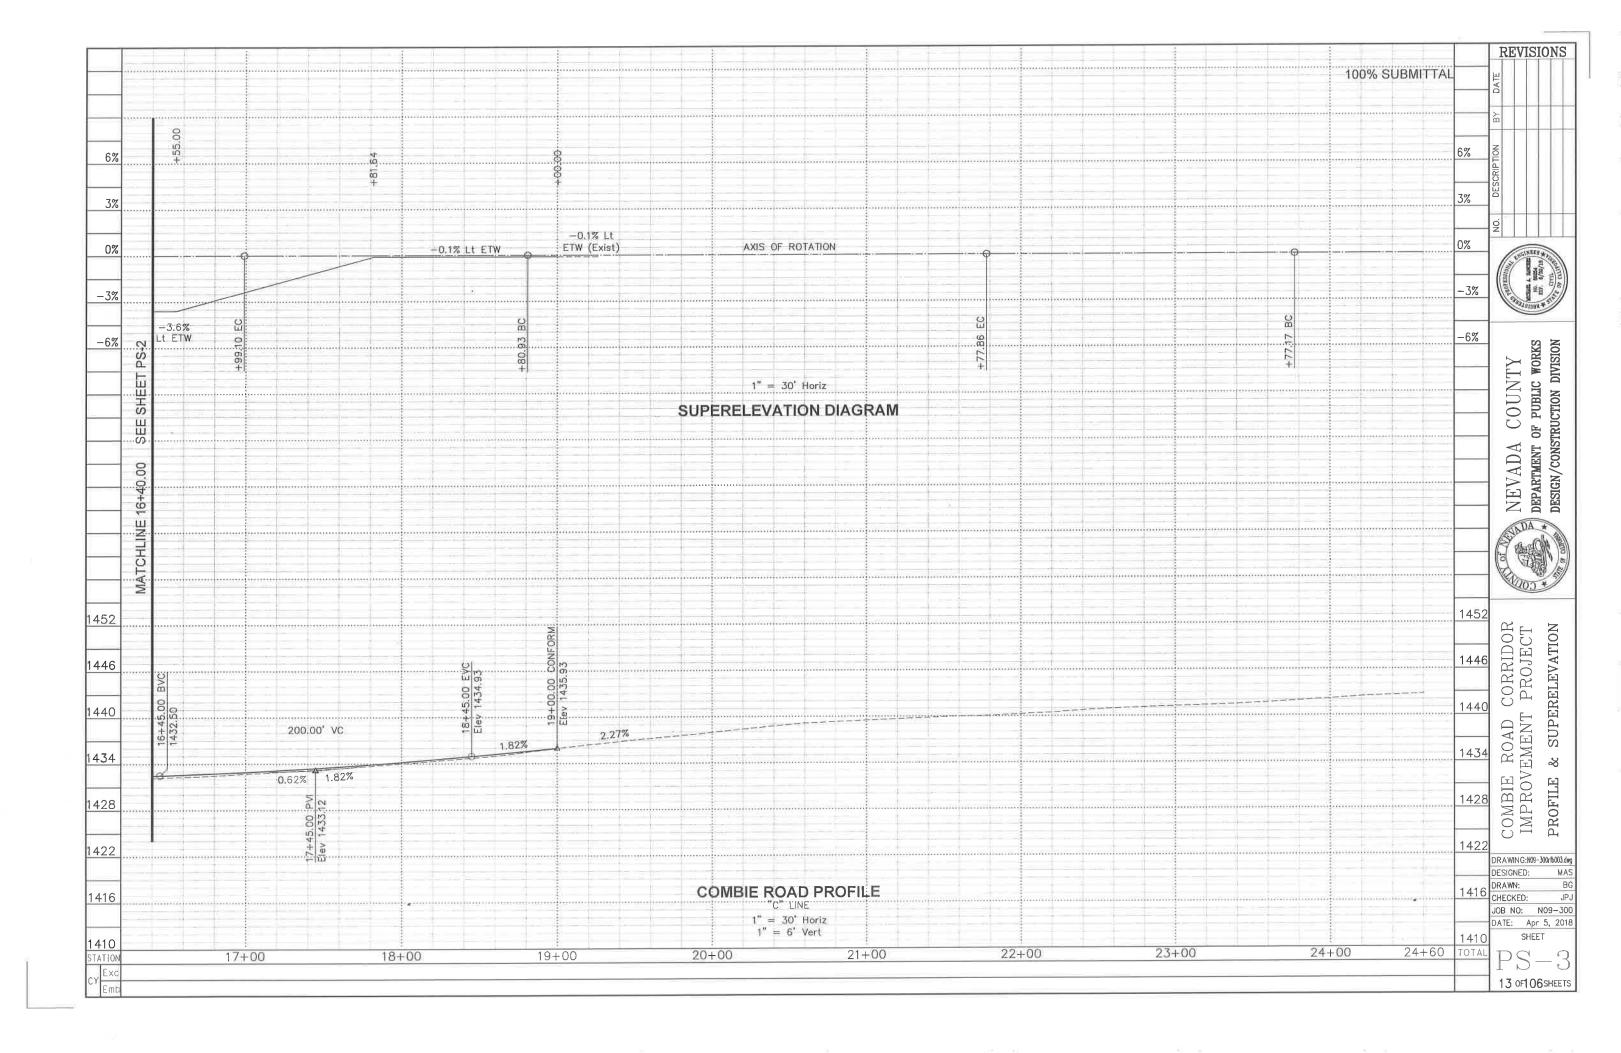

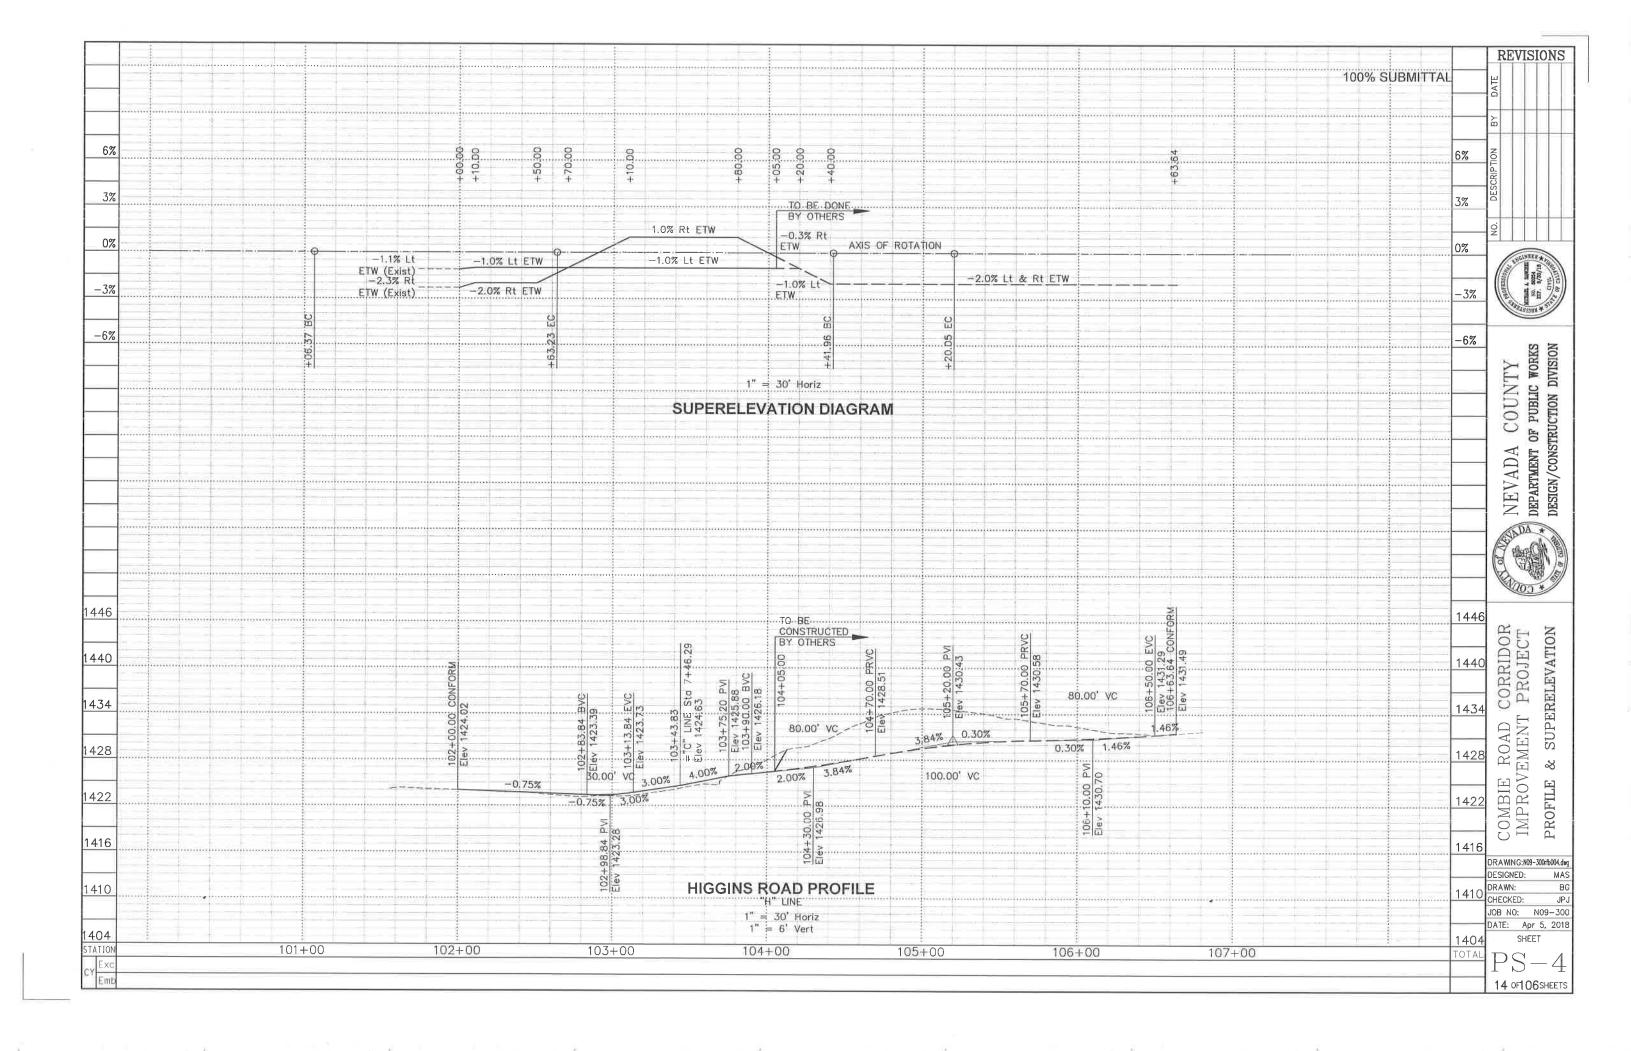

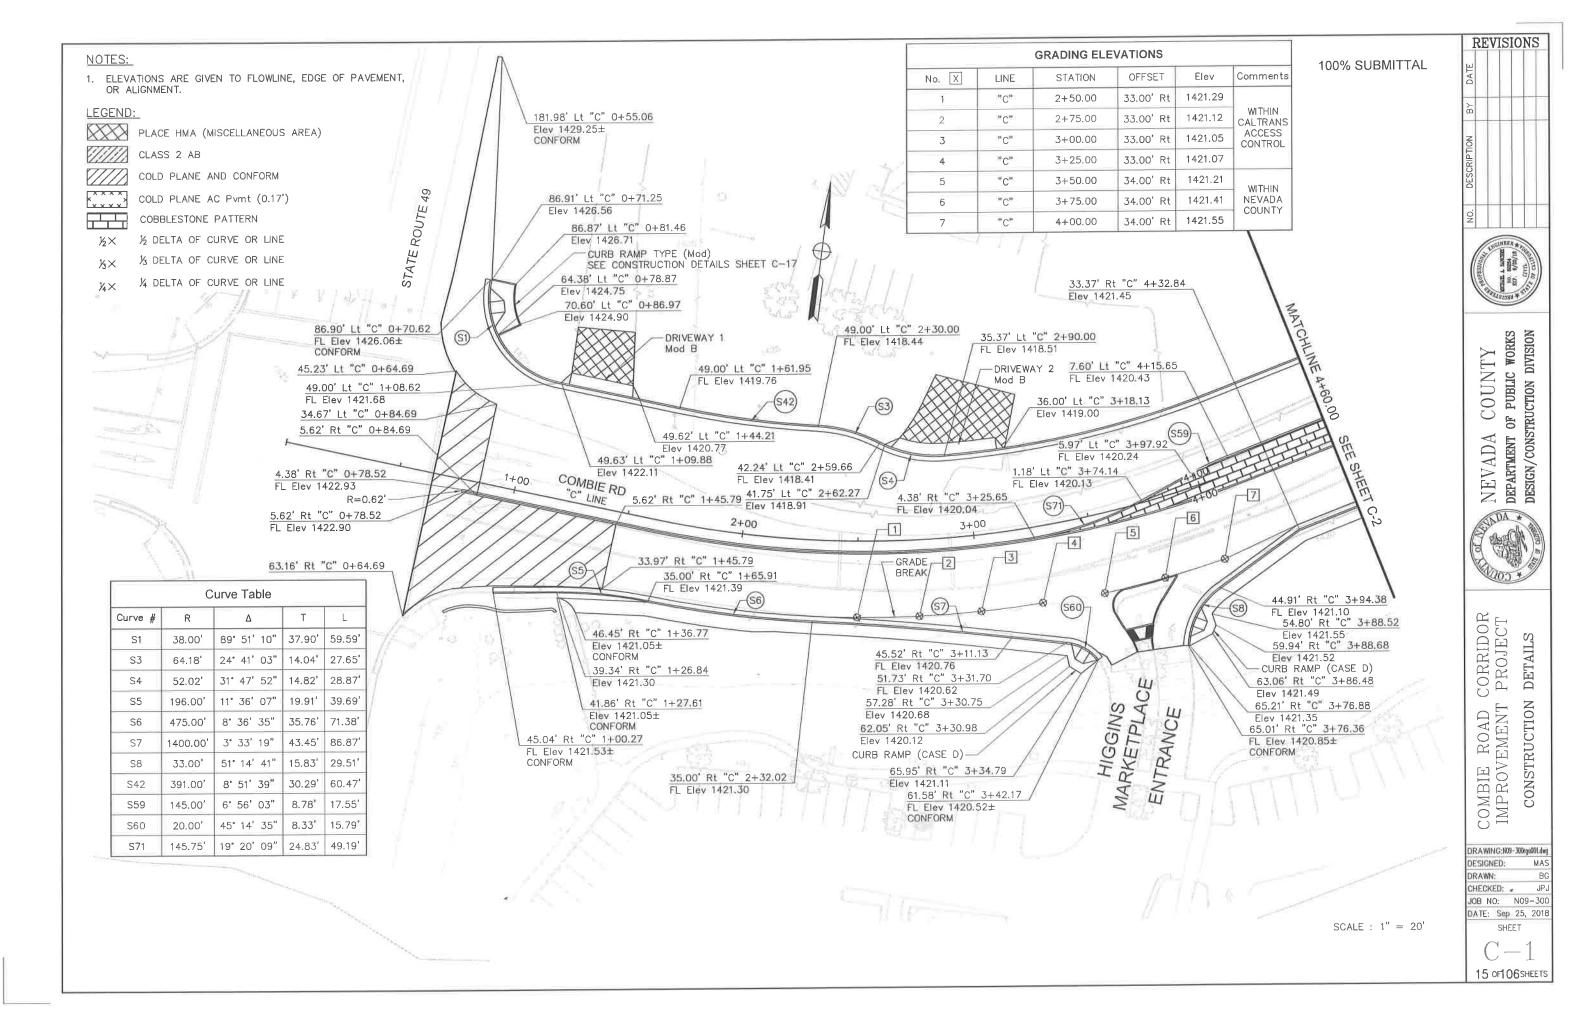

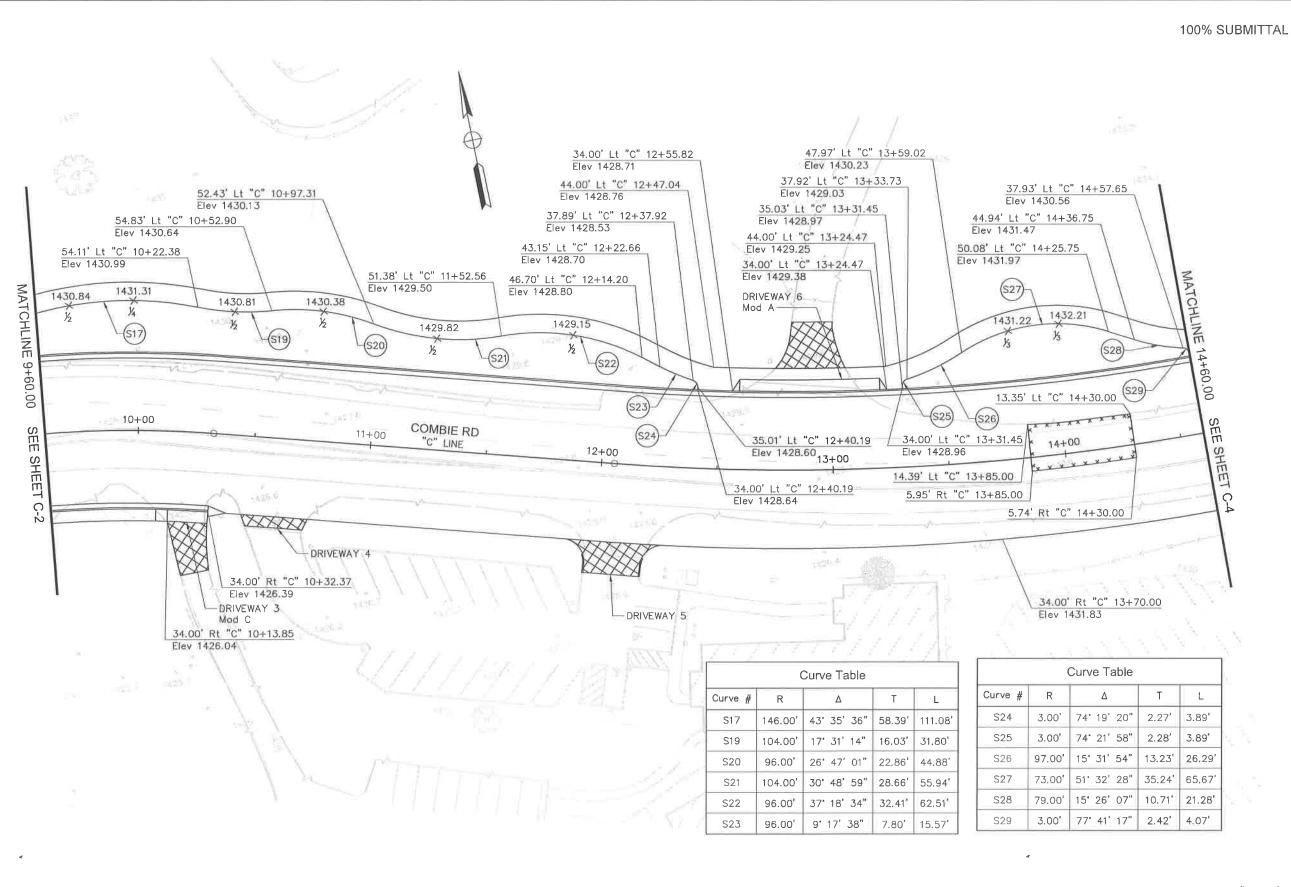

SCALE : 1" = 20'

NO. DESCRIPTION BY DATE






NEVADA COUNTY
DEPARTMENT OF PUBLIC WORKS
DESIGN/CONSTRUCTION DIVISION




COMBIE ROAD CORRIDOR IMPROVEMENT PROJECT


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DATE: Apr 5, 2018
SHEET

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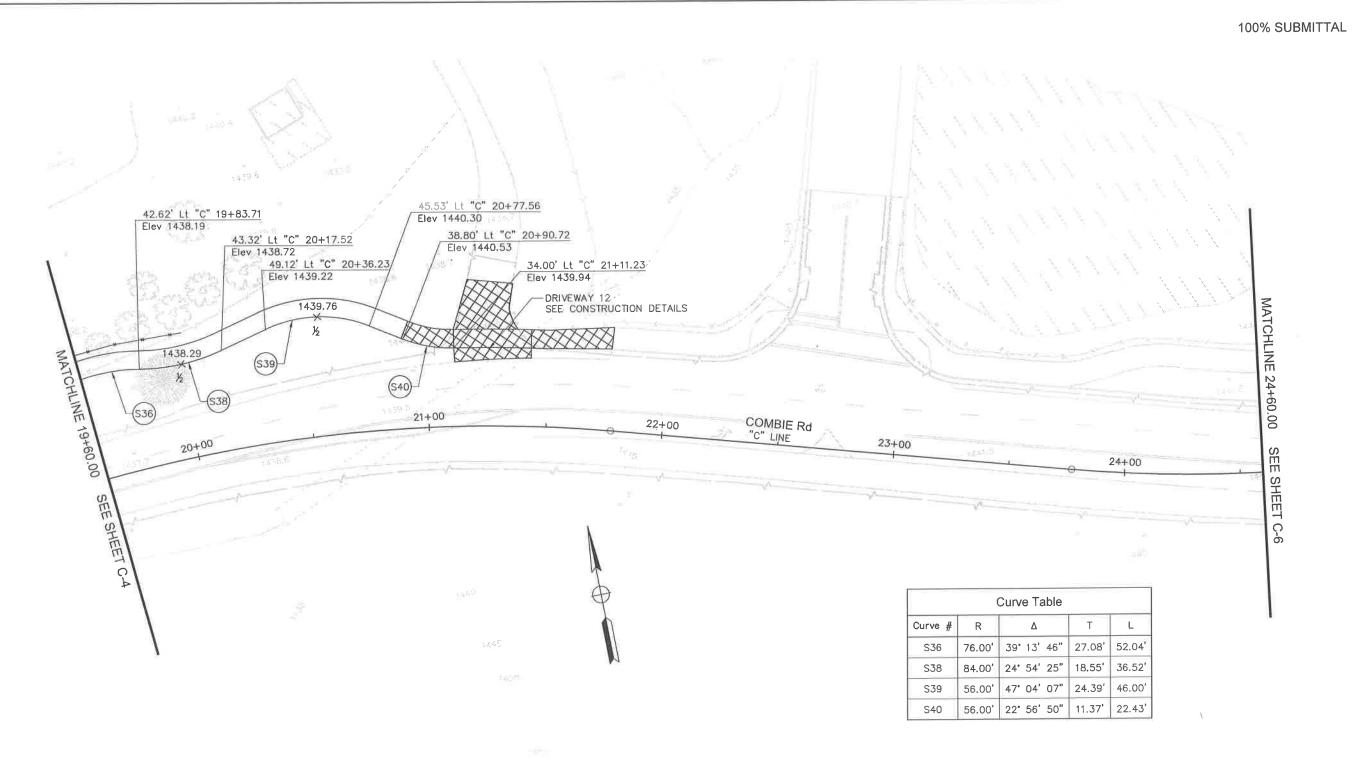


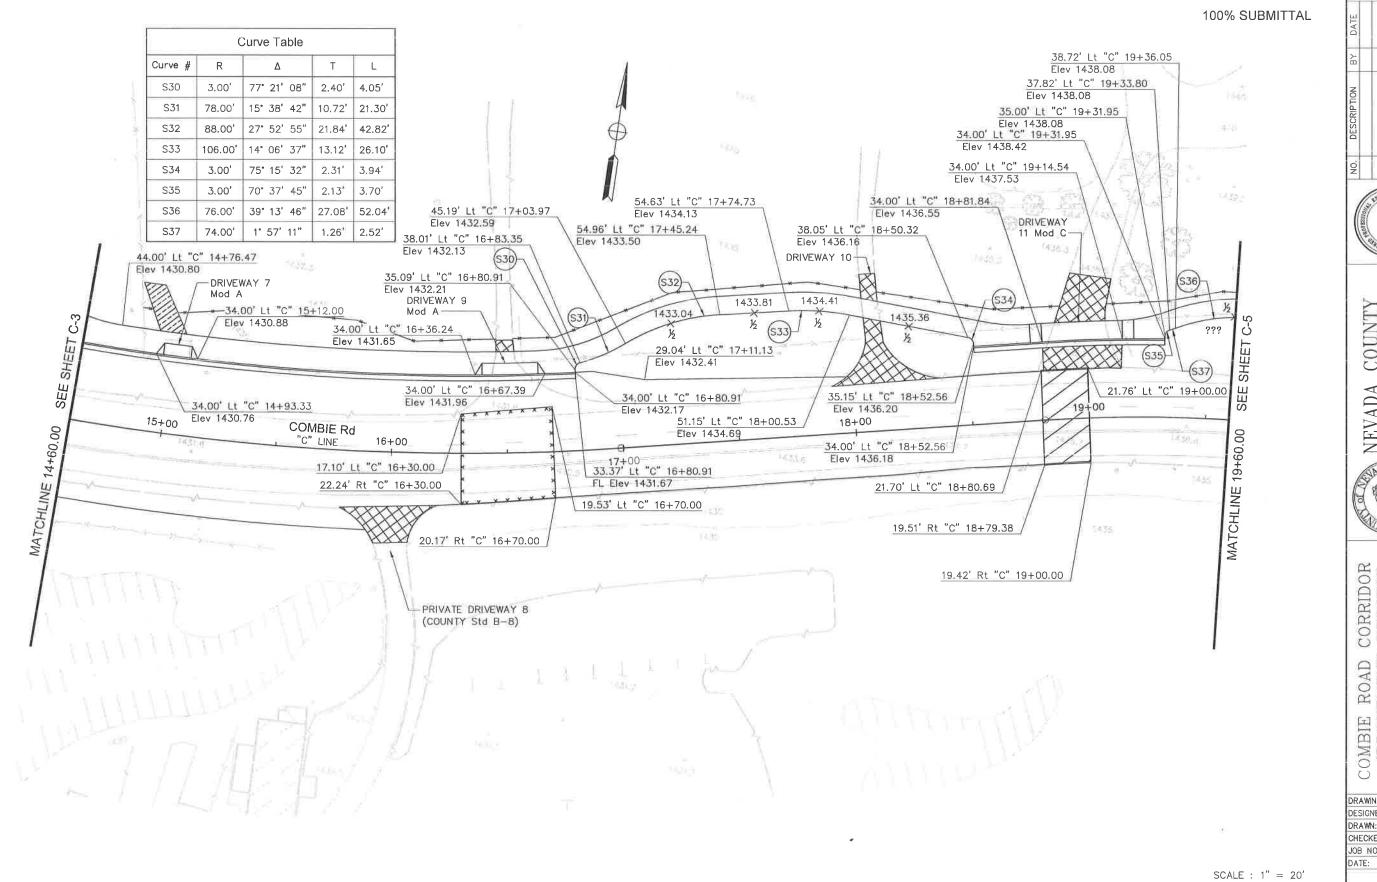

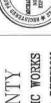

CORRIDOR PROJECT COMBIE ROAD IMPROVEMENT
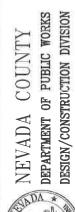
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NEVADA COUNTY

DEPARTMENT OF PUBLIC WORKS

DESIGN/CONSTRUCTION DIVISION


REVISIONS

COMBIE ROAD CORRIDOR IMPROVEMENT PROJECT CONSTRUCTION DETAILS

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DESIGNED: MAS
DRAWN: BG
CHECKED: JPJ
JOB NO: N09-300
DATE: Apr 5, 2018
SHEET

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19 OF 106 SHEETS

SCALE : 1" = 20'

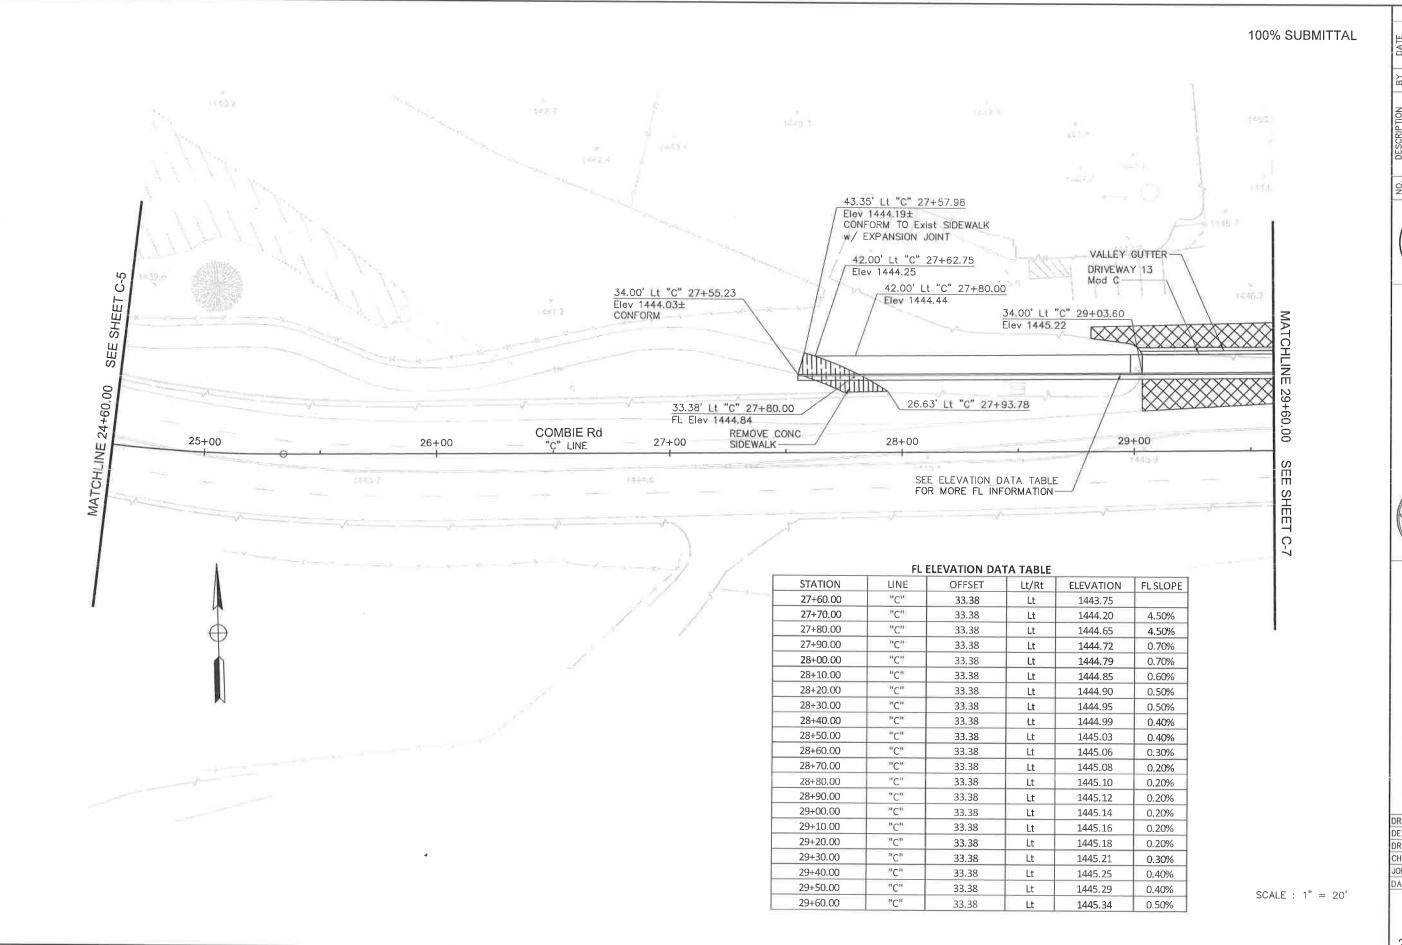





NEVADA COUNTY DEPARTMENT OF PUBLIC WORKS DESIGN/CONSTRUCTION DIVISION ADA *

CORRIDOR DETAILS COMBIE ROAD CIMPROVEMENT CONSTRUCTION

DRAWING:N09-300rga006.dwg DESIGNED: DRAWN: CHECKED: -JOB NO: NO9-300 DATE: Apr 5, 2018 SHEET



Lt

Lt

0.80%

1453.89

33.38

33.38

"C"

34+50.00

34+60.00

SCALE : 1'' = 20'

COUNTY OF PUBLIC WORKS DIVISION NEVADA COUN'
DEPARTMENT OF PUBLIC
DESIGN/CONSTRUCTION D


REVISIONS

WADA *

CORRIDOR DETAILS 'EMENT CONSTRUCTION ROAD

COMBIE IMPROVI DRAWING:N09-300rga007.dwg DESIGNED:

MAS DRAWN: CHECKED: JPJ JOB NO: NO9-300 DATE: Apr 5, 2018 SHEET

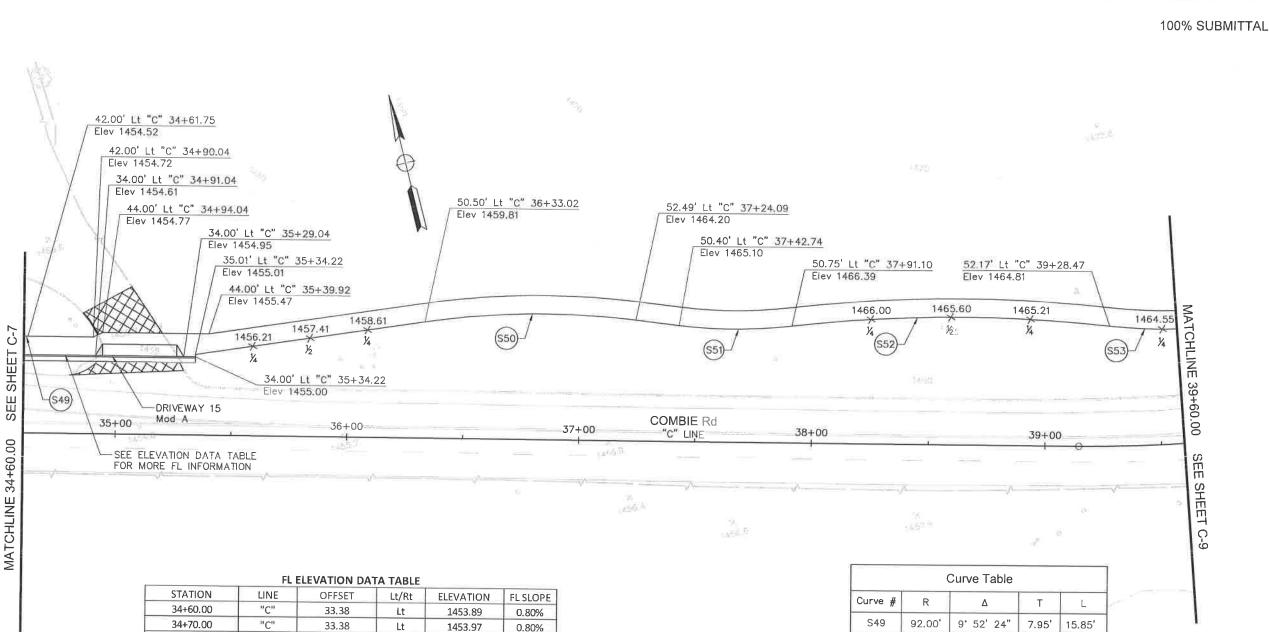

34+80.00

34+90.00

35+00.00

35+10.00

35+20.00

35+30.00

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"C"

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Lt

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1454.04

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1454.22

1454.27

1454.39

0.70%

0.60%

0.60%

0.60%

0.50%

1.20%

| Curve Table | | | | | |
|-------------|---------|-------------|--------|---------|--|
| Curve # | R | Δ | Т | L | |
| S49 | 92.00' | 9' 52' 24" | 7.95' | 15.85' | |
| S50 | 342.00' | 15' 18' 20" | 45.95' | 91.36' | |
| S51 | 204.00' | 13' 36' 51" | 24.35' | 48.47' | |
| S52 | 596.00' | 13' 07' 06" | 68.53' | 136.46' | |
| S53 | 204.00' | 25' 19' 57" | 45.85 | 90.20' | |


COMBIE ROAD CORRIDOR IMPROVEMENT PROJECT

REVISIONS

NEVADA COUNTY DEPARTMENT OF PUBLIC WORKS DESIGN/CONSTRUCTION DIVISION

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DRAWN: BG
CHECKED: JPJ
JOB NO: N09-300
DATE: Apr 5, 2018
SHEET

C — 8
22 OF 106 SHEETS

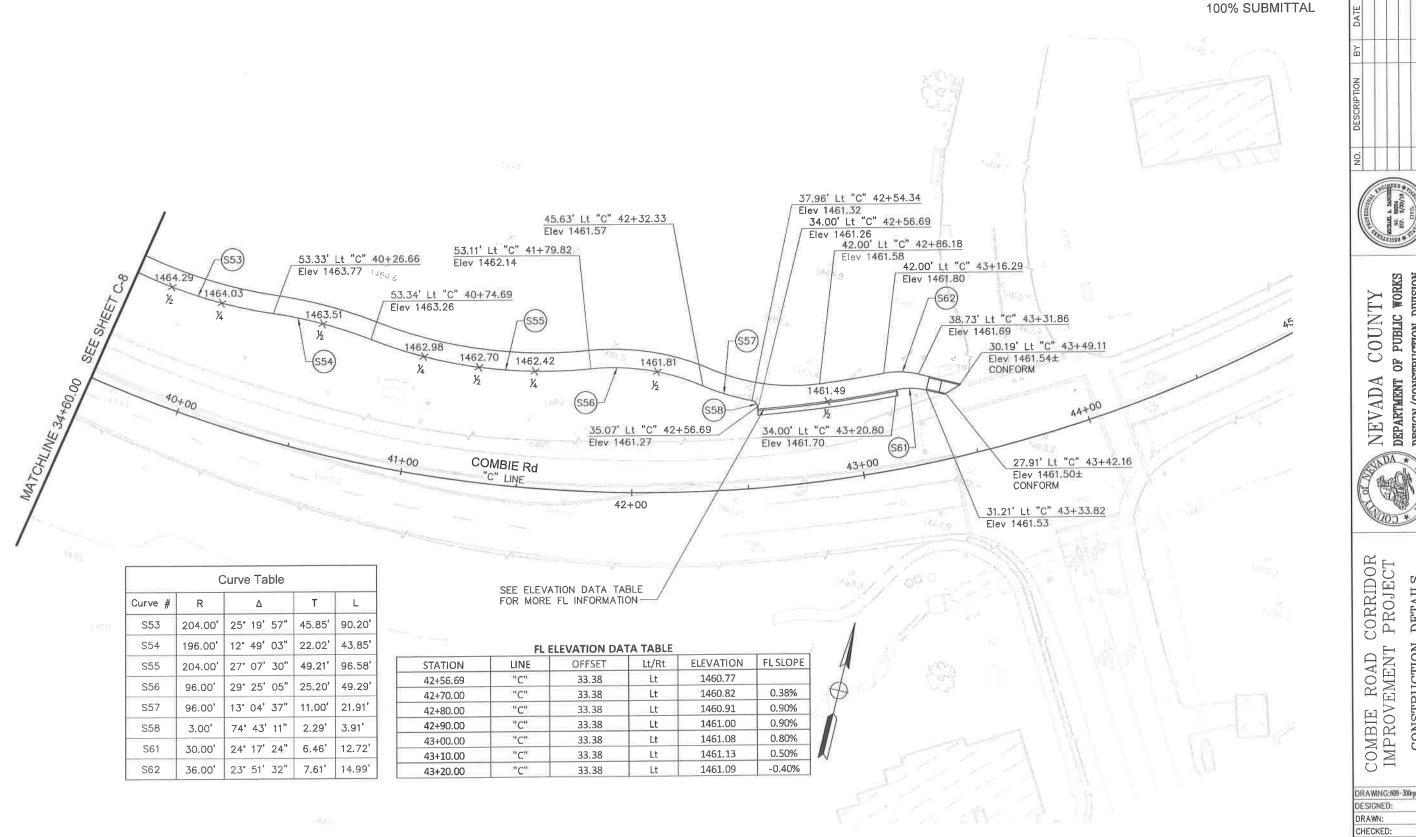

SCALE: 1" = 20'


CORRIDOR PROJECT DETAILS CONSTRUCTION COMBIE ROAD IMPROVEMENT

REVISIONS

NEVADA COUNTY DEPARTMENT OF PUBLIC WORKS DESIGN/CONSTRUCTION DIVISION

DRAWING: N09-300rgo009.dwg DESIGNED: MAS BG DRAWN: CHECKED: JPJ JOB NO: N09-300 DATE: Apr 5, 2018 SHEET

> -9 23 OF 106 SHEETS

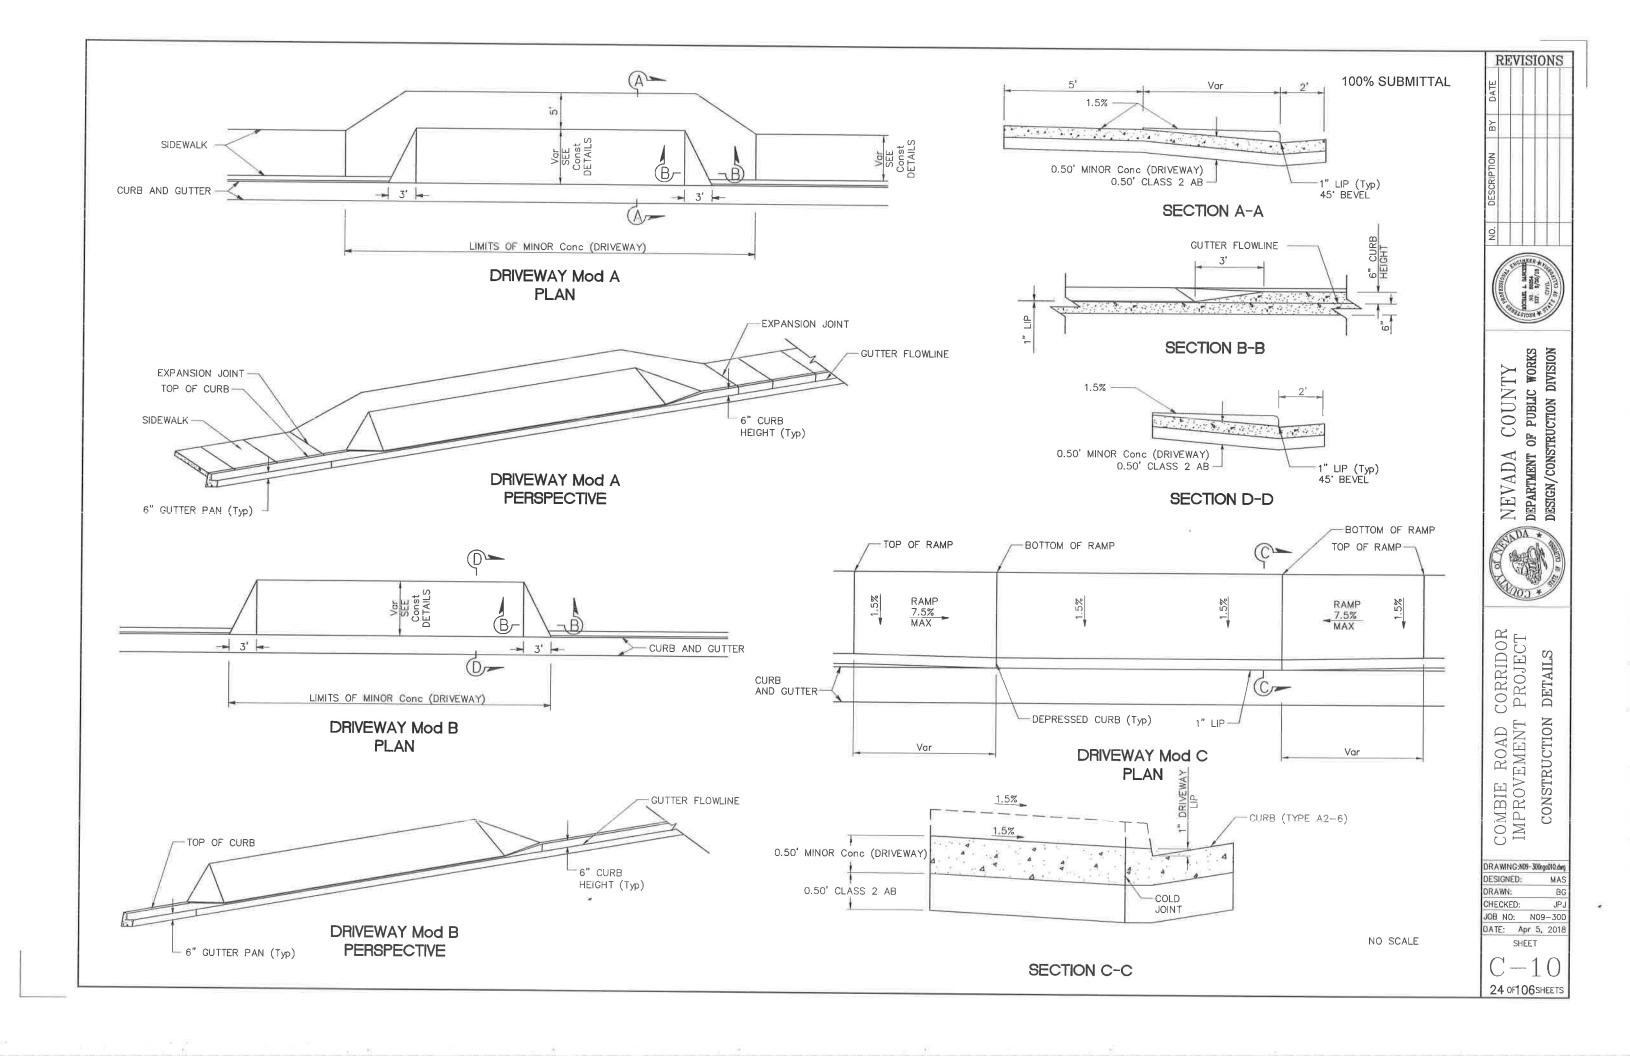

NOTES:

- 1. FOR ADDITIONAL CURB DETAILS SEE STANDARD PLAN A87A.
- SIDEWALKS SHALL BE SCORED AT FIVE-FOOT INTERVALS.
- IN LIEU OF EVERY OTHER SCORE MARK, AT TEN-FOOT INTERVALS, WEAKENED PLANE JOINTS SHALL BE CONSTRUCTED.
- IN LIEU OF EVERY THIRD WEAKENED PLANE JOINT, AT THIRTY—FOOT INTERVALS, EXPANSION JOINTS SHALL BE CONSTRUCTED AS SHOWN.
- ALLOWABLE GRADE AND DIMENSION TOLERANCES FOR CONSTRUCTION OF PEDESTRIAN FACILITIES DOES NOT RELIEVE THE CONTRACTOR FROM THE RESPONSIBILITY OF MEETING THE REQUIREMENTS OF THE AMERICANS WITH DISABILITIES ACT.


LEGEND:

SCORE MARK


WEAKENED PLANE JOINT


EXPANSION JOINT

COLD PLANE Exist HMA

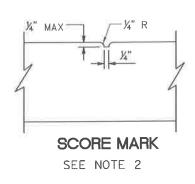


CONFORM or LIP OF Exist Gutter

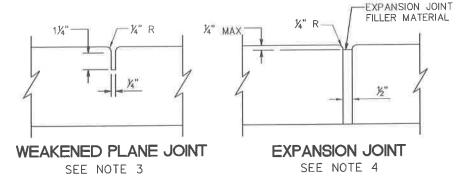

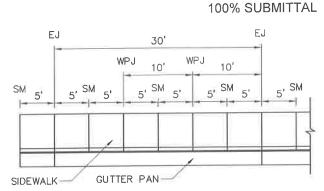


SCORE MARK, WEAKENED PLANE JOINT, AND EXPANSION JOINT PATTERN

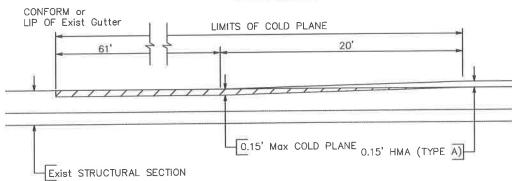


COLD PLANE AND CONFORM DETAIL

Sta "C" 0+64.69 TO 0+84.69 Lt

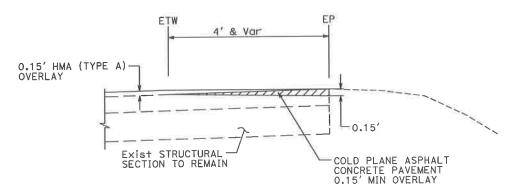


WEDGE GRIND DETAIL


ISLAND LOCATION Sta "C" 16+18.77 TO 19+00.00

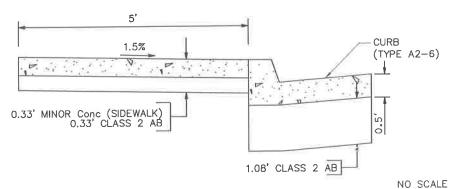

CURB AND GUTTER AND SIDEWALK

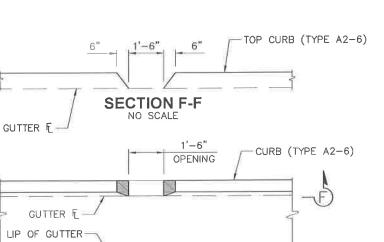

PLAN **CURB OPENING DETAIL** NO SCALE Sta "H" 102+30.00

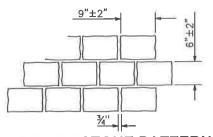

20' Typ LIMITS OF COLD PLANE

0.15' Max COLD PLANE 0.15' HMA (TYPE A)

Exist STRUCTURAL SECTION


COLD PLANE AND CONFORM DETAIL Sta "C" 0+64.69 TO 1+45.79 Rt

Sta "H" 102+00.00 TO 102+20.00


Sta "C" 18+79.38 TO 19+00.00

COBBLESTONE PATTERN

NOTE: PATTERN FOR MINOR CONCRETE (ISLAND PAVING)

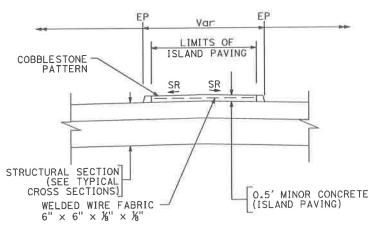

MINOR CONCRETE TREATMENT ISLAND LOCATION

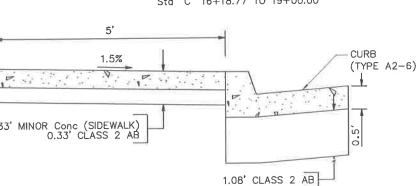

DRAWING:N09-300rge011.dw DESIGNED: MAS DRAWN: RG CHECKED: JOB NO: NO9-300 DATE: Apr 5, 2018

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REVISIONS




C WORKS
DIVISION NEVADA COUNTY DEPARTMENT OF PUBLIC WORK DESIGN/CONSTRUCTION DIVISIO



CORRIDOR DETAILS COMBIE ROAD (IMPROVEMENT CONSTRUCTION

SHEET

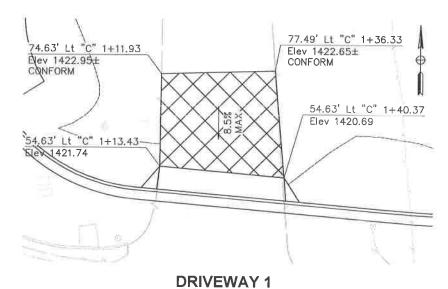

70.94' Lt "C" 2+89.22

Elev 1422.29±
CONFORM

58.12' Lt "C" 3+27.51

Elev 1421.92±
CONFORM

R=77'

44.42' Lt "C" 2+69.42 BC

Elev 1419.21

41.00' Lt "C" 3+14.85

Elev 1419.00

DRIVEWAY 2
"C" Sta 3+00.00

39.00' Rt "C" 10+13.85
Elev 1426.13

39.00' Rt "C" 10+32.37 EC
Elev 1425.97

R=93'

58.94' Rt "C" 10+34.75 BC

Elev 1425,01± CONFORM 62.24' Rt "C" 10+21.57

DRIVEWAY 3

"C" Sta 10+20.00

Elev 1425.04± CONFORM 100% SUBMITTAL

NO. DESCRIPTION BY DATE



NEVADA COUNTY
DEPARTMENT OF PUBLIC WORKS
DESIGN/CONSTRUCTION DIVISION





COMBIE ROAD CORRIDOR IMPROVEMENT PROJECT CONSTRUCTION DETAILS

DRAWING:NO9-300/ge012-deg
DESIGNED: MAS
DRAWN: BG
CHECKED: JPJ
JOB NO: NO9-300
DATE: Apr 5, 2018
SHEET

SCALE : 1" = 10'

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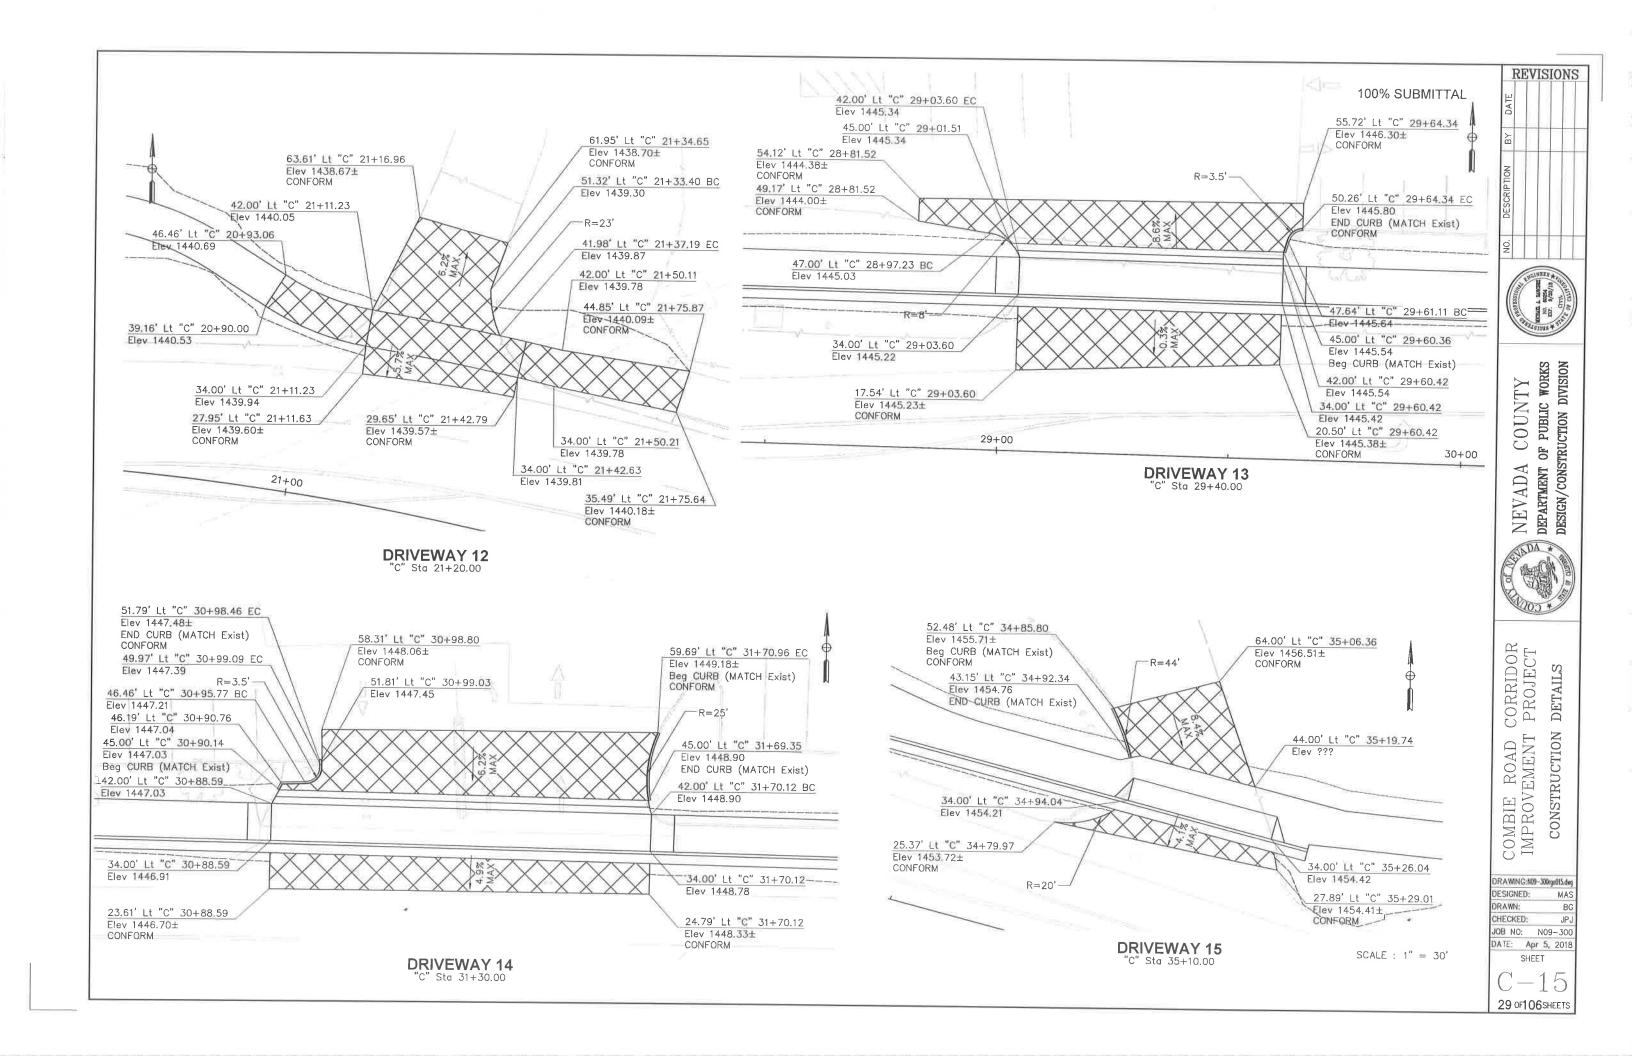


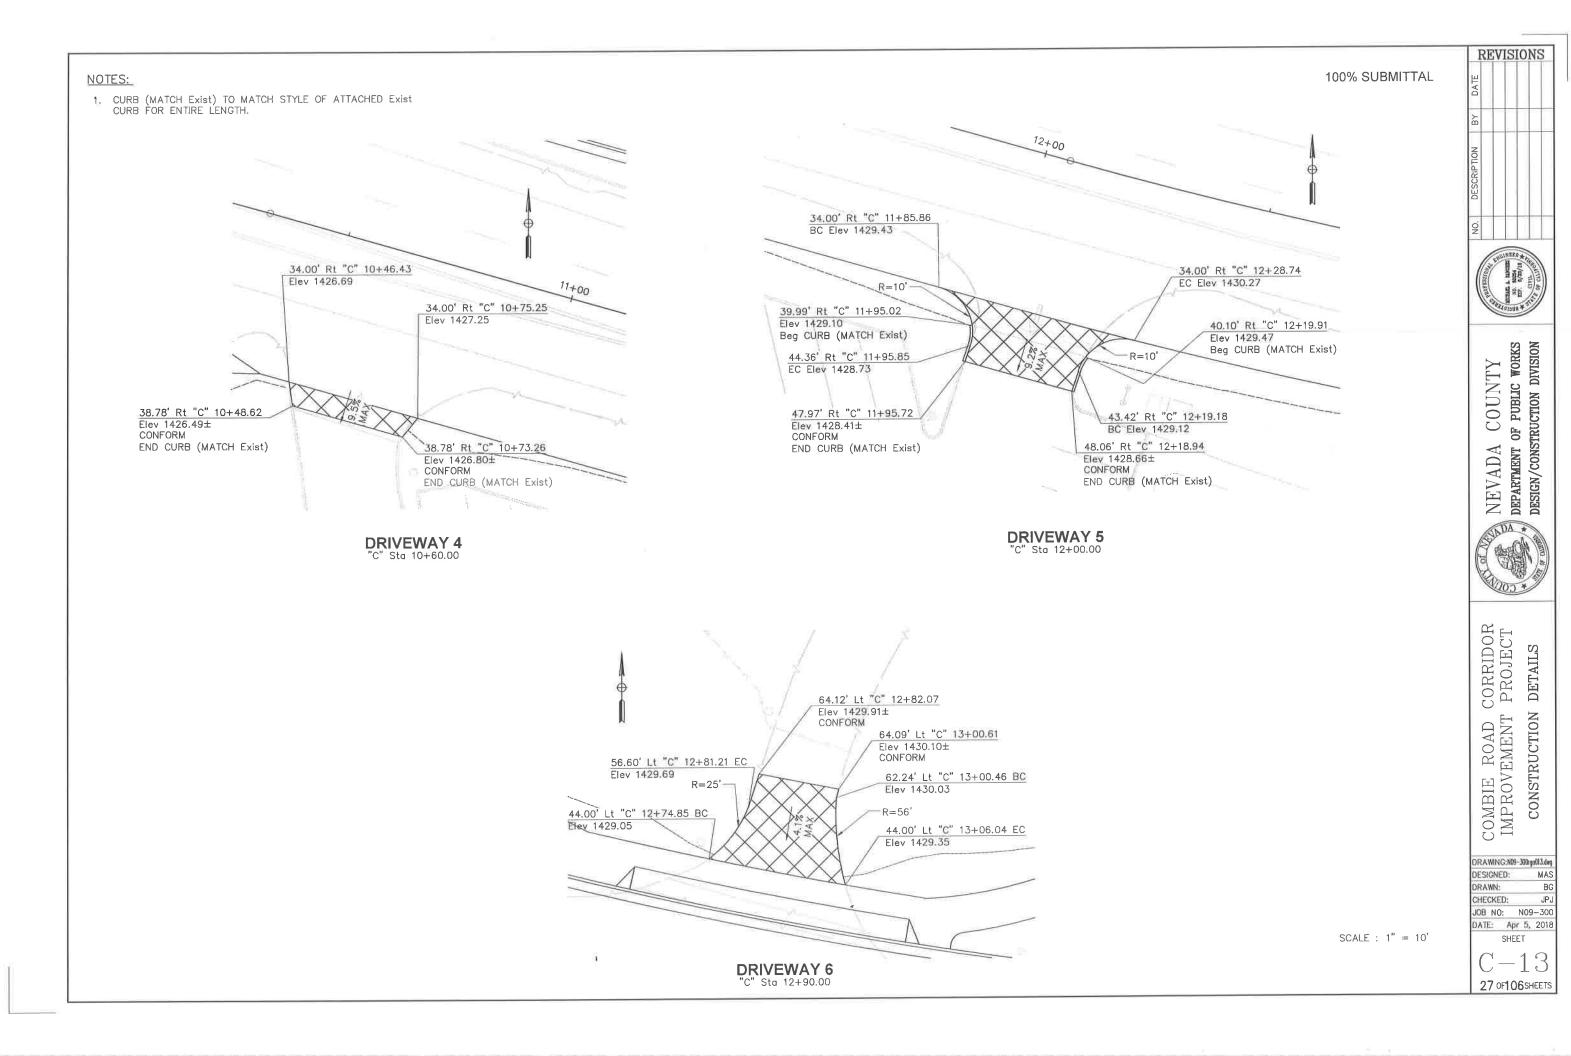
NEVADA COUNTY DEPARTMENT OF PUBLIC WORKS DESIGN/CONSTRUCTION DIVISION

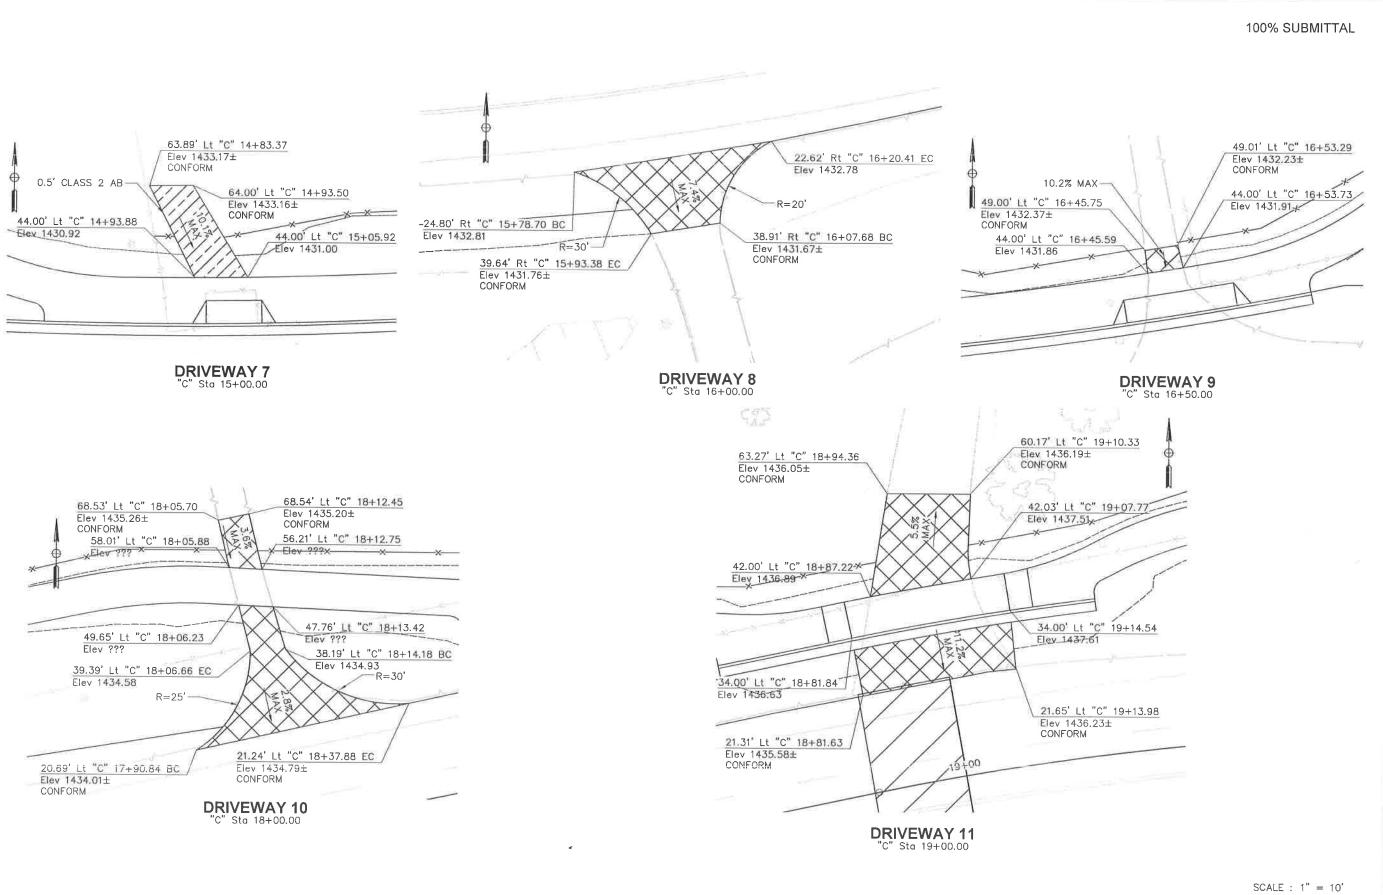

CORRIDOR PROJECT COMBIE ROAD CIMPROVEMENT

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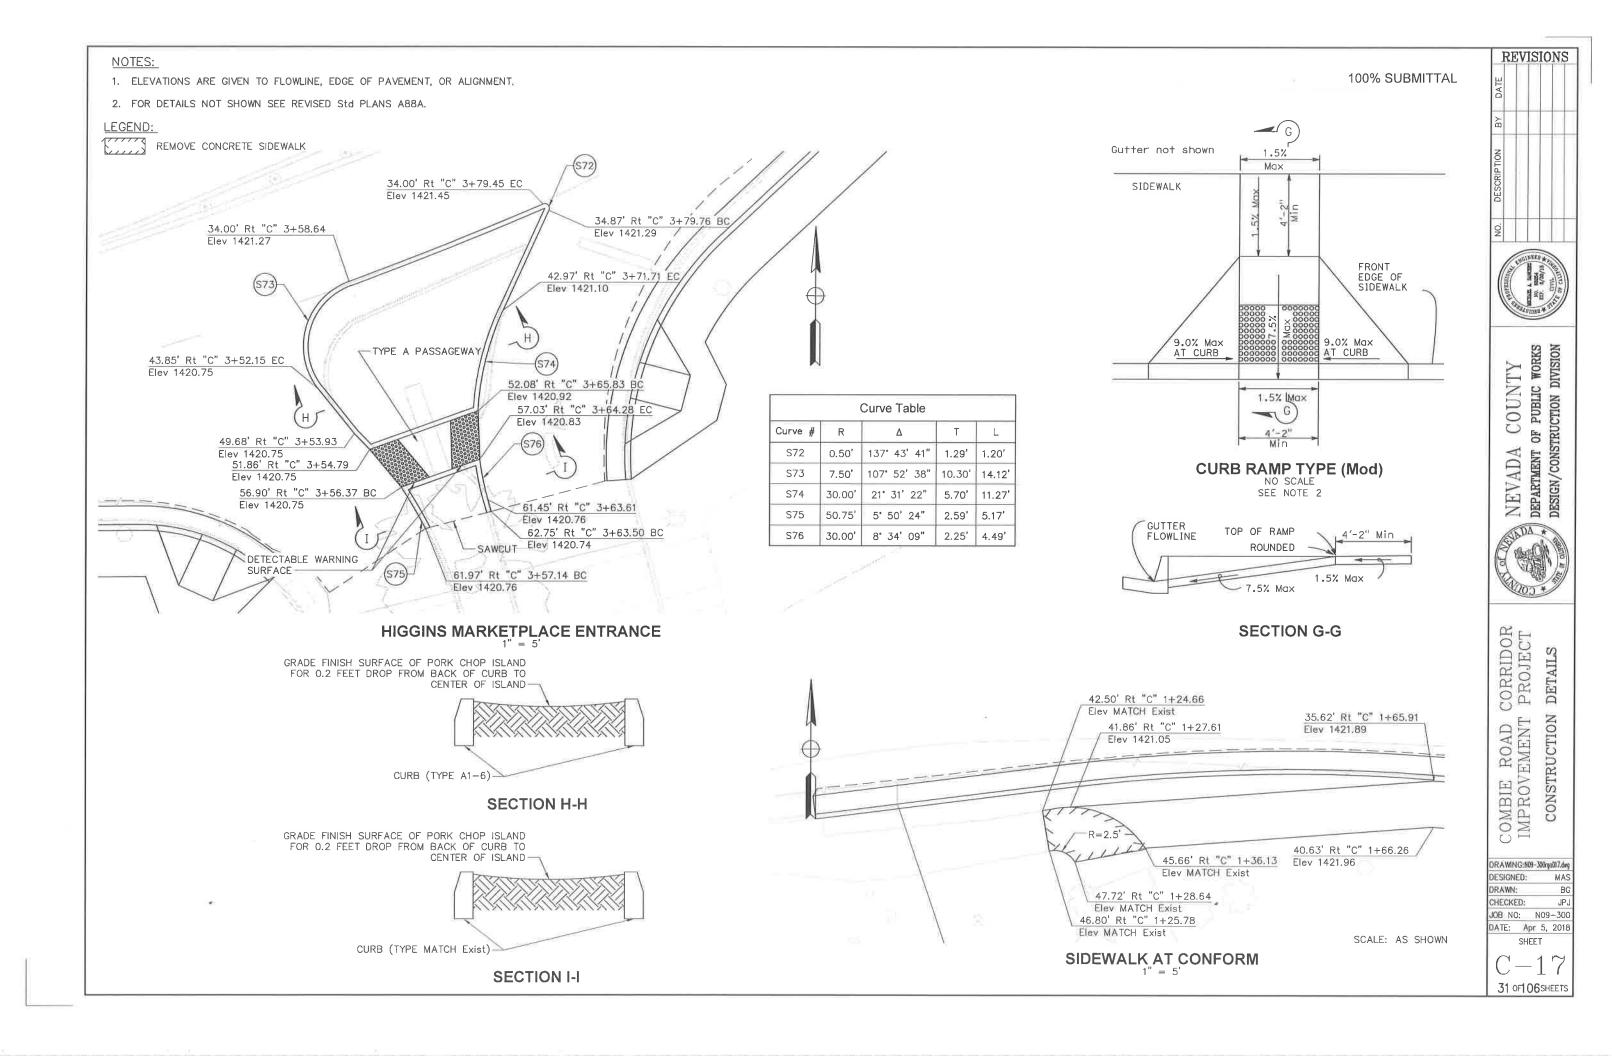
NEVADA COUNTY
DEPARTMENT OF PUBLIC WORKS
DESIGN/CONSTRUCTION DIVISION

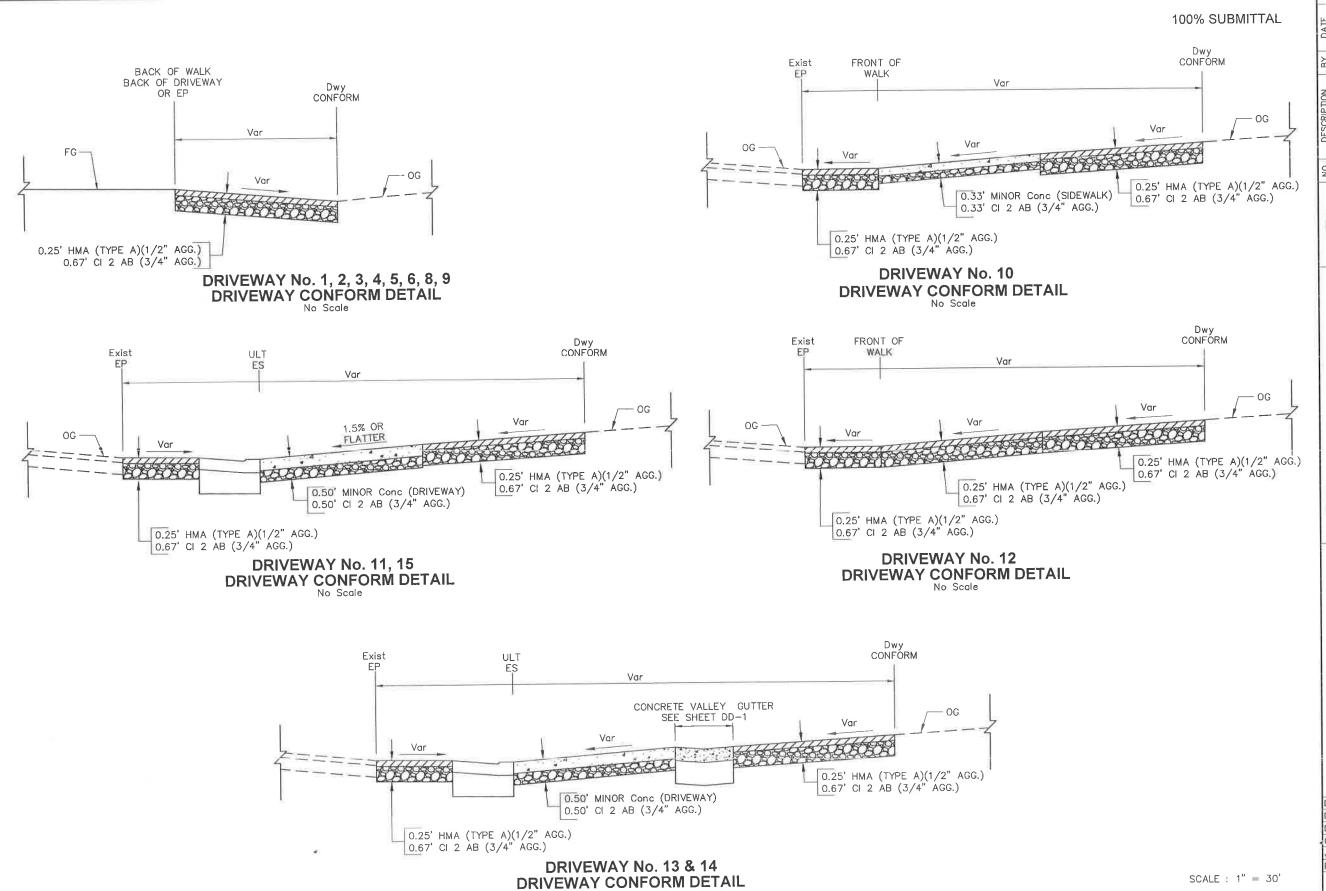


CORRIDOR PROJECT DETAILS COMBIE ROAD CIMPROVEMENT CONSTRUCTION

DRAWING: N09-300rgc016.de DESIGNED: DRAWN: CHECKED: JPJ JOB NO: N09-300 DATE: Apr 5, 2018 SHEET

30 of 106 SHEETS




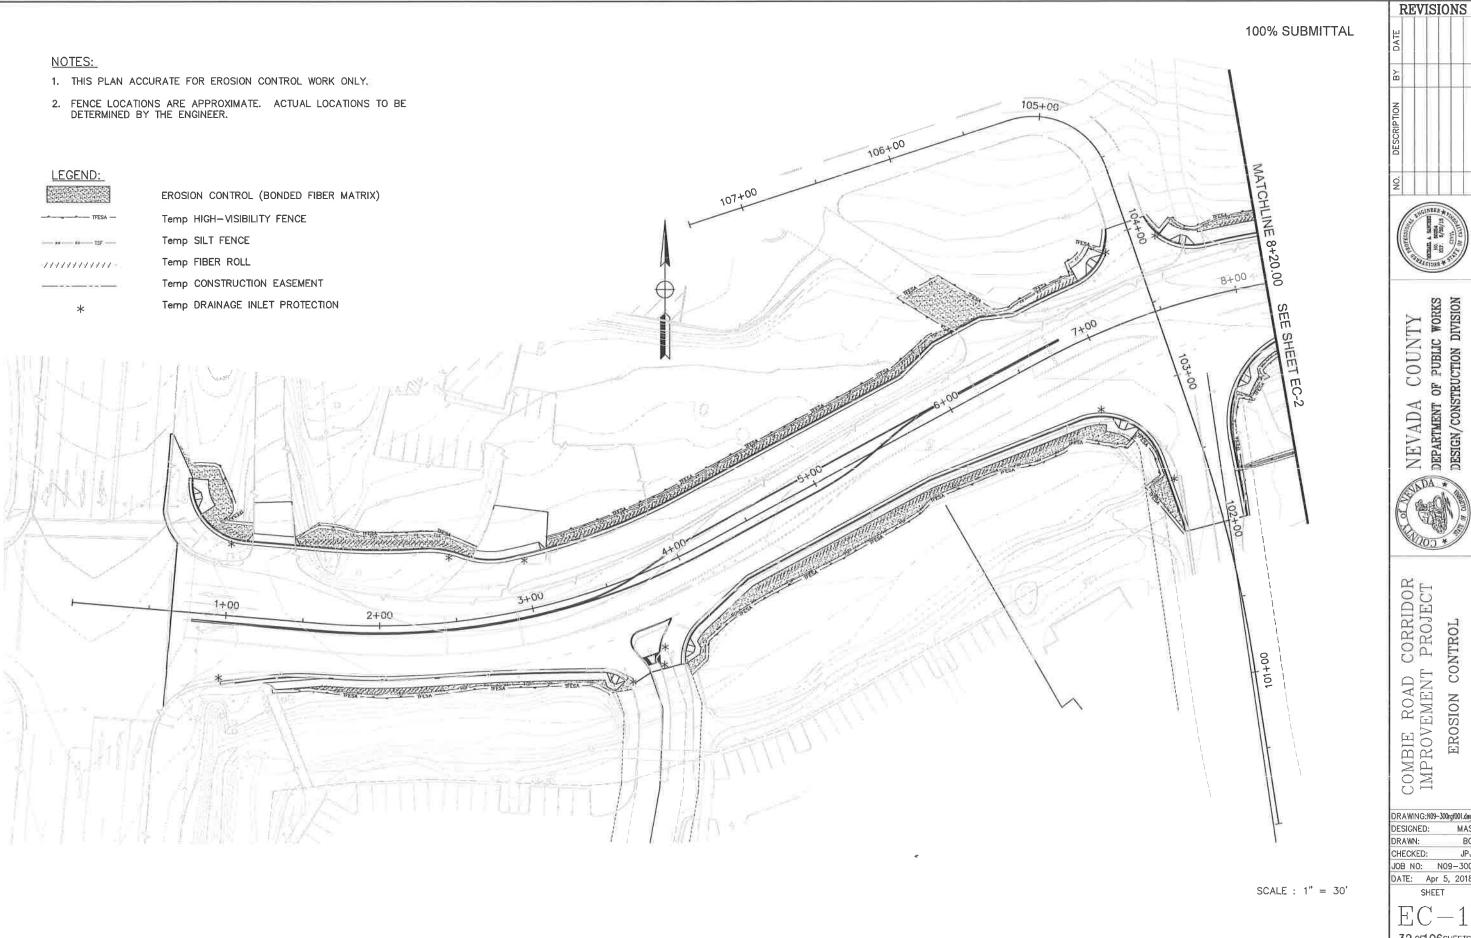

EROSION CONTROL

JOB NO: NO9-300 DATE: Apr 5, 2018

SHEET

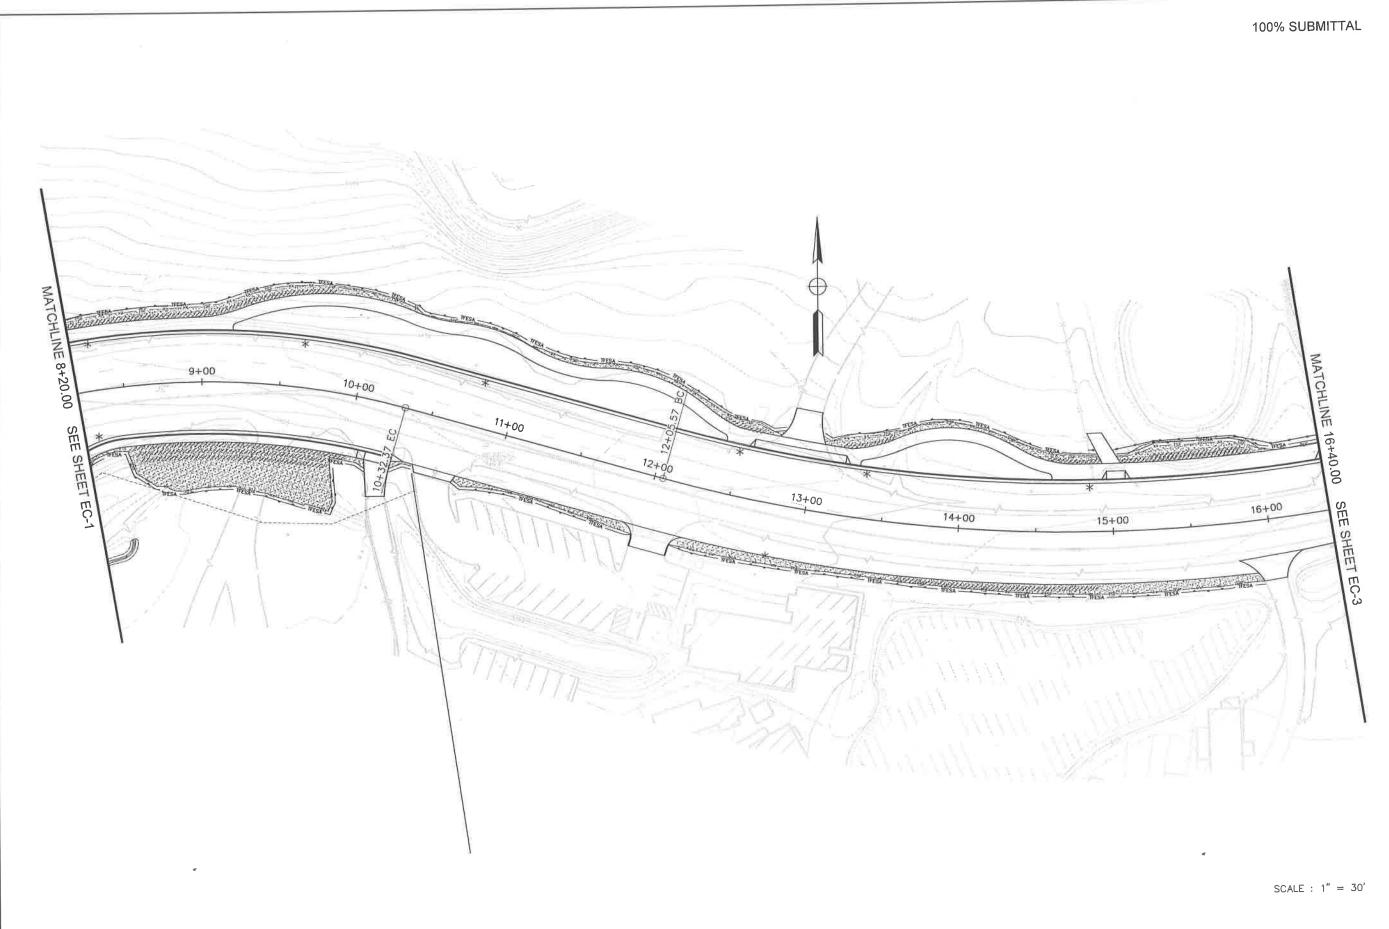


NEVADA COUNTY DEPARTMENT OF PUBLIC WORKS DESIGN/CONSTRUCTION DIVISION

COMBIE ROAD CORRIDOR IMPROVEMENT PROJECT EROSION CONTROL

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SHEET 33 OF 106 SHEETS



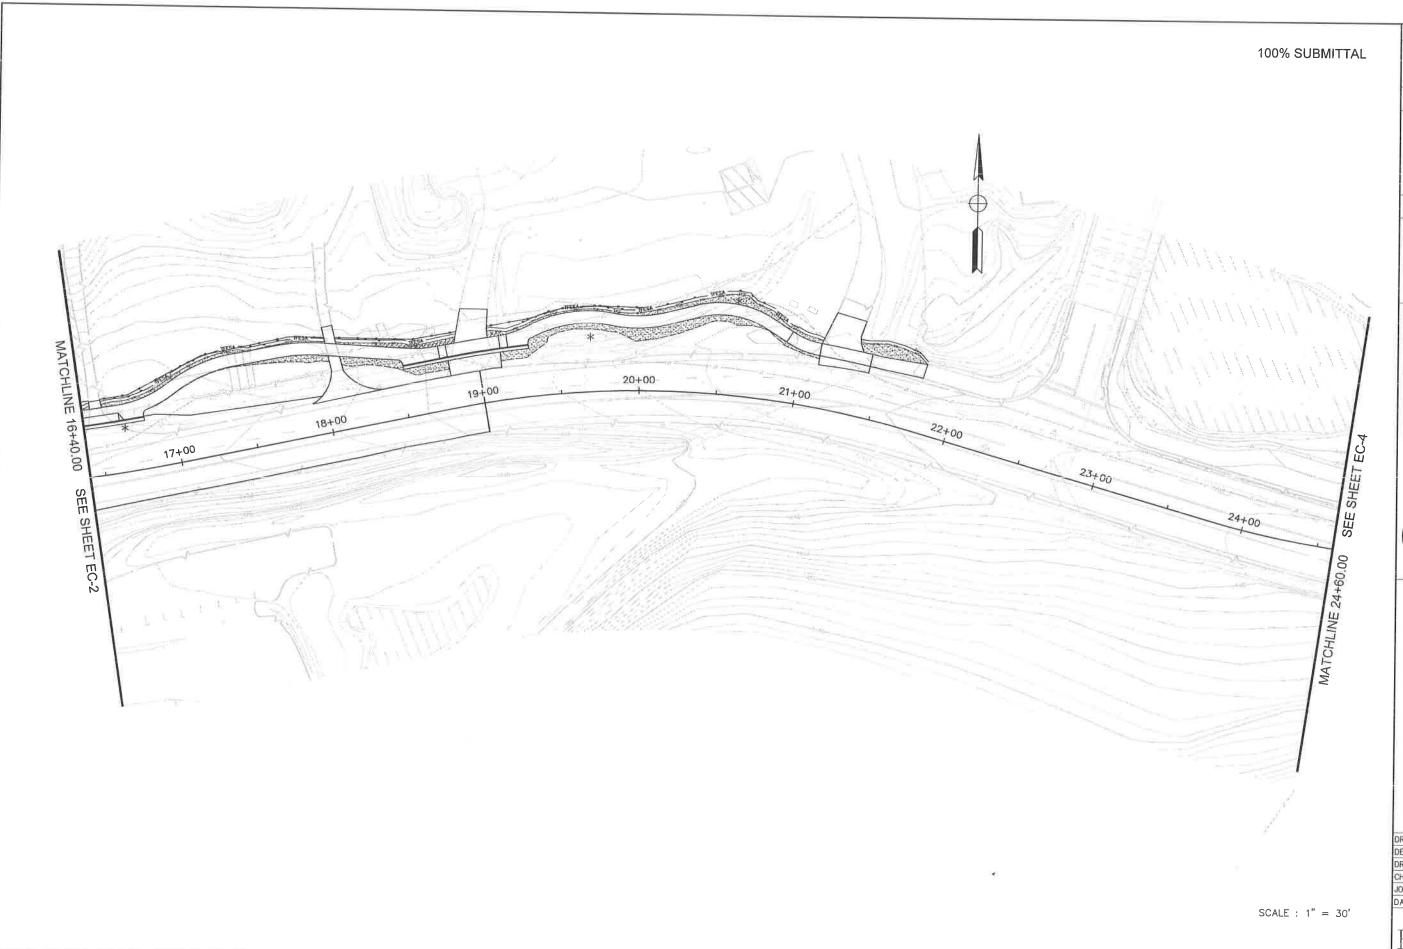









COMBIE ROAD CORRIDOR IMPROVEMENT PROJECT EROSION CONTROL

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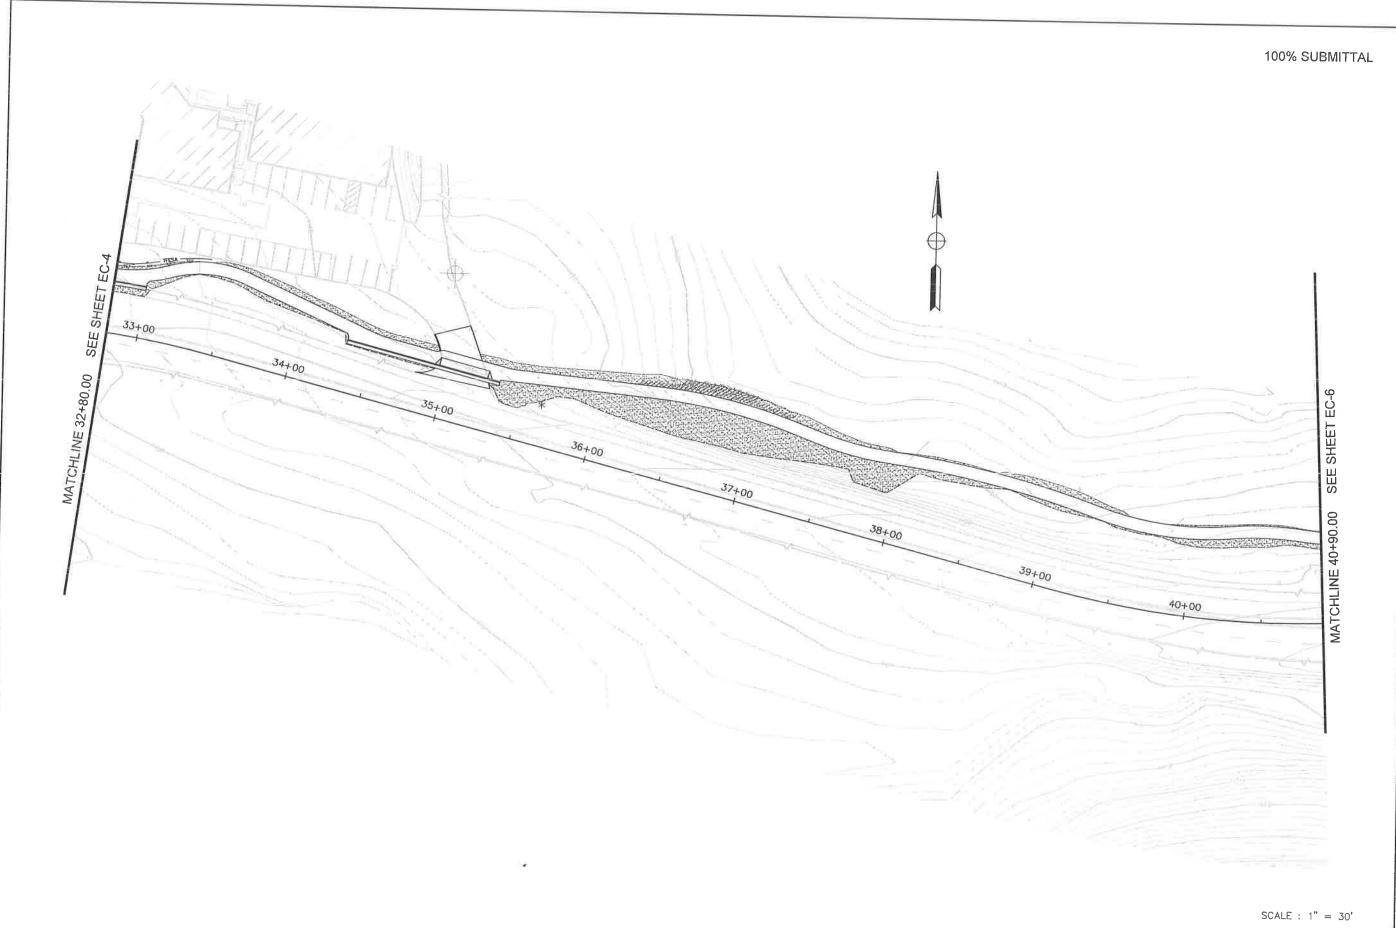


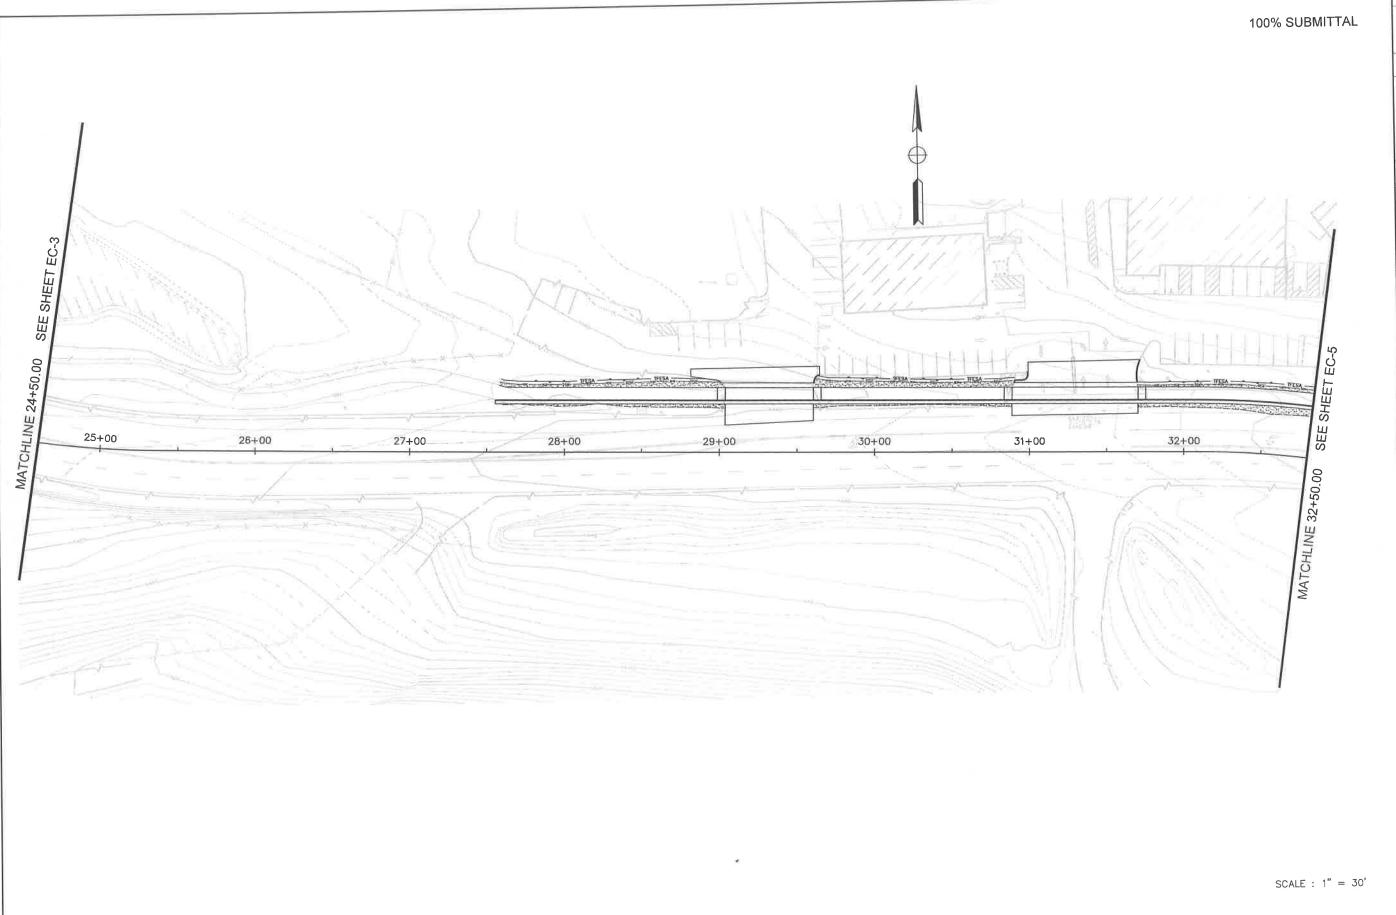NEVADA COUNTY DEPARTMENT OF PUBLIC WORKS DESIGN/CONSTRUCTION DIVISION

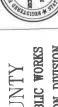

COMBIE ROAD CORRIDOR IMPROVEMENT PROJECT EROSION CONTROL

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REVISIONS

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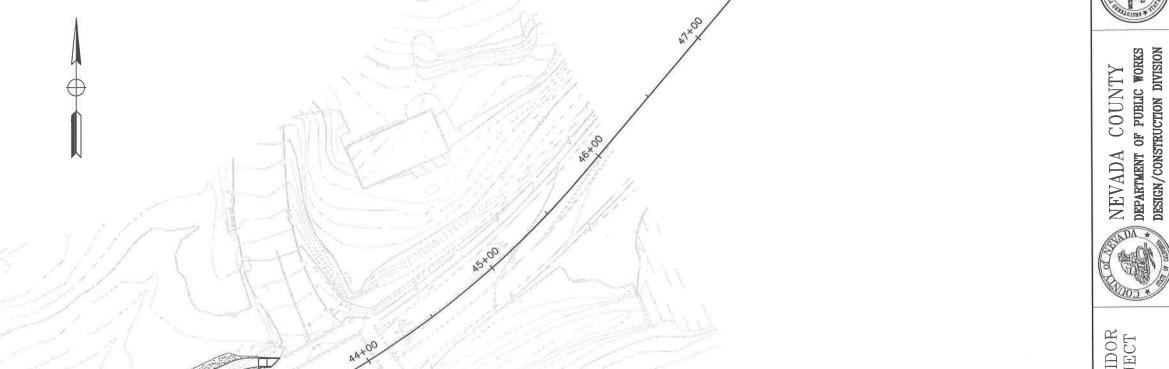
NEVADA COUNTY
DEPARTMENT OF PUBLIC WORKS
DESIGN/CONSTRUCTION DIVISION

COMBIE ROAD CORRIDOR IMPROVEMENT PROJECT EROSION CONTROL

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DESIGNED: MAS
DRAWN: BG
CHECKED: JPJ
JOB NO: N09-300
DATE: Apr 5, 2018
SHEET

EC-5 36 OF 106 SHEETS

REVISIONS 100% SUBMITTAL




COMBIE ROAD CORRIDOR IMPROVEMENT PROJECT EROSION CONTROL

DRAWING:109-300rg/006.dwg DESIGNED: MAS DRAWN: BG DESIGNED: MAS
DRAWN: BG
CHECKED: JPJ
JOB NO: N09-300
DATE: Apr 5, 2018
SHEET

37 OF 106 SHEETS

SCALE : 1" = 30'

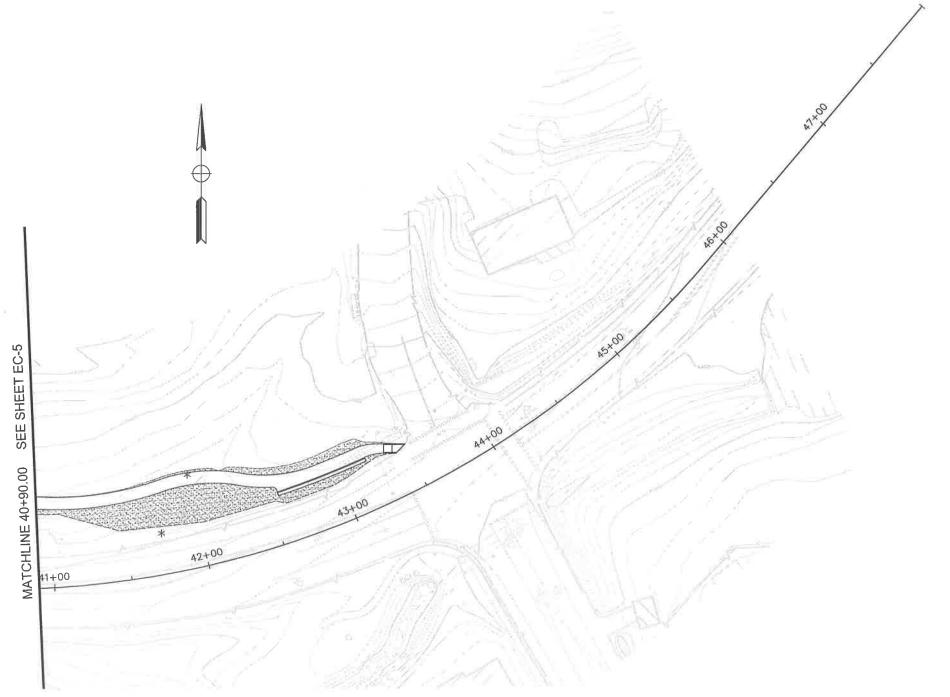

| , | | | | EROSIG | ON CONTR | OL QU | ANTITIE | S | | | |
|--------------|-----|----------|----|--------|----------|-------|--------------|------------------------|------------------------|---------------------------------|-------------------------------------|
| SHEET No. | | FROM | | | ТО | | AS HYDROSEED | T TEMPORARY FIBER ROLL | T TEMPORARY SILT FENCE | TEMPORARY HIGH-VISIBILITY FENCE | TEMPORARY DRAINAGE INLET PROTECTION |
| EC-3 | "C" | 16+55.00 | Lt | "C" | 18+00.00 | Lt | 218 | | 154 | 154 | EA |
| EC-3 | "C" | 18+05.00 | Lt | "C" | 18+90.00 | Lt | 556 | 54 | 78 | 78 | |
| EC-3 | "C" | 19+10.00 | Lt | "C" | 21+10.00 | Lt | 909 | | 230 | 230 | |
| EC-3 | "C" | 21+40.00 | Lt | "C" | 21+75.00 | Lt | 283 | | 47 | 47 | |
| EC-3 | "C" | 16+70.00 | Lt | - (**) | | - | | | | - ' | 1 |
| EC-3 | "C" | 19+60.00 | Lt | - | | 2 | | | | | 1 |
| EC-3 | "C" | 20+60.00 | Lt | 1,71 | - | - | | | | | 1 |
| EC-4 | "C" | 27+60,00 | Lt | "C" | 29+10.00 | Lt | 623 | | 142 | 142 | |
| EC-4 | "C" | 29+60.00 | Lt | "C" | 30+80.00 | Lt | 637 | | 128 | 128 | |
| EC-4 | "C" | 31+70.00 | Lt | "C" | 32+80.00 | Lt | 591 | | 115 | 115 | |
| EC-5 | "C" | 32+80.00 | Lt | "C" | 34+90.00 | Lt | 872 | | 221 | 221 | |
| EC-5 | "C" | 35+25.00 | Lt | "C" | 40+90.00 | Lt | 6297 | | 682 | 682 | |
| EC-6 | "C" | 35+00.00 | Lt | 120 | 14 | | | | | | 2 |
| EC-6 | "C" | 40+90.00 | Lt | "C" | 43+50.00 | Łt | 3100 | | 244 | 244 | |
| TOTAL | | | | | | | 27363 | 1507 | 4874 | 4874 | 24 |

| | SHEET No. | | FROM | | | то | | AS HYDROSEED | TEMPORARY FIBER ROLL | 디 TEMPORARY SILT FENCE | TEMPORARY HIGH-VISIBILITY FENCE | TEMPORARY DRAINAGE INLEY |
|-----|--------------|-----|----------|----|-------------------|----------|----|--------------|----------------------|------------------------|---------------------------------|--------------------------|
| | EC-1 | "C" | 0+60 | Lt | "C" | 1+10 | Lt | 774 | 35 | 92 | 92 | EA |
| | EC-1 | "C" | 1+50 | Lt | "C" | 2+60 | Lt | 800 | 109 | 118 | 118 | |
| | EC-1 | "C" | 3+20.00 | Lt | "C" | 7+40.00 | Lt | 960 | 280 | 434 | 434 | |
| | EC-1 | "C" | 7+50.00 | Lt | "C" | 8+20.00 | Lt | 158 | 25 | 77 | 77 | |
| | EC-1 | "C" | 1+50.00 | Rt | "C" | 3+40.00 | Rt | 555 | 82 | 221 | 221 | |
| | EC-1 | "C" | 3+75.00 | Rt | "C" | 7+10.00 | Rt | 2448 | 231 | 375 | 375 | |
| | EC-1 | "C" | 7+50.00 | Rt | "C" | 8+20.00 | Rt | 188 | | 128 | 128 | |
| İ | EC-1 | "C" | 1+00.00 | Lt | - | + | * | | | | 120 | 1 |
| 1 | EC-1 | "C" | 1+00.00 | Rt | × | - | 12 | | | | | 1 |
| - [| EC-1 | "C" | 2+50.00 | Lt | - 2 | - | - | | | | | 1 |
| ĺ | EC-1 | "C" | 3+00.00 | Lt | - | * | * | | | | | 1 |
| ĺ | EC-1 | "C" | 3+45.00 | Rt | -5 | × | - | | | | | 1 |
| | EC-1 | "C" | 3+60.00 | Rt | - | ā | | | | | | 1 |
| | EC-1 | "C" | 365.0 | Rt | 5. | | # | | | | | 1 |
| | EC-1 | "C" | 6+85.00 | Rt | 38 | æ | 2 | | | | | 1 |
| | EC-1 | "C" | 7+20.00 | Rt | 161 | | | | | | | 1 |
| | EC-1 | "C" | 72+50.00 | Lt | 1,5 | - | | | | | | 1 |
| | EC-1 | "C" | 7+55.00 | Lt | (3 4) | - | æ | | | | | 1 |
| | EC-2 | "C" | 8+20.00 | Lt | "C" | 12+75.00 | Lt | 1014 | 176 | 484 | 484 | |
| | EC-2 | "C" | 8+20.00 | Rt | "C" | 9+30.00 | Rt | 1886 | | 106 | 106 | |
| | EC-2 | "C" | 13+00.00 | Lt | "C" | 14+95.00 | Lt | 418 | 72 | 183 | 183 | |
| | EC-2 | "C" | 15+05.00 | Lt | "C" | 16+40.00 | Lt | 560 | 142 | 137 | 137 | |
| | EC-2 | "C" | 8+20.00 | Rt | "C" | 9+30.00 | Rt | | | | | |
| | | | | | | | | | | | | |

| TOTAL | 13496 | 1454 | 2988 | 2988 | 19 |
|-------|-------|------|------|------|----|

10+20.00

11+95.00

16+00.00

EC-2

"C"

9+50.00

10+75.00

12+15.00

8+30.00

8+30.00

9+60.00

10+75.00

12+50.00

12+80.00

13+40.00

14+90.00

Rt

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.

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123

388

1

100% SUBMITTAL

REVISIONS



NEVADA COUNTY DEPARTMENT OF PUBLIC WORKS DESIGN/CONSTRUCTION DIVISION

COMBIE ROAD CORRIDOR IMPROVEMENT PROJECT EROSION CONTROL

DRAWING:N09-300rgg001.dwg DESIGNED: MAS DRAWN: CHECKED: JPJ JOB NO: N09-300 DATE: Apr 5, 2018 SHEET

ECQ-138 OF 106 SHEETS 1. THIS PLAN ACCURATE FOR GRADING WORK ONLY.

100% SUBMITTAL

| R | ΕV | IS | 0 | NS | |
|-------------|---------------------|---------------------|---------------------|---------------------|----------------|
| DATE | | | | | |
| В | | | | | |
| DESCRIPTION | | | | | |
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NEVADA COUNTY DEPARTMENT OF PUBLIC WORKS DESIGN/CONSTRUCTION DIVISION




COMBIE ROAD CORRIDOR IMPROVEMENT PROJECT CONTOUR GRADING

DRAWING:1609-300tha001.dag DESIGNED: MAS BG JPJ DRAWN: CHECKED: JOB NO: N09-300 DATE: Apr 5, 2018


SHEET G-1**39 OF 106** SHEETS

COMBIE RD

SR49/ COMBIE Rd GRADING

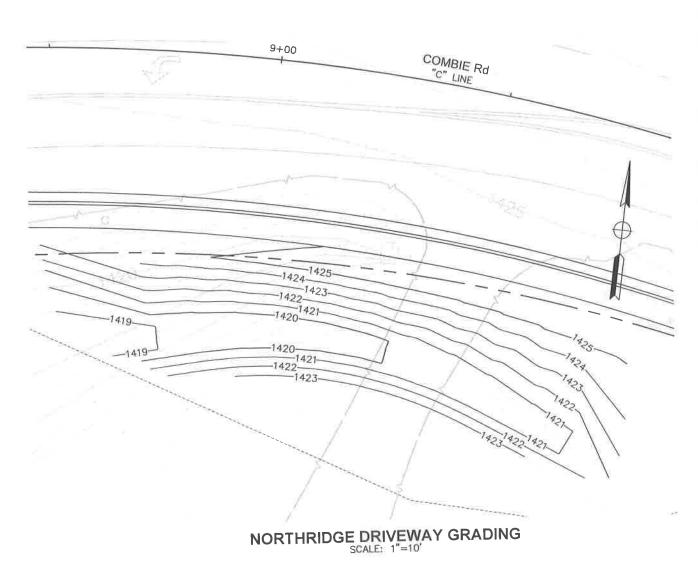

SCALE : AS SHOWN

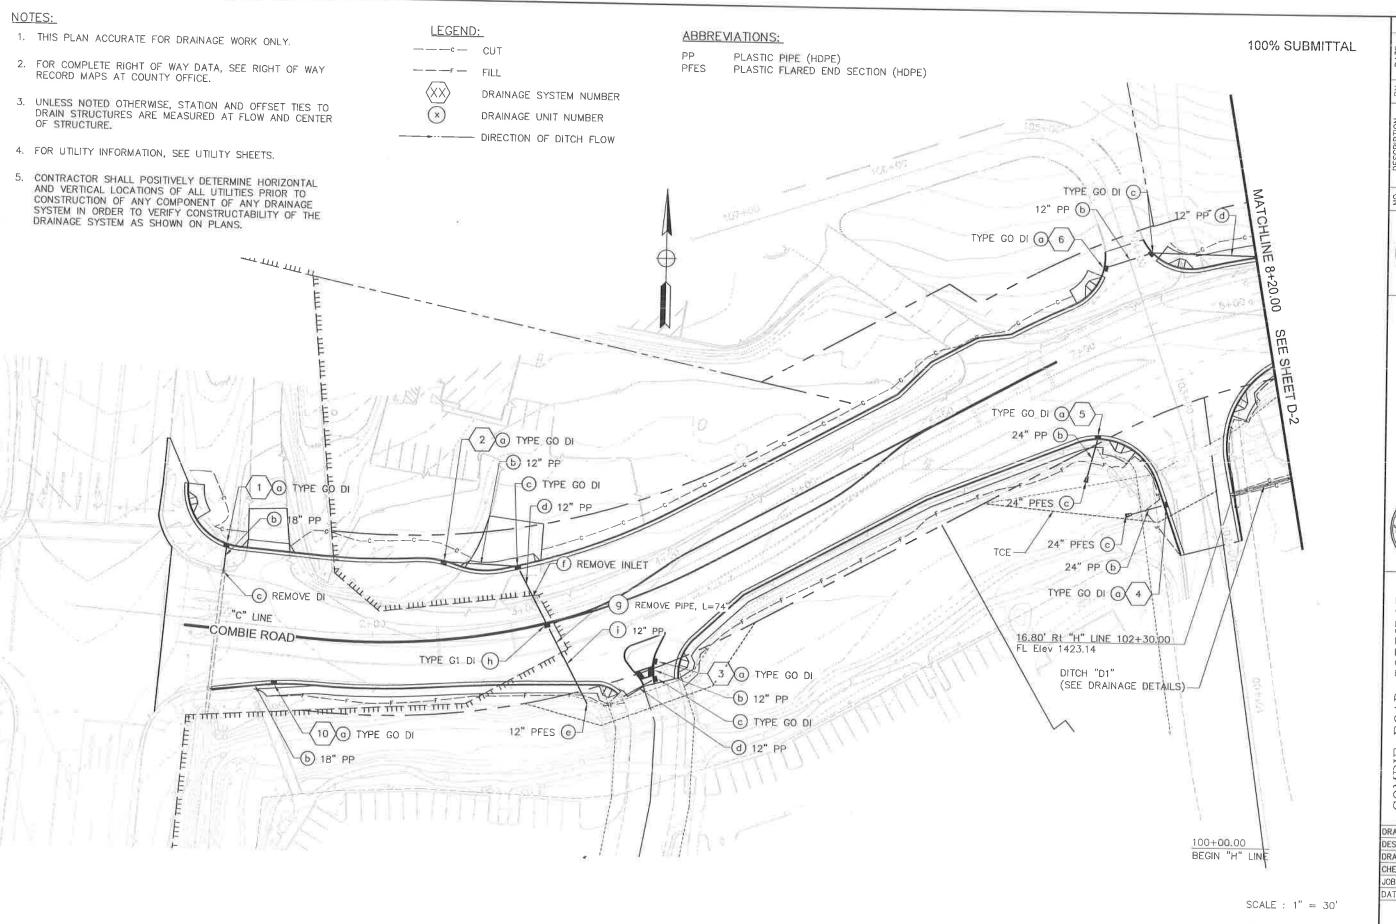

THE REAL PROPERTY OF THE PROPE


NEVADA COUNTY
DEPARTMENT OF PUBLIC WORKS
DESIGN/CONSTRUCTION DIVISION



COMBIE ROAD CORRIDOR IMPROVEMENT PROJECT DRAINAGE PLAN

DRAWING:N09-300io001.dwg
DESIGNED: MAS
DRAWN: BG
CHECKED: JPJ
JOB NO: N09-300
DATE: Apr 5, 2018
SHEET

1) — 1 40 of 106 sheets

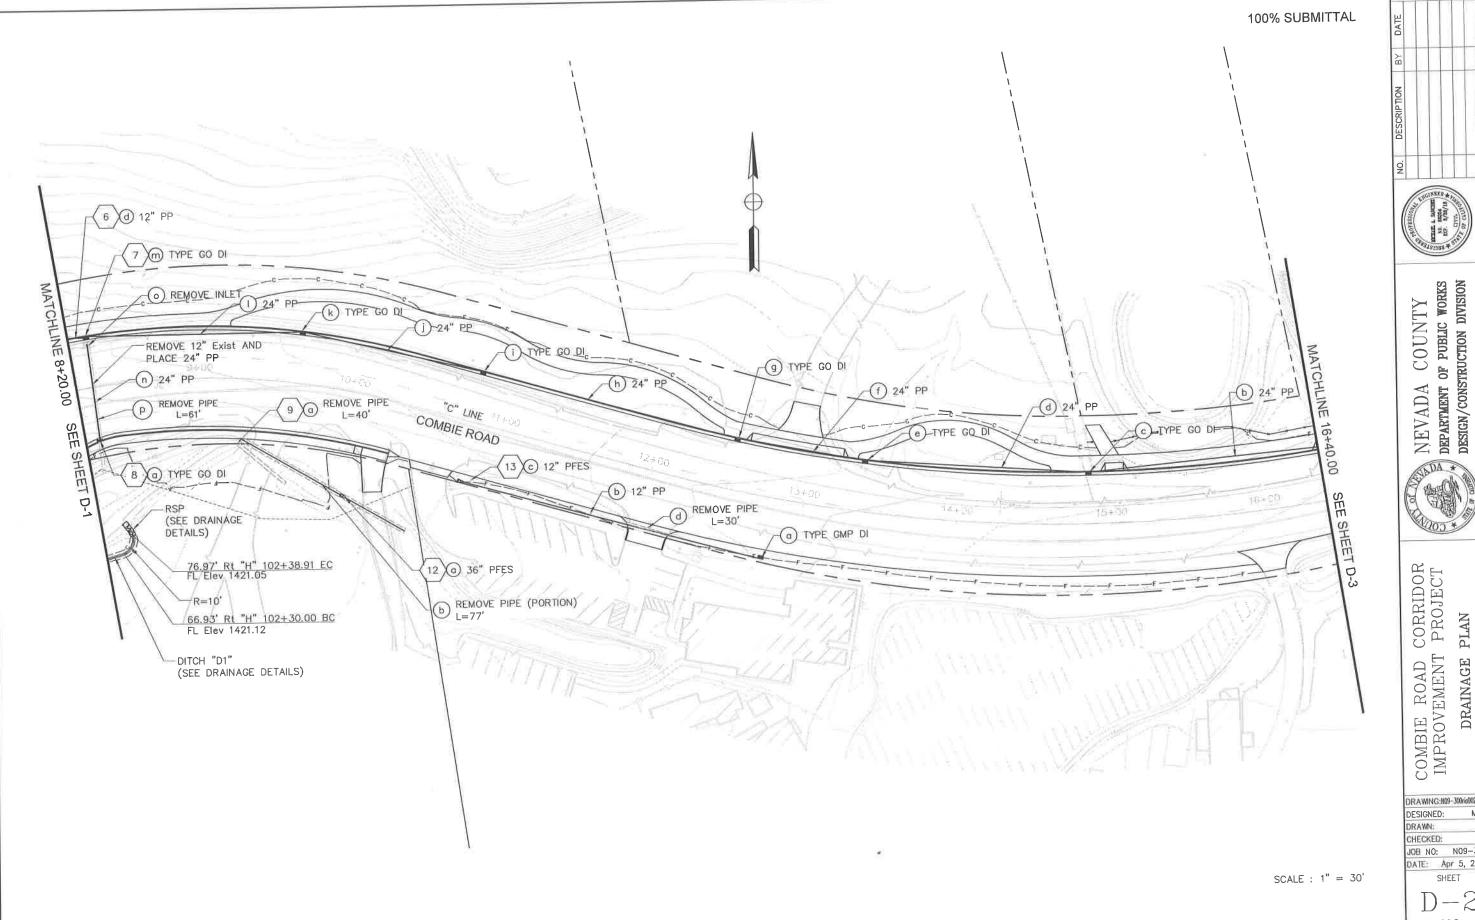






ADA *

DRAINAGE

DRAWING:N09-300ris002.dwg DESIGNED:


MAS JPJ JOB NO: NO9-300 DATE: Apr 5, 2018 SHEET

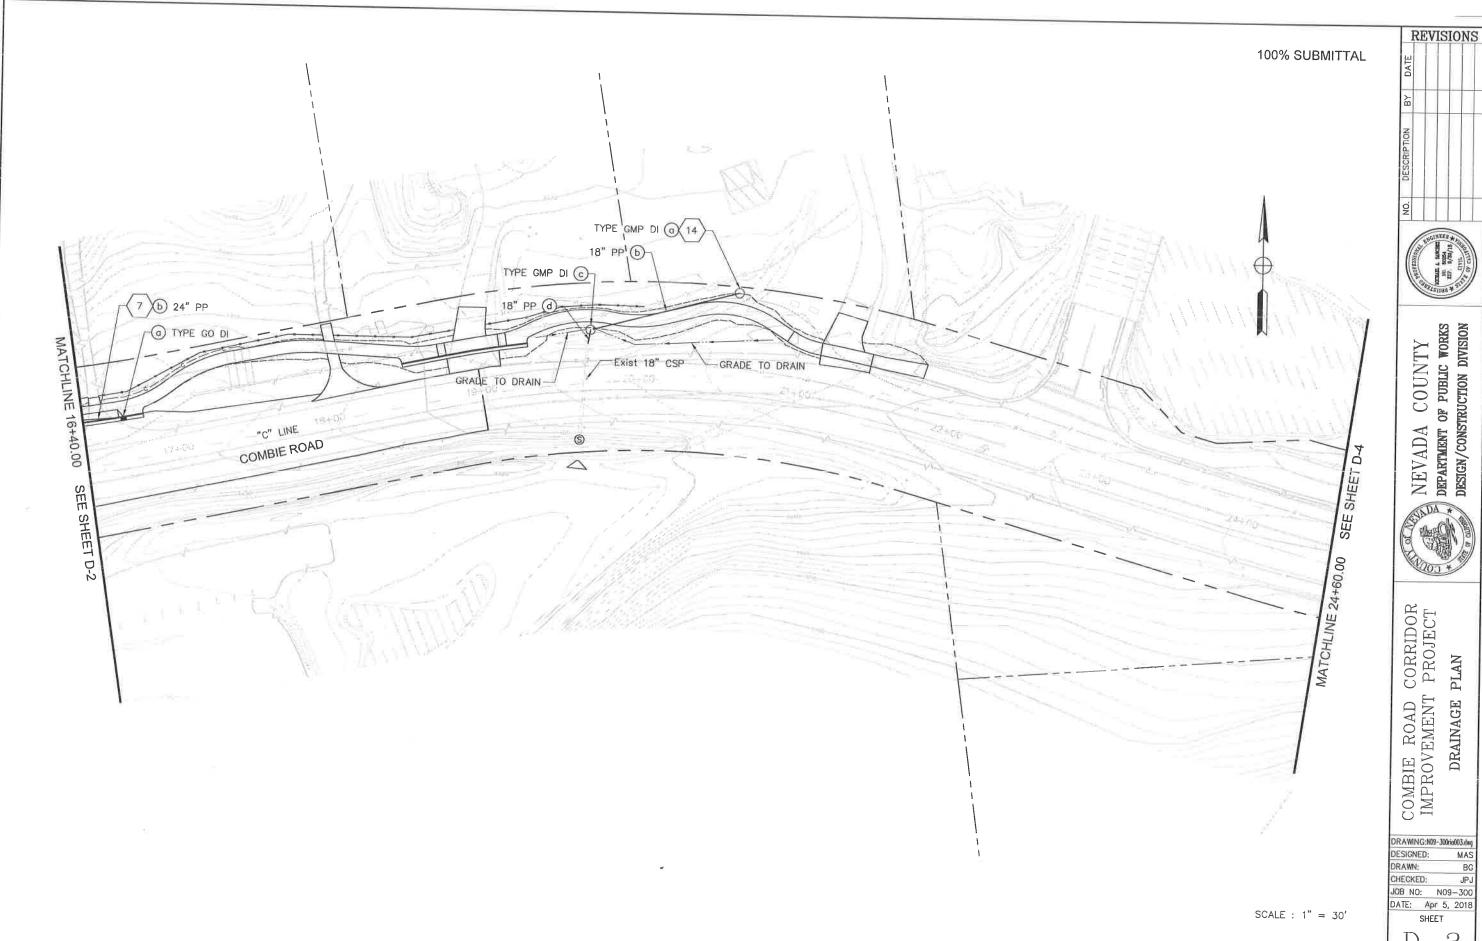

NEVADA COUNTY
DEPARTMENT OF PUBLIC WORKS
DESIGN/CONSTRUCTION DIVISION

COMBIE ROAD CORRIDOR IMPROVEMENT PROJECT DRAINAGE PLAN

DRAWING:N09-300ria003.dw DESIGNED: MAS BG JPJ DRAWN: CHECKED: JOB NO: NO9-300 DATE: Apr 5, 2018 SHEET

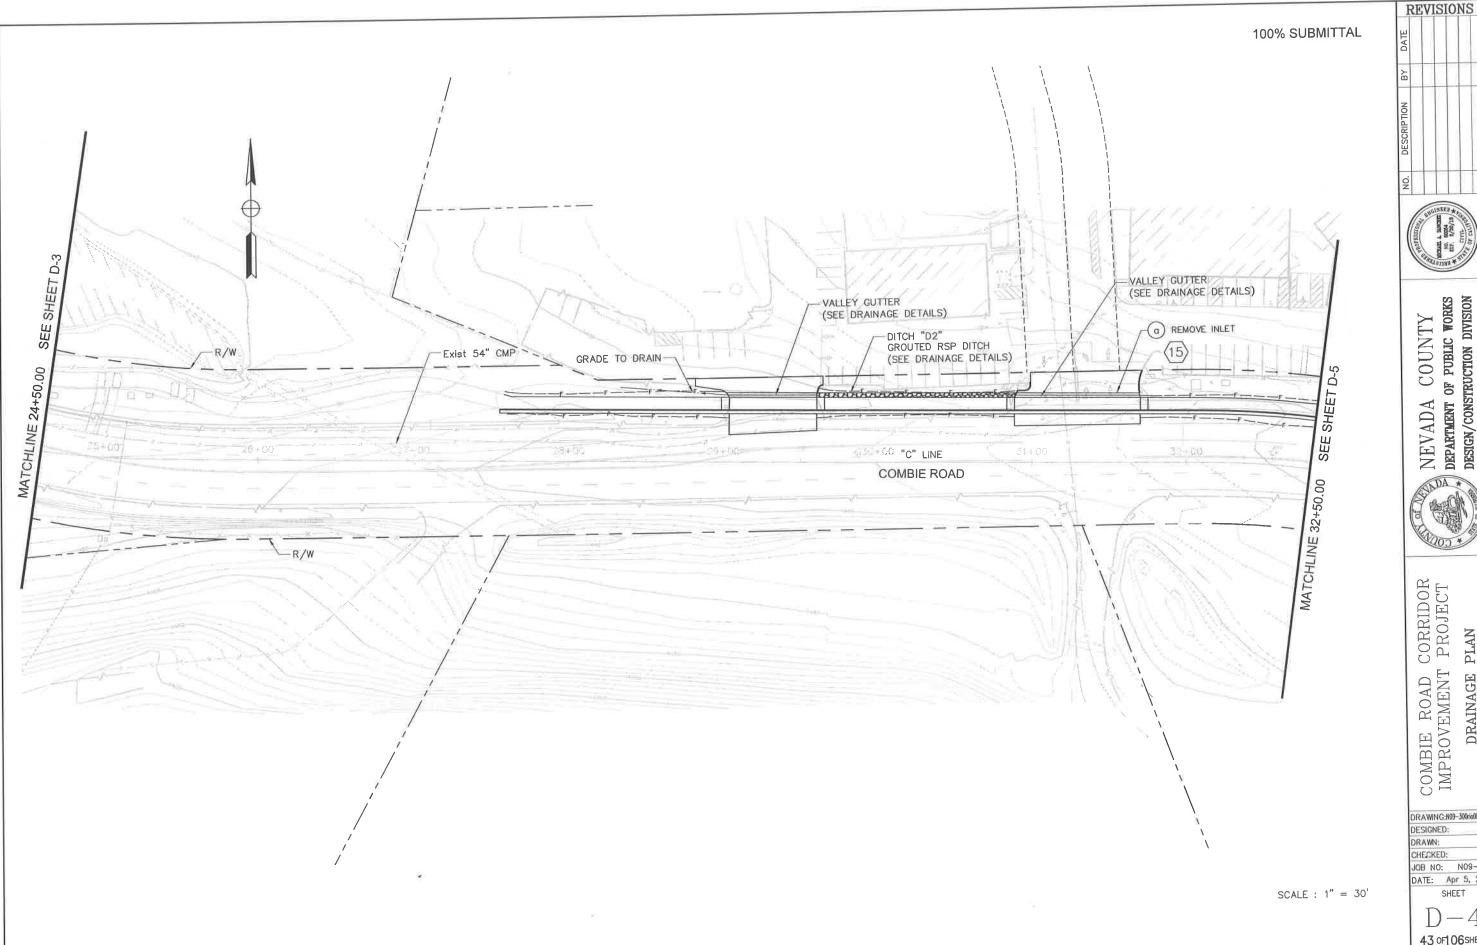




NEVADA COUNTY DEPARTMENT OF PUBLIC WORKS DESIGN/CONSTRUCTION DIVISION



COMBIE ROAD CORRIDOR IMPROVEMENT PROJECT PLAN DRAINAGE]

| DRAWING: | H09-3 | 00rio | 004.6 |
|----------|-------|-------|-------|
| DESIGNED | Ų. | | M/ |
| DRAWN: | | | E |
| CHECKED | : | | J |
| JOB NO: | N | 09 | -30 |
| DATE: | Арг | 5, | 20 |

SHEET

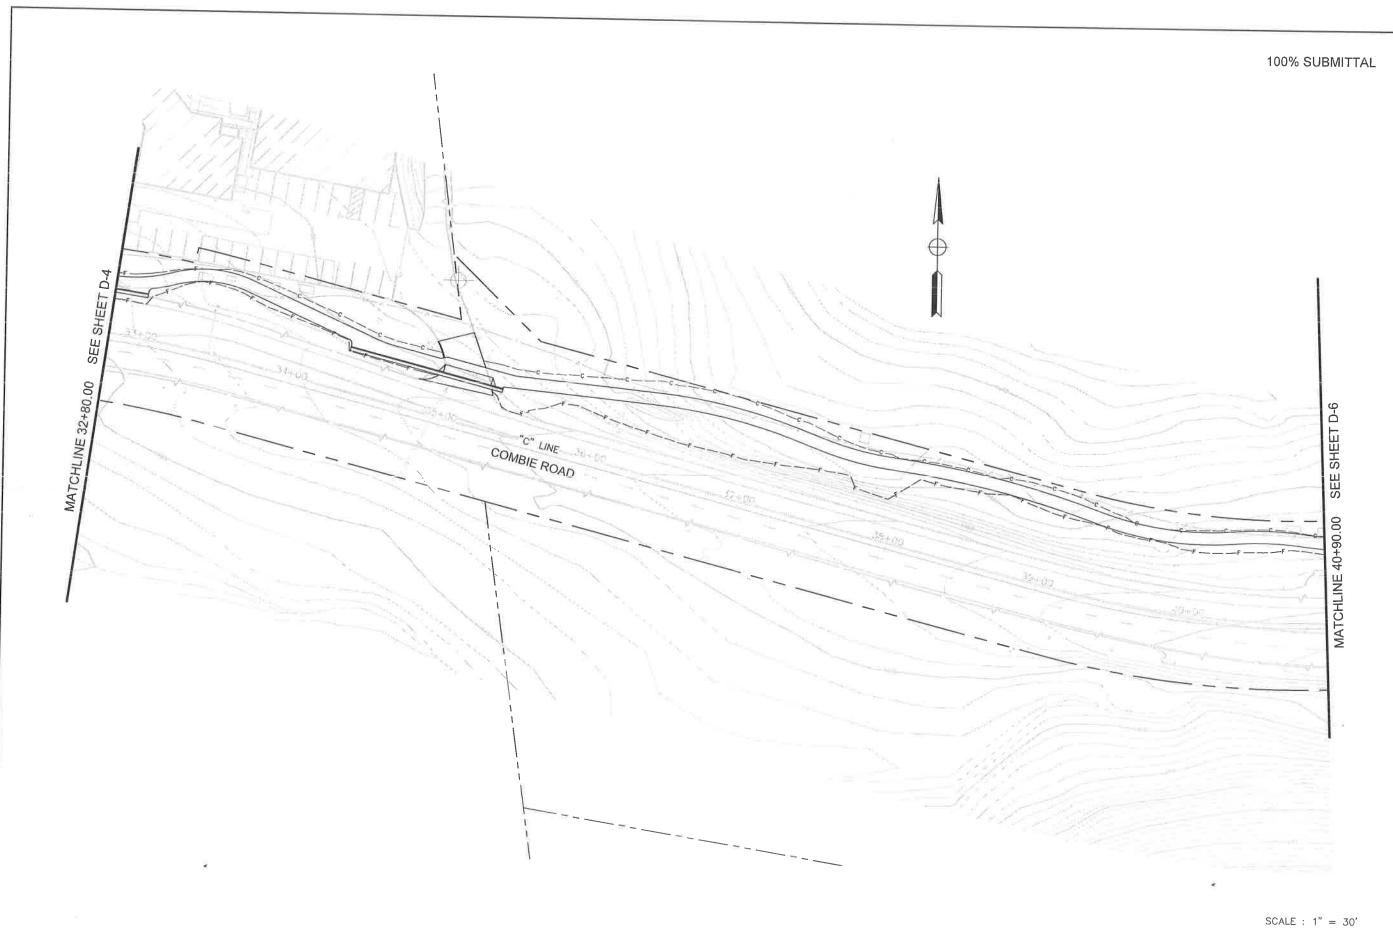

NO. DESCRIPTION BY DATE

THE A STATE OF THE
NEVADA COUNTY
DEPARTMENT OF PUBLIC WORKS
DESIGN/CONSTRUCTION DIVISION

NEVA DEPART

COMBIE ROAD CORRIDOR IMPROVEMENT PROJECT DRAINAGE PLAN

DRAWING:N09-300rio005.ding
DESIGNED: MAS
DRAWN: BG
CHECKED: JPJ
JOB NO: N09-300
DATE: Apr 5, 2018
SHEET

D-5 44 OF1 06 SHEETS








NEVADA COUNTY
DEPARTMENT OF PUBLIC WORKS
DESIGN/CONSTRUCTION DIVISION


COMBIE ROAD CORRIDOR IMPROVEMENT PROJECT DRAINAGE PLAN

DRAWING:N09-300ria006.dwg DESIGNED: MAS DRAWN: BG
CHECKED: JPJ
JOB NO: N09-300 DATE: Apr 5, 2018 SHEET

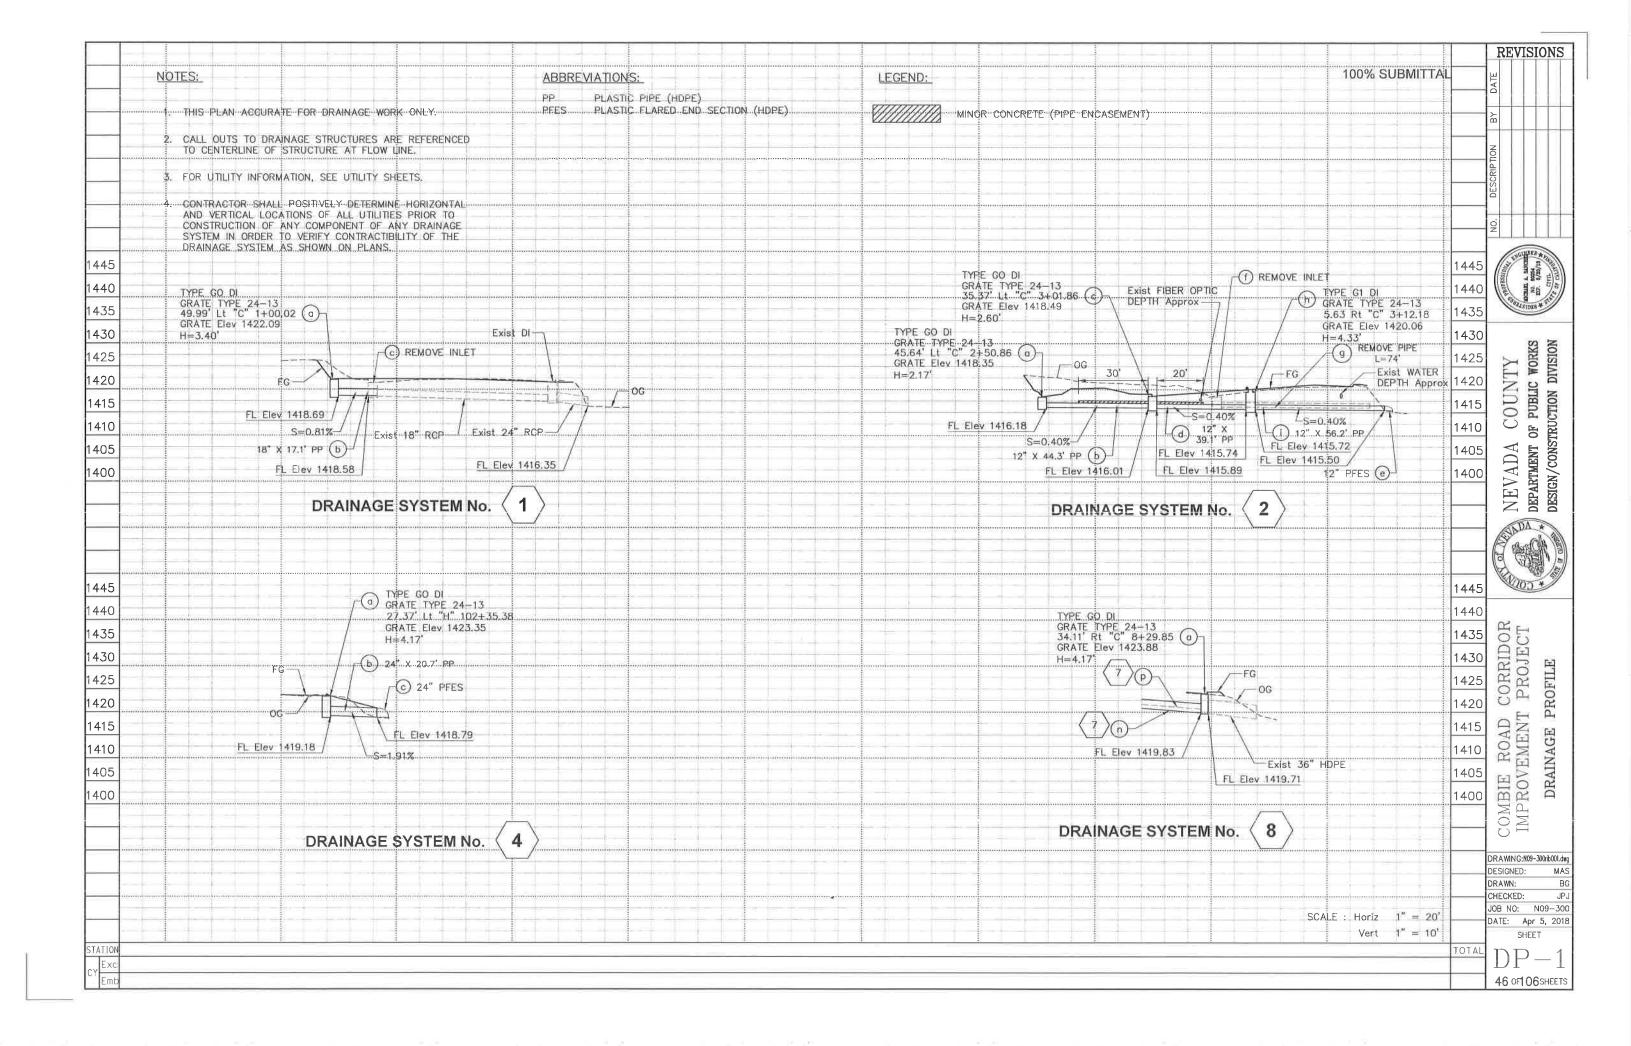

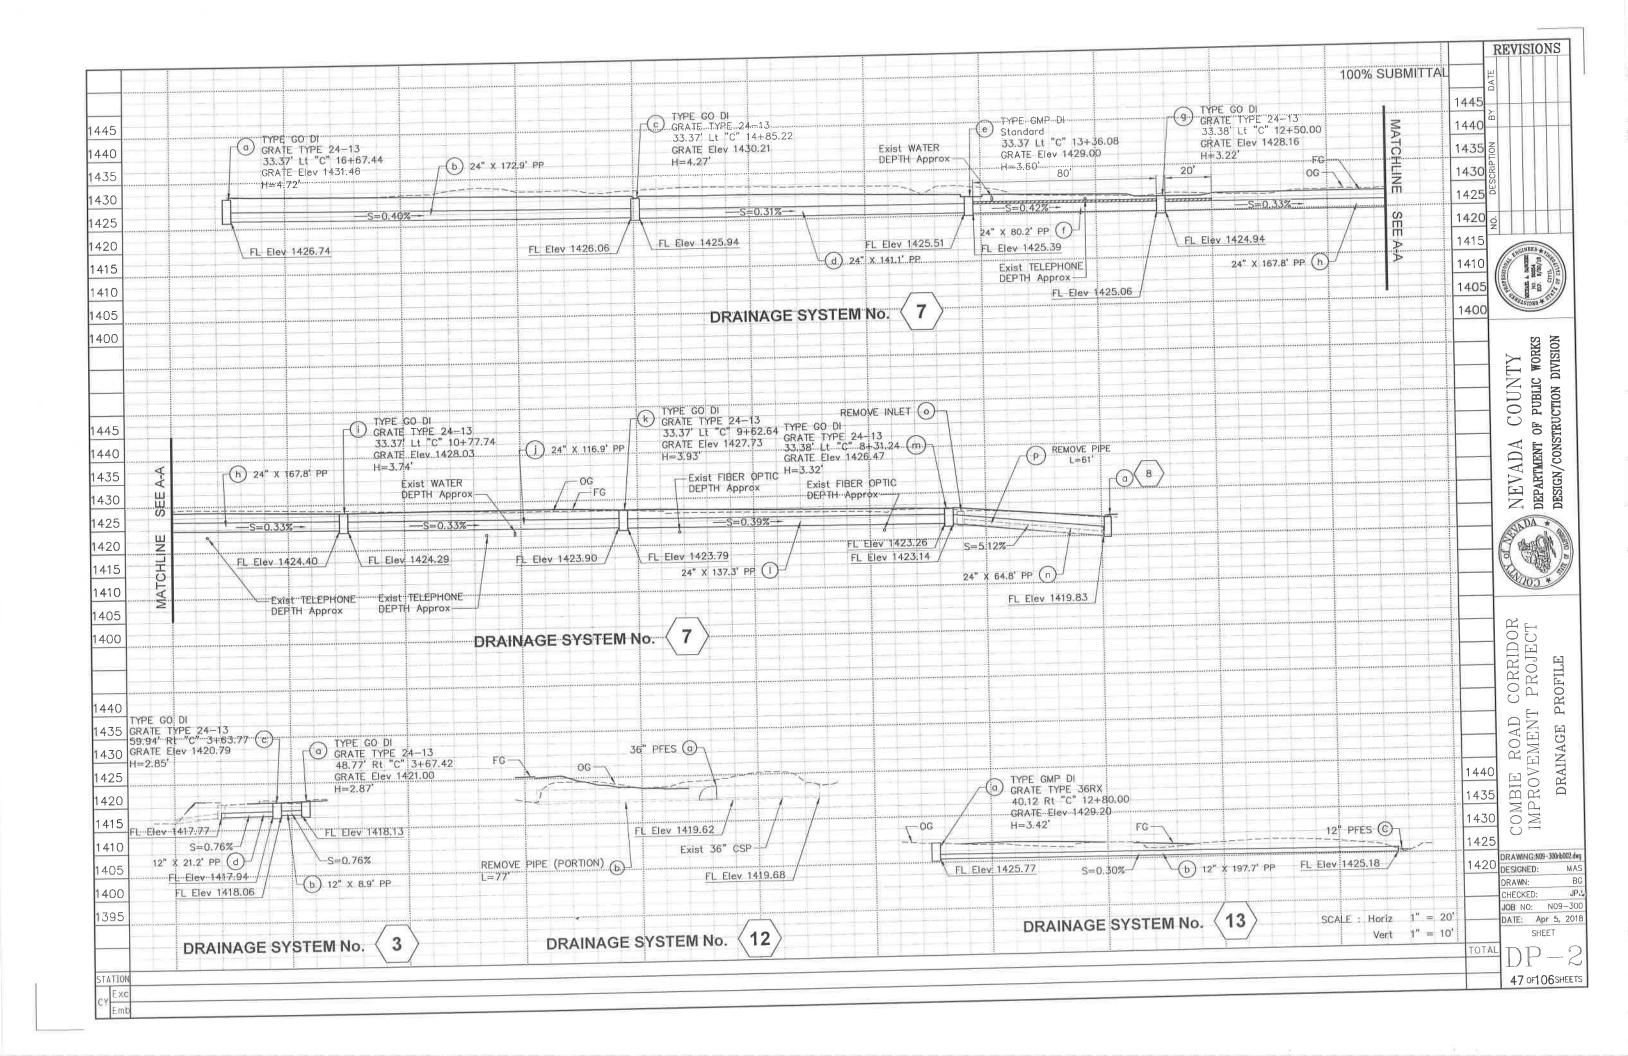


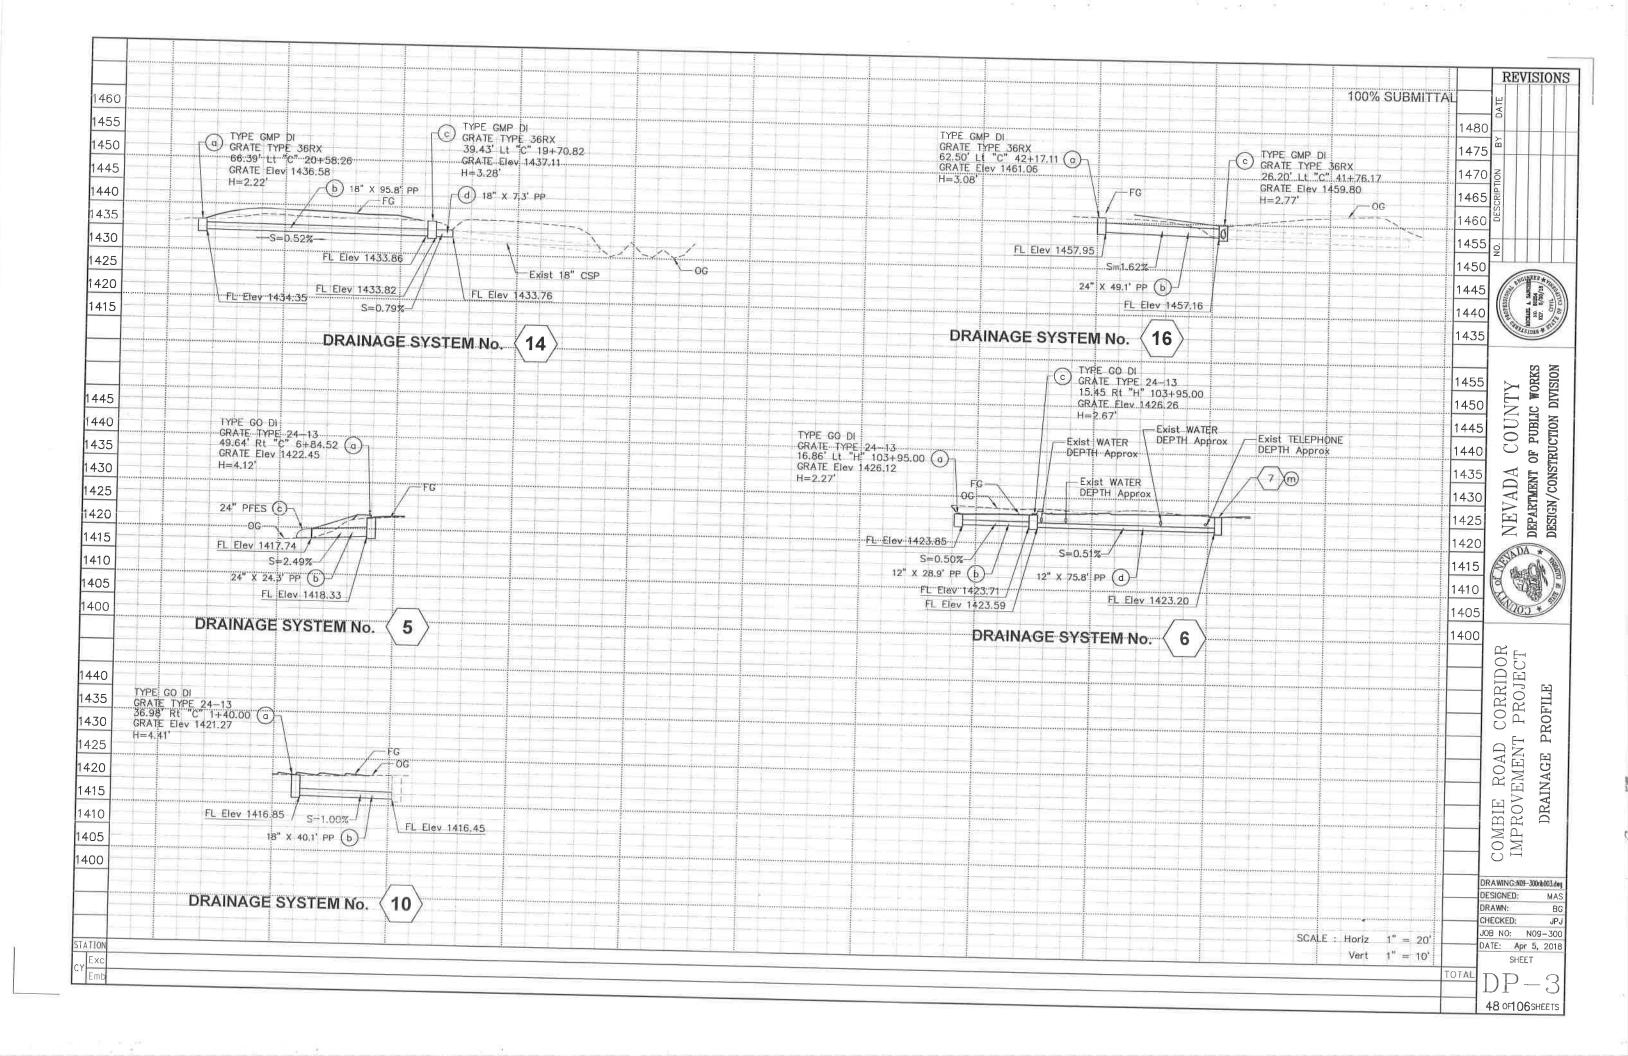

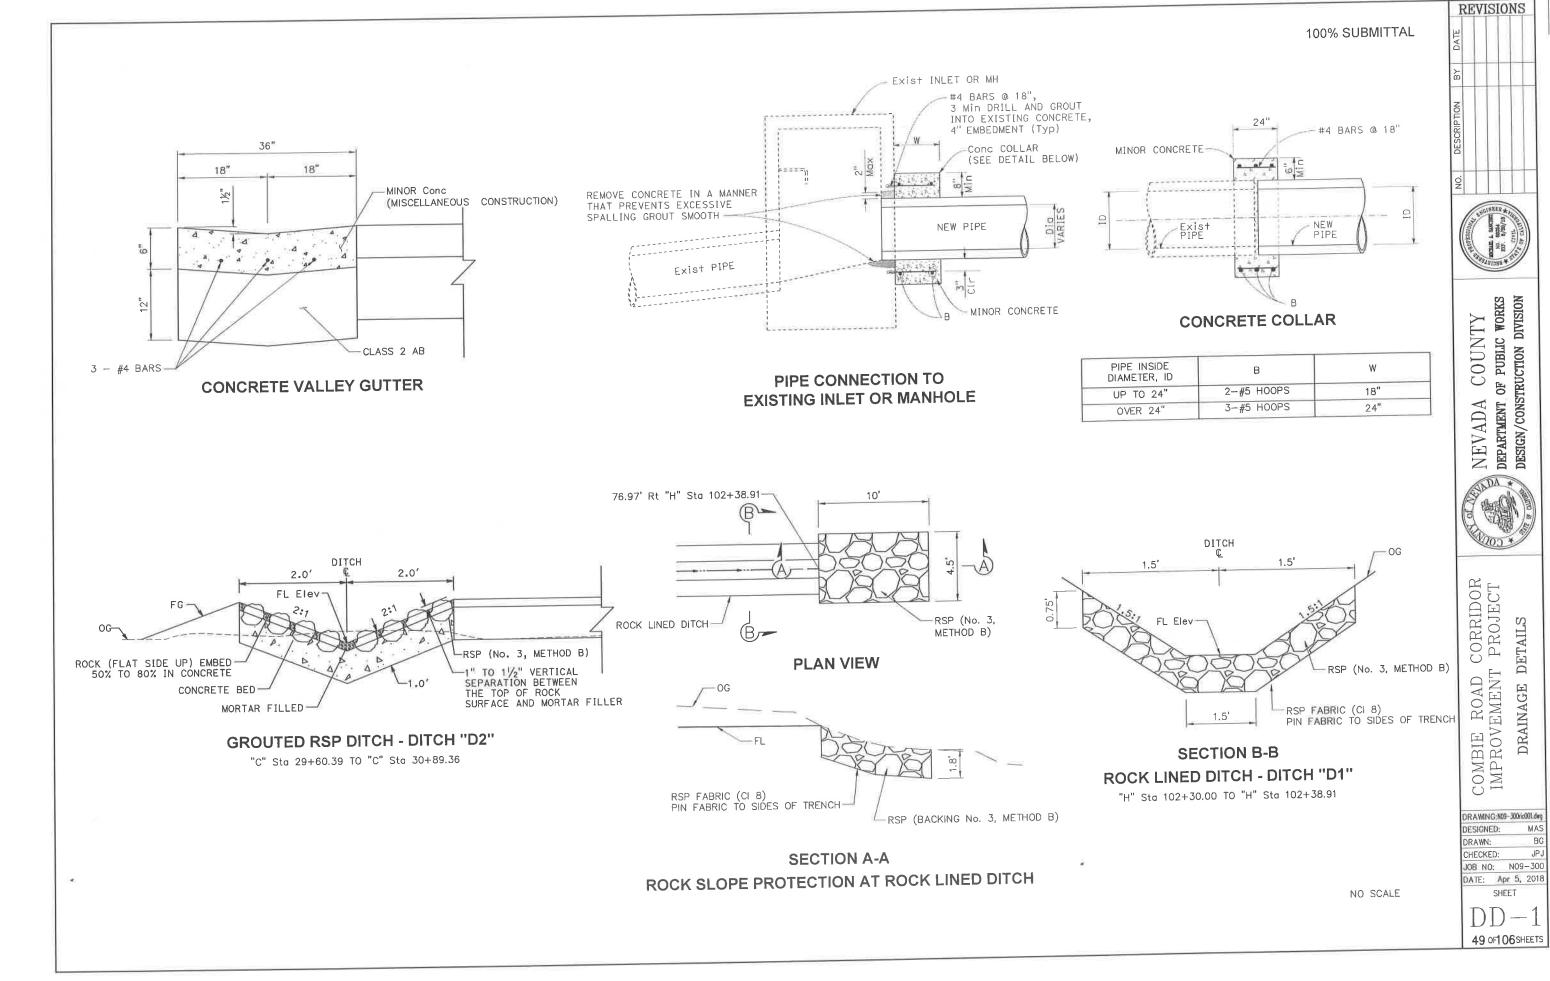



1. FOR MINOR CONCRETE (PIPE ENCASEMENT), SEE "DRAINAGE PROFILE" SHEETS.

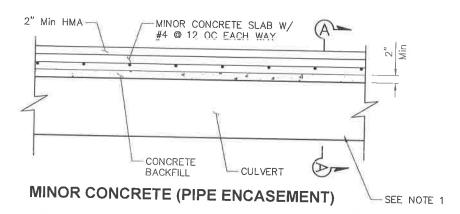

MINOR CONCRETE SLAB W/ #4 @ 12 OC EACH WAY 4" Min (IN LIEU OF HMA & AB SHOWN ON 2" Min HMA TYPICAL SECTIONS) 12" Min Тур CULVERT CONCRETE BACKFILL SAND BEDDING 12" Min Тур **SECTION A-A**

REVISIONS 100% SUBMITTAL



NEVADA COUNTY DEPARTMENT OF PUBLIC WORKS DESIGN/CONSTRUCTION DIVISION




DRAWING:N09-300ric002.dag DESIGNED: DRAWN: CHECKED: JOB NO: N09-300 DATE: Apr 6, 2018 SHEET

CORRIDOR PROJECT COMBIE ROAD CIMPROVEMENT

JPJ 50 OF 106 SHEETS

-REPLACE EXISTING STRUCTURAL SECTION OR MINIMUM OF 4" CLASS 2 AB DEPTH VARIES REFER TO DRAINAGE PROFILES TRENCH BACKFILL 95% RELATIVE COMPACTION IN PIPE ZONE SAND BEDDING-

> TYPICAL TRENCH FOR DRAINAGE PIPE UNDER EXISTING DRIVEWAY OR NATURAL GROUND

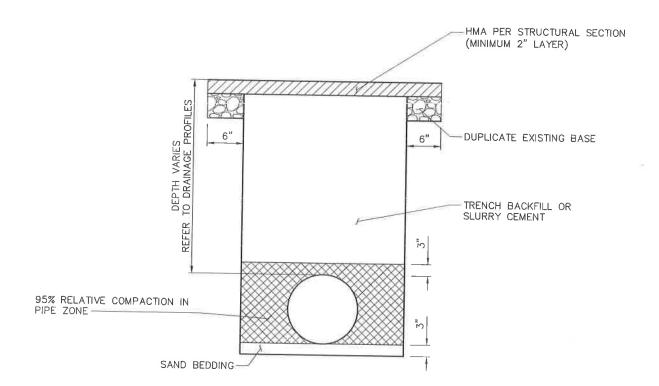

TYPICAL TRENCH FOR DRAINAGE PIPE THROUGH PAVEMENT

NO SCALE

DRAINAGE QUANTITIES

| DRAINAGE SYSTEM | DRAINAGE UNIT No. | LINE | STATION | FFSET | MISCELLANEOUS IRON AND STEEL | HEIGHT OF INLET "H" (N) | MINOR CONCRETE (MINOR STRUCTURE) | 12" PLASTIC PIPE (HDPE) | 18" PLASTIC PIPE (HDPE) | 24" PLASTIC PIPE (HDPE) | 12" PLASTIC FLARED END SECTION (HDPE) | 24" PLASTIC FLARED END SECTION (HDPE) | 36" STEEL FLARED END SECTION | 36" CORRUGATED STEEL PIPE INLET (.064" THICK) | MINOR CONCRETE (PIPE ENCASEMENT) | CONCRETE BACKFILL | REMOVE PIPE | REMOVE INLET | GROUTED RSP DITCH | ROCK SLOPE PROTECTION (BACKING NO.3, METHOD B) | ROCK SLOPE PROTECTION FABRIC (CLASS 8) | DESCRIPTION |
|-----------------|-------------------|-------|-----------|-------|------------------------------|-------------------------|-------------------------------------|-------------------------|-------------------------|-------------------------|---------------------------------------|---------------------------------------|------------------------------|---|----------------------------------|-------------------|-------------|--------------|-------------------|---|---|--------------------|
| | | | | P | LB | LF | CY | LF | LF | LF | EA | EA | EA | LF | CY | CY | LF | EA | LF | CY | SQYD | TYPE GO DI |
| | _ | 11011 | 4,00.00 | Lt | 188 | | 1.14 | | | | | | | | | | | | | | | 1112 |
| 1 1 | a b | "C" | 1+00.02 | | 100 | | | | 17.1 | | | | | ļ | | | | 1 | | 1 | | REMOVE INLET |
| | c | | | | | | | | | | | _ | | | | - | | | | | | |
| | | | | | | | | | | | | | - | | | | | | | | | TYPE GO DI |
| 1 2 | | | 2+50.86 | Lt | 188 | | 0.99 | 44.3 | | | | | | 3 | 1.9 | 3.0 | | | | | | TYPE GO DI |
| _ | Ь | - | 2.01.96 | Lt | 188 | - | 1.06 | 44.0 | | | | | | | | | | | | - | | 111 = 40 = 1 |
| _ | C | | 3+01.86 | LI | 100 | | 1.00 | 39.1 | | | | | | | 1.2 | 2.0 | | - | | | | 12" PFES |
| - | d e | | | | | | | | | | 11 | | | | | | | 1 | | - | 1 | REMOVE INLET |
| - | f | | | | | | | | | | | | - | | | | 74.0 | - | 1 | | | REMOVE PIPE, L=74' |
| _ | g | | | | | | | | | | | | | | - | | 0.5144 | | | | | TYPE G1 DI |
| | h | | 3+12.18 | Rt | 188 | | 1.20 | | | | | | - | | | | | | | | | |
| | ı | | | | | | | 56.2 | | 1 | | | | | | | | | | | | TYPE GO DI |
| | | | | | 100 | - | 1.23 | | | | | | | | | | | | | - | | TIFE GO DI |
| -1 3 | | "C" | 3+67.42 | Rt | 188 | | 1.23 | 8.9 | | | | | | | | | | | V | - | + | TYPE GO DI |
| _ | b | | 3+63.77 | Rt | 188 | | 1.22 | 0.0 | | | | | | | | | | - | | - | + | |
| - | d | "C" | 3+03.11 | - INI | 100 | 1 | | 21.2 | | | | | | | | | | | | 1 | | |
| - | - - | | | 1 | | | | | | | | | | - | | - | - | | | | | TYPE GO DI |
| 1 4 | 4 a | . Hm | 102+35.38 | Lt | 188 | | 1.55 | | | | | | - | | | | 1 | | | | | |
| | b | | | | | | | | | 20.7 | | 1 | | - | | | | | | | | 24" PFES |
| | С | | | | | | | | | | | ' | | | | | | | | | - | TYPE GO DI |
| | | V- 10 | | | 400 | - | 1.53 | | | | | | | | | | | | | | | TIPE GO DI |
| -1 : | _ | "C" | 6+84,52 | Rt | 188 | | 1,00 | | | 24.3 | | | | | | | - | - | - | - | | 24" PFES |
| | t | _ | | | | | | | | | | 1 | | | | | | - | | | 1 | |
| | C | - | | | | | | | | | | | | | | - | - | | | | | TYPE GO DI |
| -1 | 6 = | "H" | 103+91,21 | Lt | 188 | | 1.08 | | | | | - | | | + | + | | | | | | |
| | | | | | | | | 28.9 | | | - | | - | - | | | | | | | | TYPE GO DI |
| | | : "H" | 103+90.86 | Rt | 188 | | 1.18 | 75.0 | | • | | - | + | 1 | | | | | | | | |
| -1 | (| 1 | | | | | _ | 75.8 | - | | | | 1 | | | | | | | | | |
| | | | | | | - | | - | | | | | | | | | | | | | | |
| | | | | | 1 | | | | | 45.0 | | | | | 3.1 | 5.0 | 74.0 | 2 | | 1 | TI. | |

(N) NOT A SEPARATE PAY ITEM, FOR INFORMATION ONLY.

REVISIONS





NEVADA COUNTY DEPARTMENT OF PUBLIC WORKS DESIGN/CONSTRUCTION DIVISION



COMBIE ROAD CORRIDOR IMPROVEMENT PROJECT DRAINAGE QUANTITIES

DRAWING:N09-300rid001.dwg DESIGNED: DRAWN: CHECKED: JOB NO: NO9-300 DATE: Apr 5, 2018

SHEET

DRAINAGE QUANTITIES

| | T | | | | | | | | | | | 7 | NAGE Q | UANTI I | 1123 | - | | | | | | | |
|---------------------|-----------------|-------------------|-----|----------|--------|------------------------------|---------------------------|----------------------------------|---------------------------|---------------------------|---------------------------|---|---|------------------------------|---|----------------------------------|-------------------|-------------|--------------|-------------------|--|---|--------------------------------|
| DRAINAGE PLAN SHEET | DRAINAGE SYSTEM | DRAINAGE UNIT No. | | STATION | OFFSET | MISCELLANEOUS IRON AND STEEL | 국 HEIGHT OF INLET "H" (N) | MINOR CONCRETE (MINOR STRUCTURE) | 규 12" PLASTIC PIPE (HDPE) | 규 18" PLASTIC PIPE (HDPE) | 규 24" PLASTIC PIPË (HDPE) | 7 12" PLASTIC FLARED END SECTION (HDPE) | 第 24" PLASTIC FLARED END SECTION (HDPE) | 36" STEEL FLARED END SECTION | 36" CORRUGATED STEEL PIPE INLET (.064" THICK) | MINOR CONCRETE (PIPE ENCASEMENT) | CONCRETE BACKFILL | REMOVE PIPE | REMOVE INLET | GROUTED RSP DITCH | ROCK SLOPE PROTECTION (BACKING NO.3, METHOD B) | ROCK SLOPE PROTECTION FABRIC (CLASS 8) | DESCRIPTION |
| D-3 | 7 | a b | "C" | 16+67.44 | Lt | 188 | | 1.68 | | | | | | EA | LF | CY | CY | LF | EA | LF | CY | SQYD | |
| | | C | "c" | 14+85.22 | Lt | 188 | | 1.57 | | | 172.9 | | | | | | | | | | | | TYPE GO DI |
| | | d e | *C" | 13+36.08 | | | | | | | 141.1 | | | | | | | | | | | | TYPE GO DI |
| | | f | | 10730,00 | Lt | 188 | - | 1.41 | | | 90.2 | | | | | | | | | | | | TYPE GO DI |
| | | g h | "C" | 12+50.00 | Lt | 188 | | 1.31 | | | 80.2 | | | | | 5.9 | 16.4 | | | | | | |
| | _ | - | "C" | 10+77.74 | Lt | 188 | | 1.44 | | | 167.8 | | | | | 1.5 | 4.1 | | | | | | TYPE GO DI |
| - | | j k | "C" | 9+62.64 | | | | | | | 116.9 | | | | | | | | | | | | TYPE GO DÍ |
| | | I | | 9TUZ.04 | Lt | 188 | | 1.49 | | | 407.0 | | | | | | | | | | | | TYPE GO DI |
| | _ | | "C" | 8+31.24 | Lt | 188 | | 1.34 | | | 137.3 | | | | | | | | | | | | I THE GO DI |
| | - | n o | | | | | | | | | 64.8 | | | | | | | | | | | | TYPE GO DI |
| | | р | | | | | | | | | | | | | | | | | 1 | | | | REMOVE INLET |
| D-2 | 8 | а | "C" | 8+29.85 | Rt | 188 | | 1.55 | | | | | | | | | | 61 | | | | | REMOVE PIPE, L=61' |
| D-2 | 9 | a | | | | | | | | | | | | | | | | | | | | | TYPE GO DI |
| | | | | | | | | | | | | | | | | | | 40 | | | | | REMOVE PIPE, L=40' |
| D-1 | | a ' | "C" | 1+40.00 | Rt | 188 | | 1.61 | | | | | | | | | | - | | | | | |
| | | | | | | | | | | 40.1 | | | | | | | | | | | | | TYPE GO DI |
| 0-2 | | _ | | | | | | | | | | | | 1 | | | | | | | | | |
| | | , | - | | | | | | | | | | | | | | | 77 | | | | | |
| 0-2 | | _ | 'C" | 12+80.00 | Rt | 215 | 3.4 | 1.36 | | | | | | | | | | | | | | | REMOVE PIPE, L=77' |
| + | - k | _ | - | | | | | | 197.7 | | | | | | 3.9 | | | | | | | | TYPE GMP DI |
| 0-2 | | | | | | | • | | | | | 1 | | | | | | | | - 4 | | | 400 |
| | | | | | | | | | | | | | | | | | | 30 | | | | | 12" PFES REMOVE PIPE, L=30' |
| BTOT | 8.1 | | | | | | | | | | - 17 | | | 1 | | | | | | | | - 1 | REINDAL BIRE 1=30. |

REVISIONS







COMBIE ROAD CORRIDOR IMPROVEMENT PROJECT DRAINAGE QUANTITIES

DRAWING:N09-300rid002.dwg DESIGNED: MAS BG CHECKED: JPJ JOB NO: N09-300 DATE: Apr 5, 2018 SHEET

NEVADA COUNTY DEPARTMENT OF PUBLIC WORKS DESIGN/CONSTRUCTION DIVISION

COMBIE ROAD CORRIDOR IMPROVEMENT PROJECT

| DRAWNG:N09- | 300rid003.dwg |
|-------------|---------------|
| DESIGNED: | MAS |
| DRAWN: | BG |
| CUECKED. | ID I |

CHECKED: JPJ JOB NO: NO9-300 DATE: Apr 5, 2018


SHEET


53 OF 106 SHEETS

DRAINAGE QUANTITIES

| DRAINAGE PLAN SHEET | DRAINAGE SYSTEM | DRAINAGE UNIT No. | LINE | STATION | OFFSET | MISCELLANEOUS IRON AND STEEL | HEIGHT OF INLET "H" (N) | MINOR CONCRETE (MINOR STRUCTURE) | 기 12" PLASTIC PIPE (HDPE) | 게 18" PLASTIC PIPE (HDPE) | T 24" PLASTIC PIPE (HDPE) | 12" PLASTIC FLARED END SECTION (HDPE) | 24" PLASTIC FLARED END SECTION (HDPE) | 36" STEEL FLARED END SECTION | 36" CORRUGATED STEEL PIPE INLET (.064" THICK) | MINOR CONCRETE (PIPE ENCASEMENT) | CONCRETE BACKFILL | T REMOVE PIPE | REMOVE INLET | F GROUTED RSP DITCH | ROCK SLOPE PROTECTION (BACKING NO.3, METHOD B) | ROCK SLOPE PROTECTION FABRIC (CLASS 8) | DESCRIPTION |
|---------------------|-----------------|-------------------|-------|---------|--------|------------------------------|-------------------------|----------------------------------|---------------------------|---------------------------|---------------------------|---------------------------------------|---------------------------------------|------------------------------|---|----------------------------------|-------------------|---------------|--------------|---------------------|---|---|--------------|
| D-3 | 14 | a | - | | | 215 | 2.2 | 01 | | LI | LI | LA | LA | LA | 2.7 | 01 | 01 | | LA | | 01 | 00(1) | TYPE GMP DI |
| | | b | | | | | | | | 95.8 | | | | | | | | | | | | | |
| | _ | С | | | | 215 | 3.3 | | | | | | | | 3.8 | | | | | | | | TYPE GMP DI |
| | | d | _ | | | | | | | 7.3 | | | | | | | | | | | | | |
| D-4 | 15 | а | | | | | | | | | | | | | | | | | 1 | | | | REMOVE INLET |
| D-6 | 16 | a | - | | | 215 | 3.1 | - | | | | | | | 3.6 | | | | | | | | TYPE GMP DI |
| D-0 | | b | - | | | 210 | 3.1 | | | | 49.1 | | | | 0.0 | | | | | | | | THE GIVE DI |
| | - | С | | | | 215 | 2.8 | | | | | | | | 3.3 | | | | | | | | TYPE GMP DI |
| | | | | | | | | | | | | | | | | | | | | | | | |
| - | - | + | | | | | | - | | | | - | | | | | | | | | 8.3 | 45 | DΠCH "D1" |
| | | | | | | | | | | | | | | | | | | | | 130 | | | D(TCH "D2" |
| | | | | | | | | | | | | | | | | | | | | | | | |
| SUBTO | TAL FI | ROM | SHEE | T DQ-3 | | 860 | | | | 103,1 | 49.1 | | | | 13.4 | | | | 1 | 130 | 8.3 | 45 | |
| SUBTO | TAI F | ROM | ISHEE | T DO-1 | | 1880 | | 12.18 | 274.4 | 17.1 | 45,0 | 1 | 2 | | | 3.1 | 5.0 | 74 | 2 | | | | |
| SUBTO | | | | | | 1907 | | 14.76 | 197.7 | 40.1 | 881.0 | 1 | | 1 | 3.9 | 7.4 | 20.5 | 208 | 1 | | | | |
| | | | | | | | | | | | | | | | | | | | | | | | |
| | | | | | | | | | | | | | | | | | | | | 100 | | | |
| TOTAL | | | | | | 4647 | | 26.94 | 472.1 | 160.3 | 975.1 | 2 | 2 | 1 | 17.3 | 10.5 | 25.5 | 282 | 4 | 130 | 8.3 | 45 | |

⁽N) NOT A SEPARATE PAY ITEM, FOR INFORMATION ONLY.

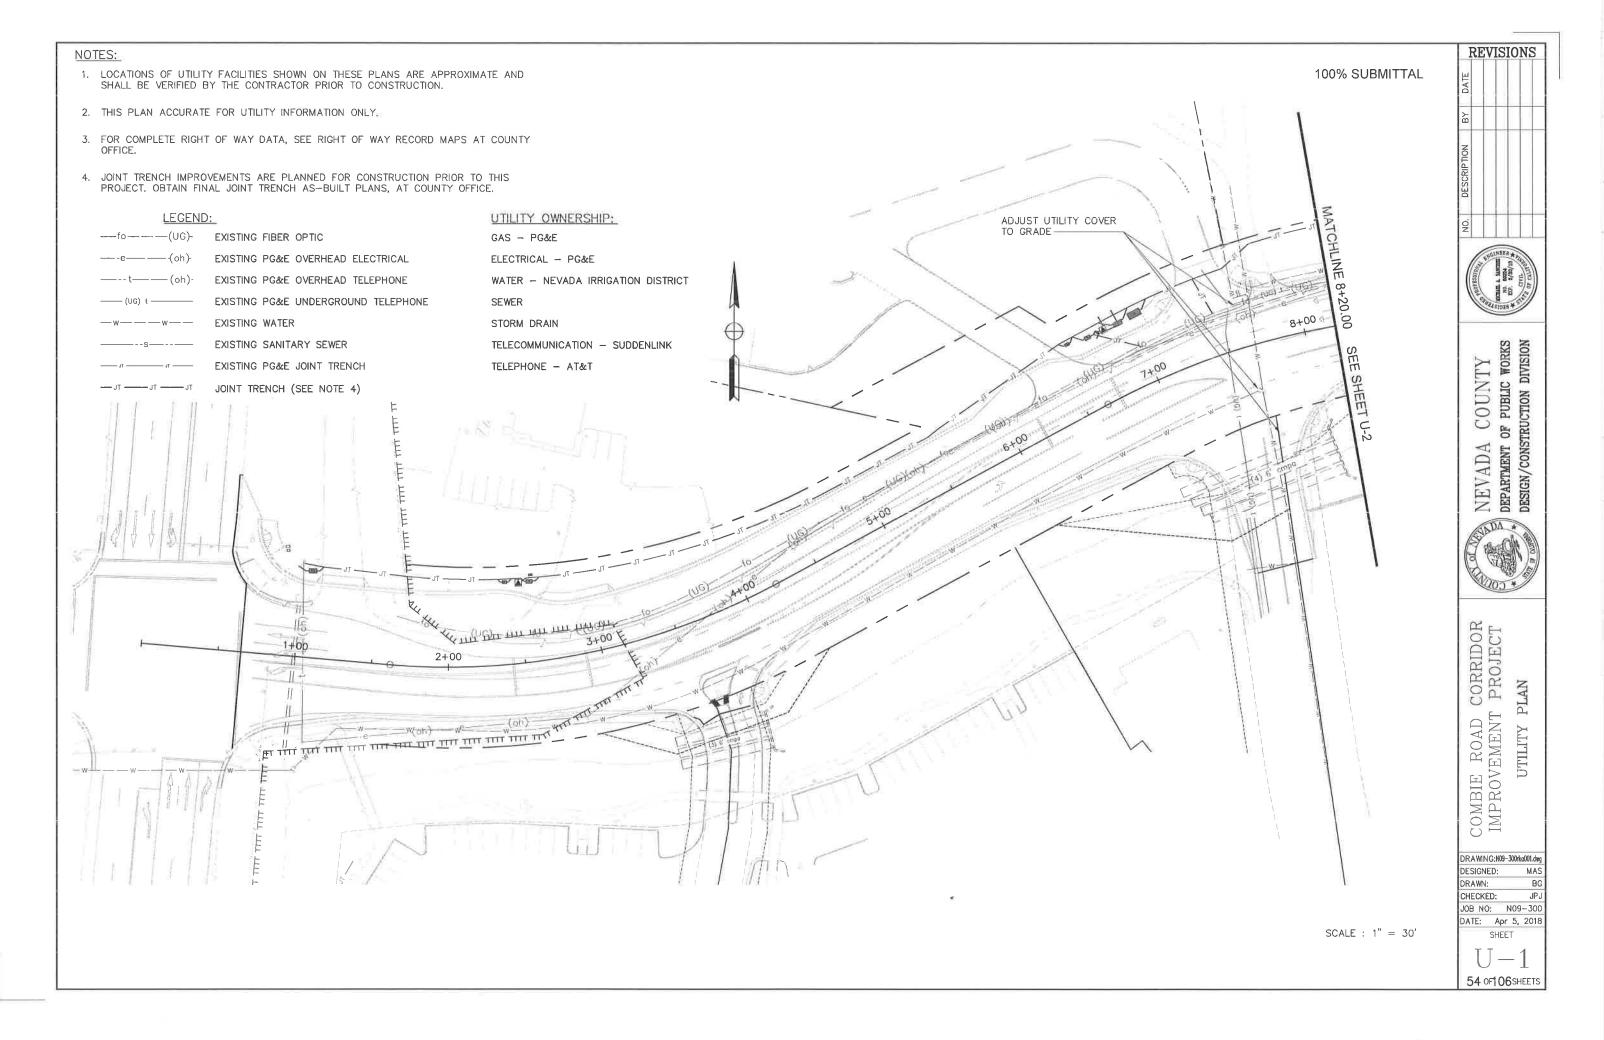

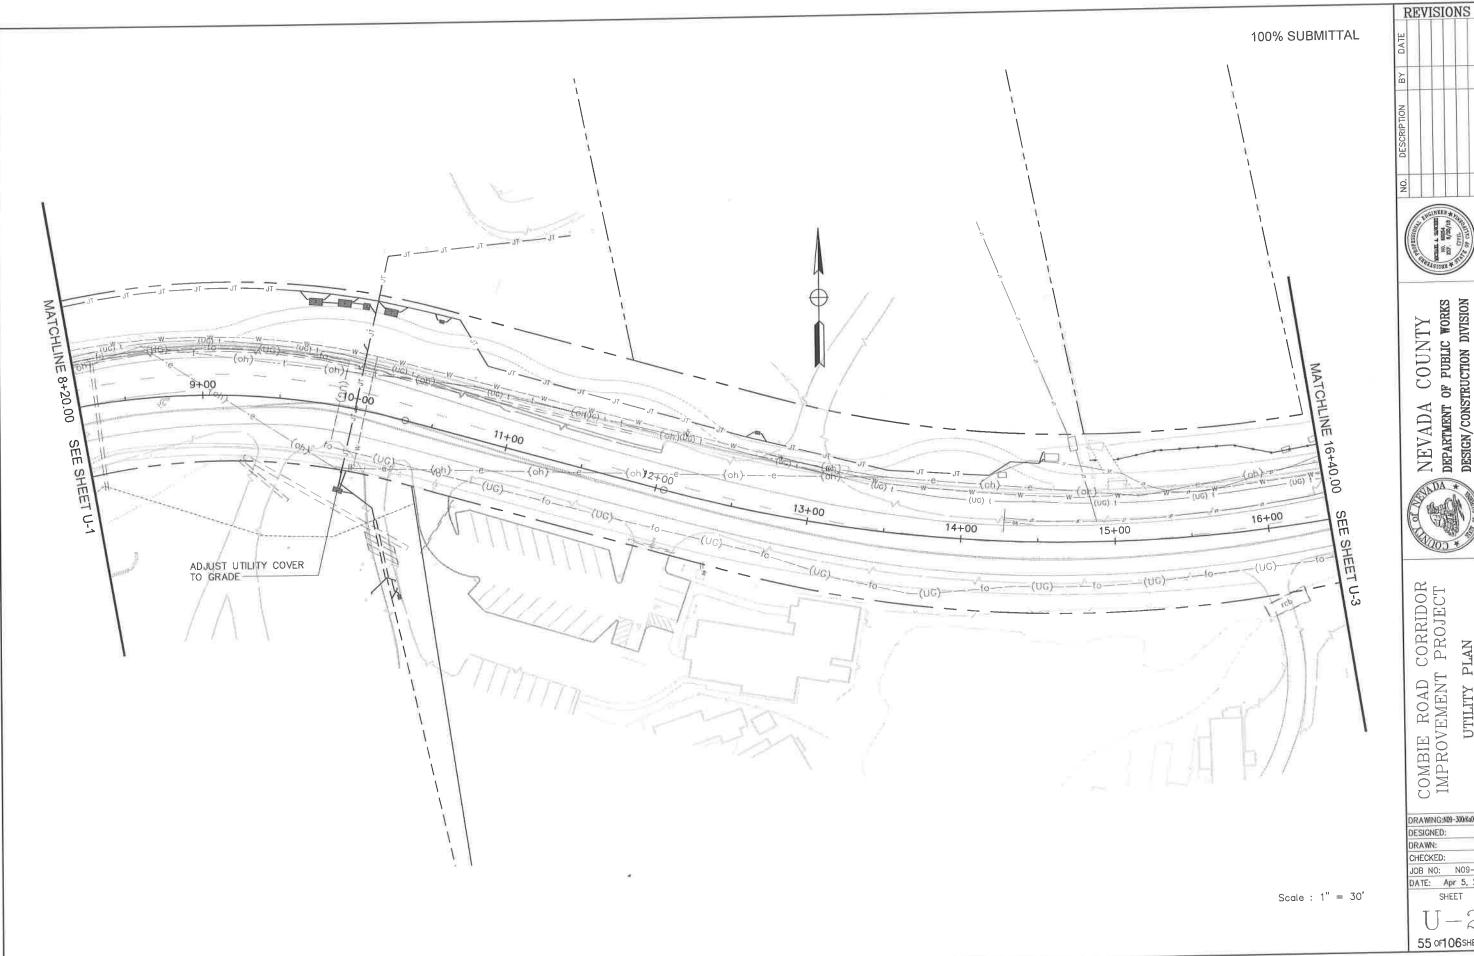


NEVADA COUNTY DEPARTMENT OF PUBLIC WORKS DESIGN/CONSTRUCTION DIVISION

UTILITY PLAN

DRAWING:N09-300rKo002.dug DESIGNED: MAS BG JPJ

CHECKED: JOB NO: N09-300 DATE: Apr 5, 2018 SHEET

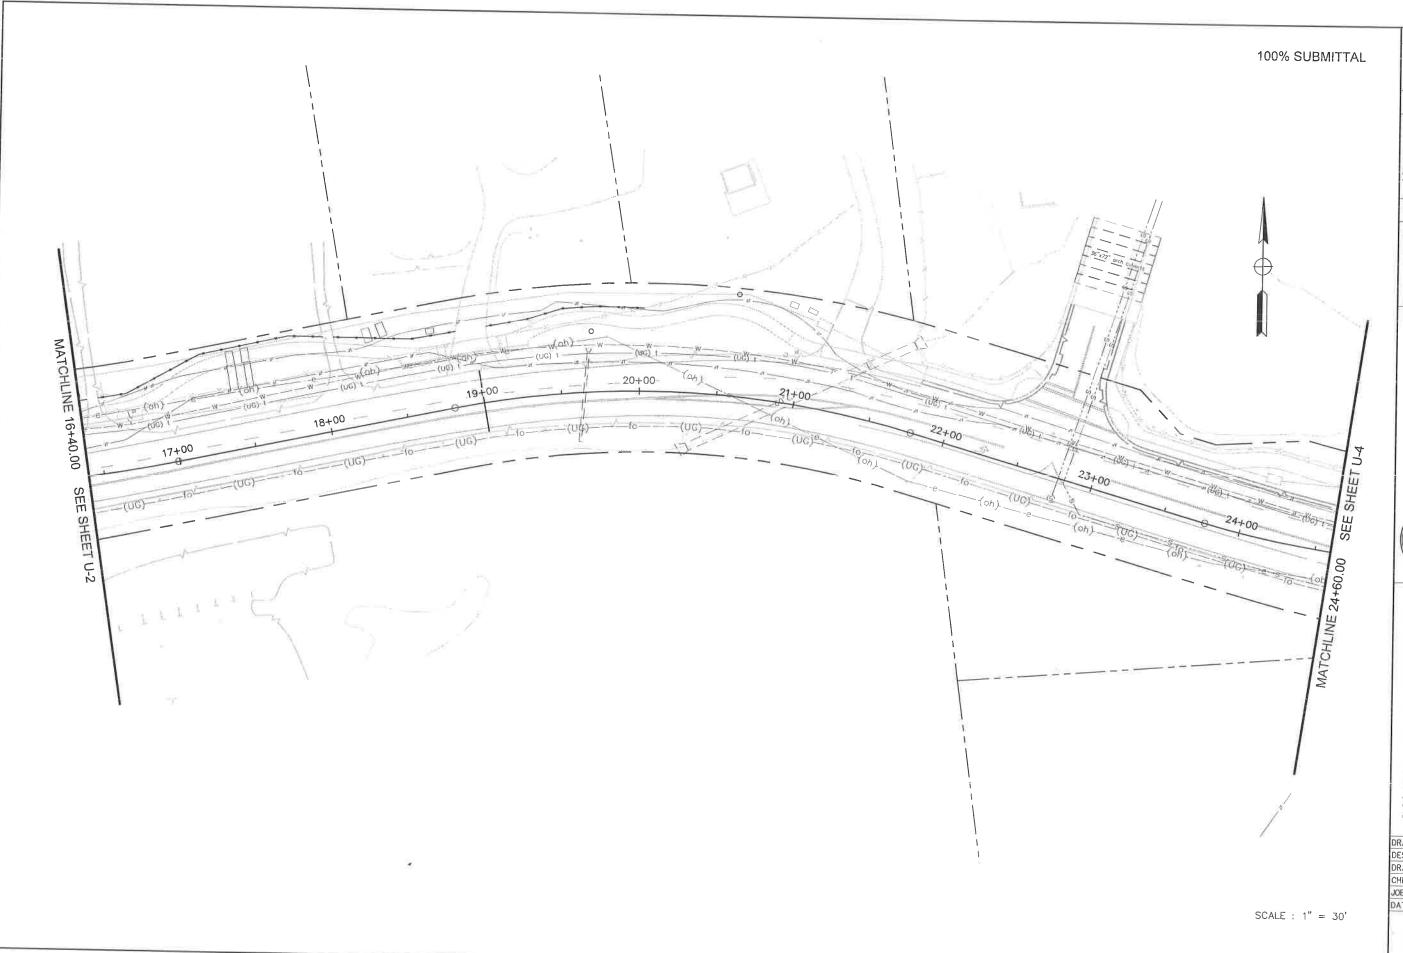


NEVADA COUNTY
DEPARTMENT OF PUBLIC WORKS
DESIGN/CONSTRUCTION DIVISION

REVISIONS

N PER DES

COMBIE ROAD CORRIDOR IMPROVEMENT PROJECT UTILITY PLAN

DRAWING:N09-300hail03.dwg
DESIGNED: MAS
DRAWN: BG
CHECKED: JPJ
JOB NO: N09-300
DATE: Apr 5, 2018
SHEET

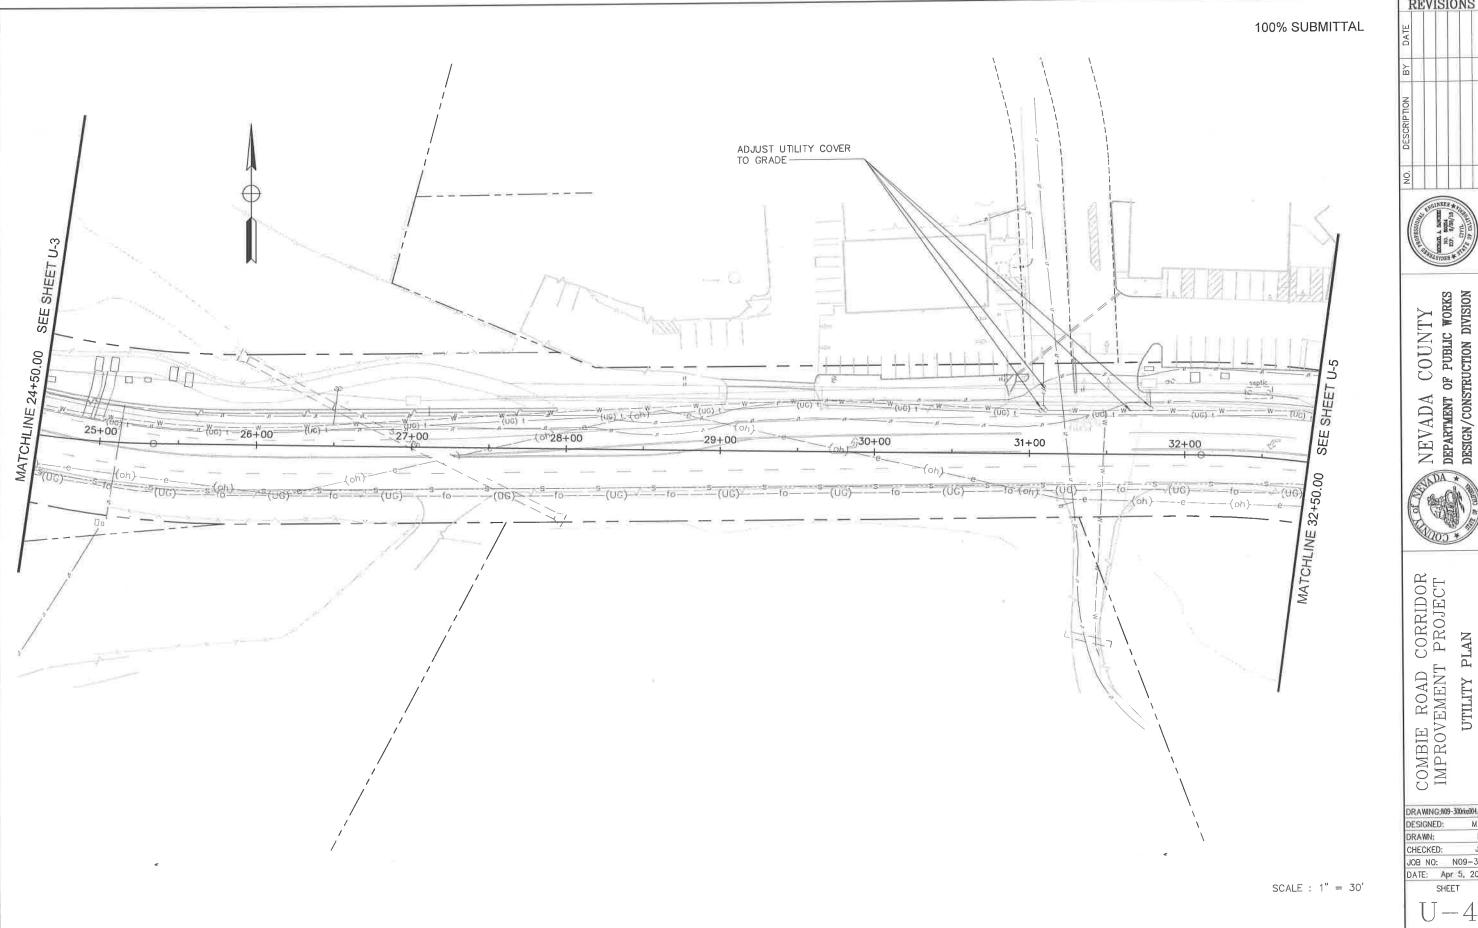


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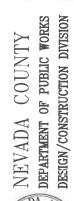
COMBIE ROAD CORRIDOR IMPROVEMENT PROJECT UTILITY PLAN

DRAWING:N09-300rka004.deg DESIGNED: MAS JPJ CHECKED: JOB NO: N09-300 DATE: Apr 5, 2018

SHEET



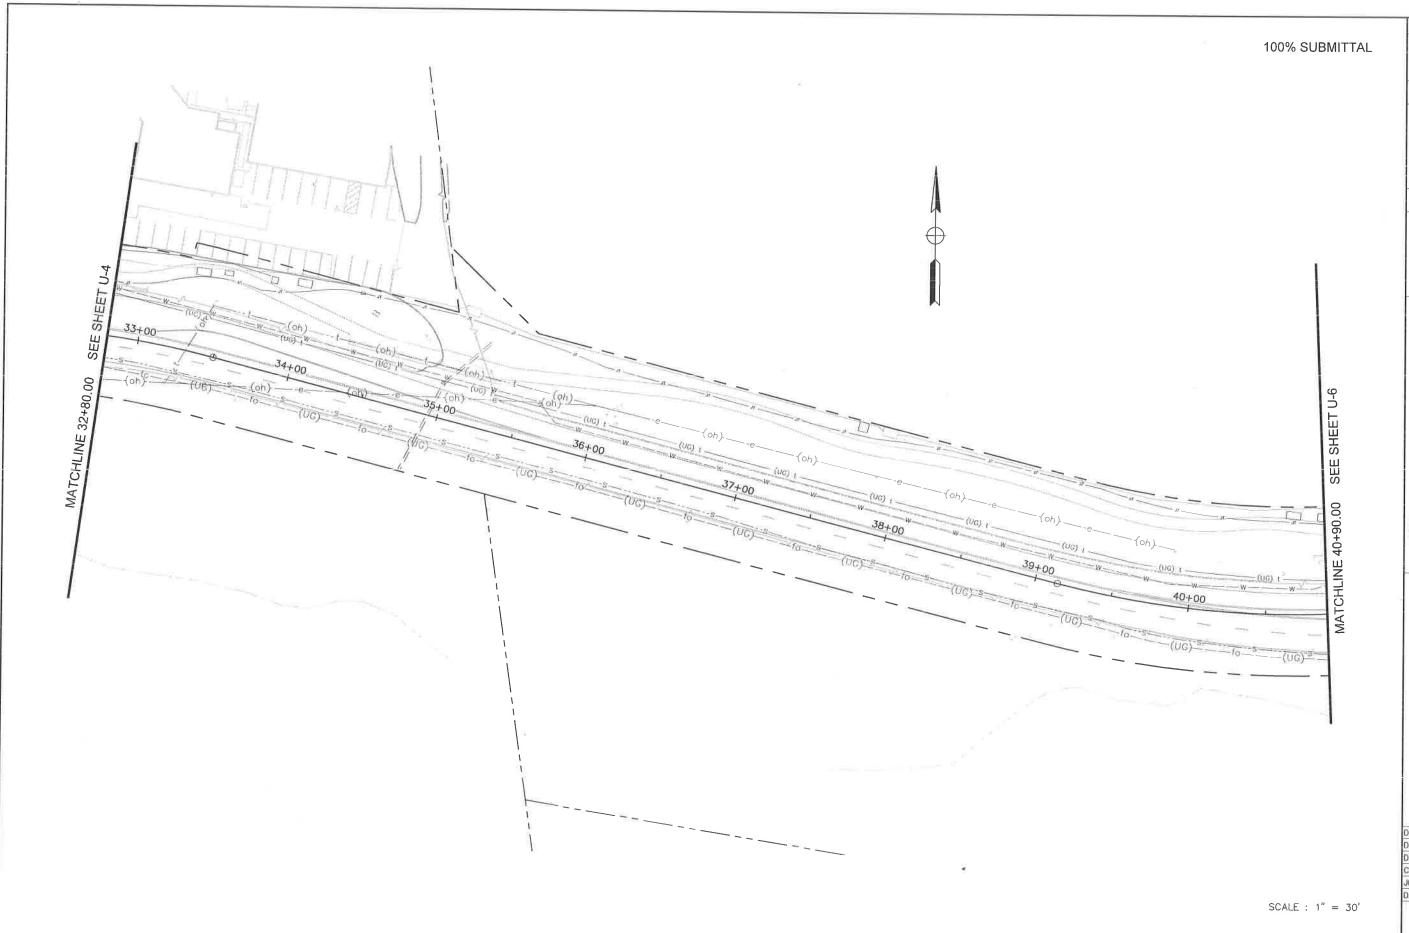





COMBIE ROAD CORRIDOR IMPROVEMENT PROJECT UTILITY PLAN


DRAWING:N09-300rka005,dag DESIGNED: MAS DRAWN: CHECKED: JOB NO: NO9-300 DATE: Apr 5, 2018 SHEET U - 5



COMBIE ROAD CORRIDOR IMPROVEMENT PROJECT UTILITY PLAN

DRAWING:N09-300Hab06,dwg DESIGNED: MAS DESIGNED: BG CHECKED: JPJ JOB NO: NO9-300

> SHEET **59** of **106** SHEETS

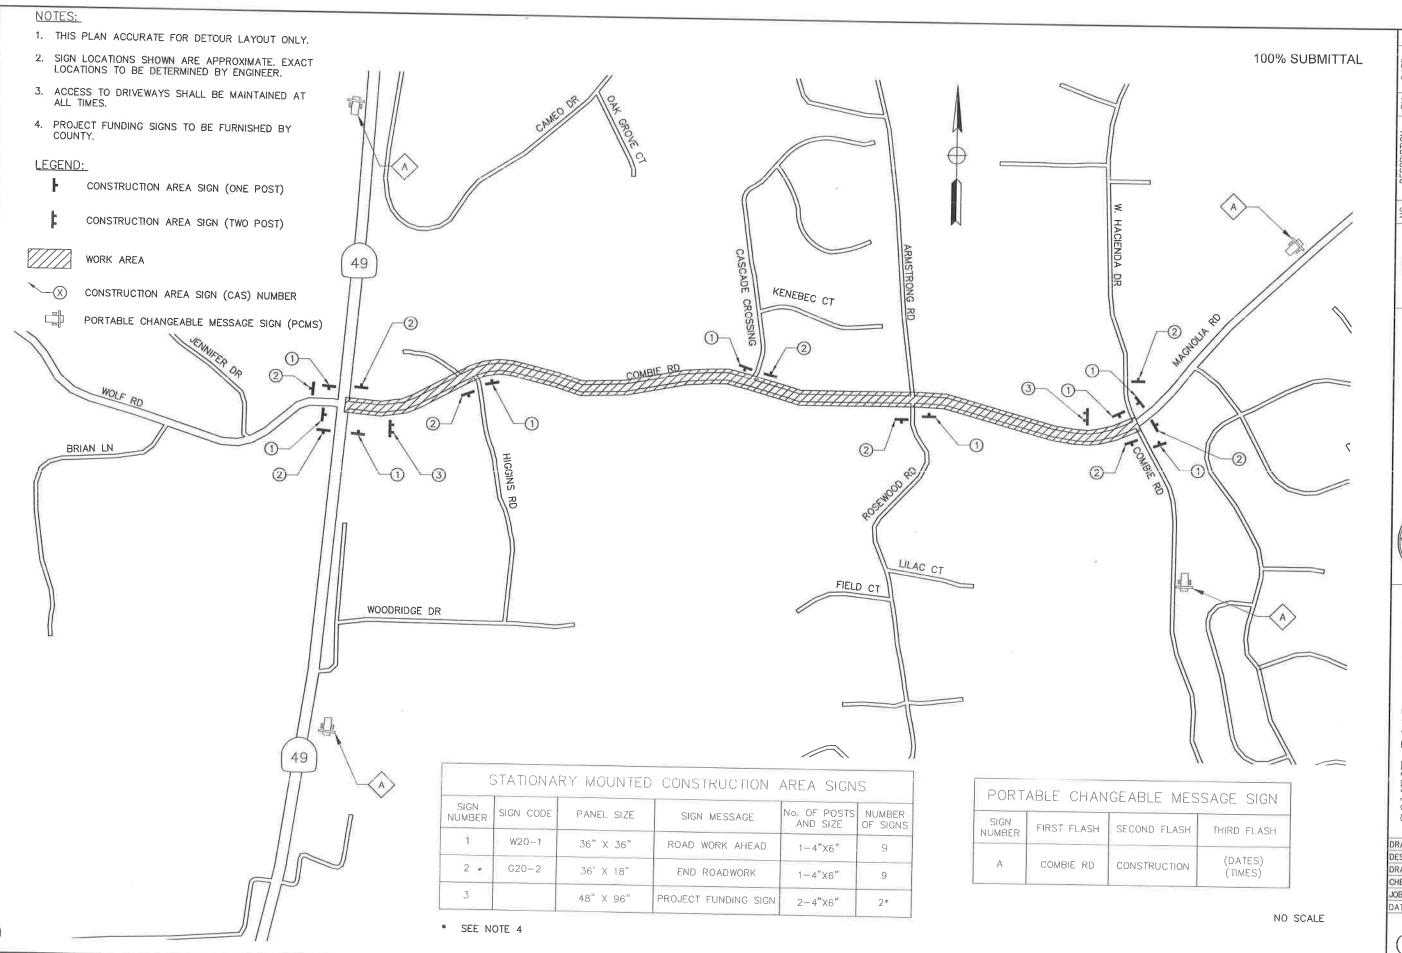

NO. DESCRIPTION BY DATE




NEVADA COUNTY
DEPARTMENT OF PUBLIC WORKS
DESIGN/CONSTRUCTION DIVISION


DOR COLLEGE


COMBIE ROAD CORRIDOR IMPROVEMENT PROJECT CONSTRUCTION AREA SIGNS


DRAWING:N09-3001a001.dag
DESIGNED: MAS
DRAWN: BG
CHECKED: JPJ
JOB NO: N09-300
DATE: Apr 5, 2018
SHEET


CS-1 60 of 106 sheets

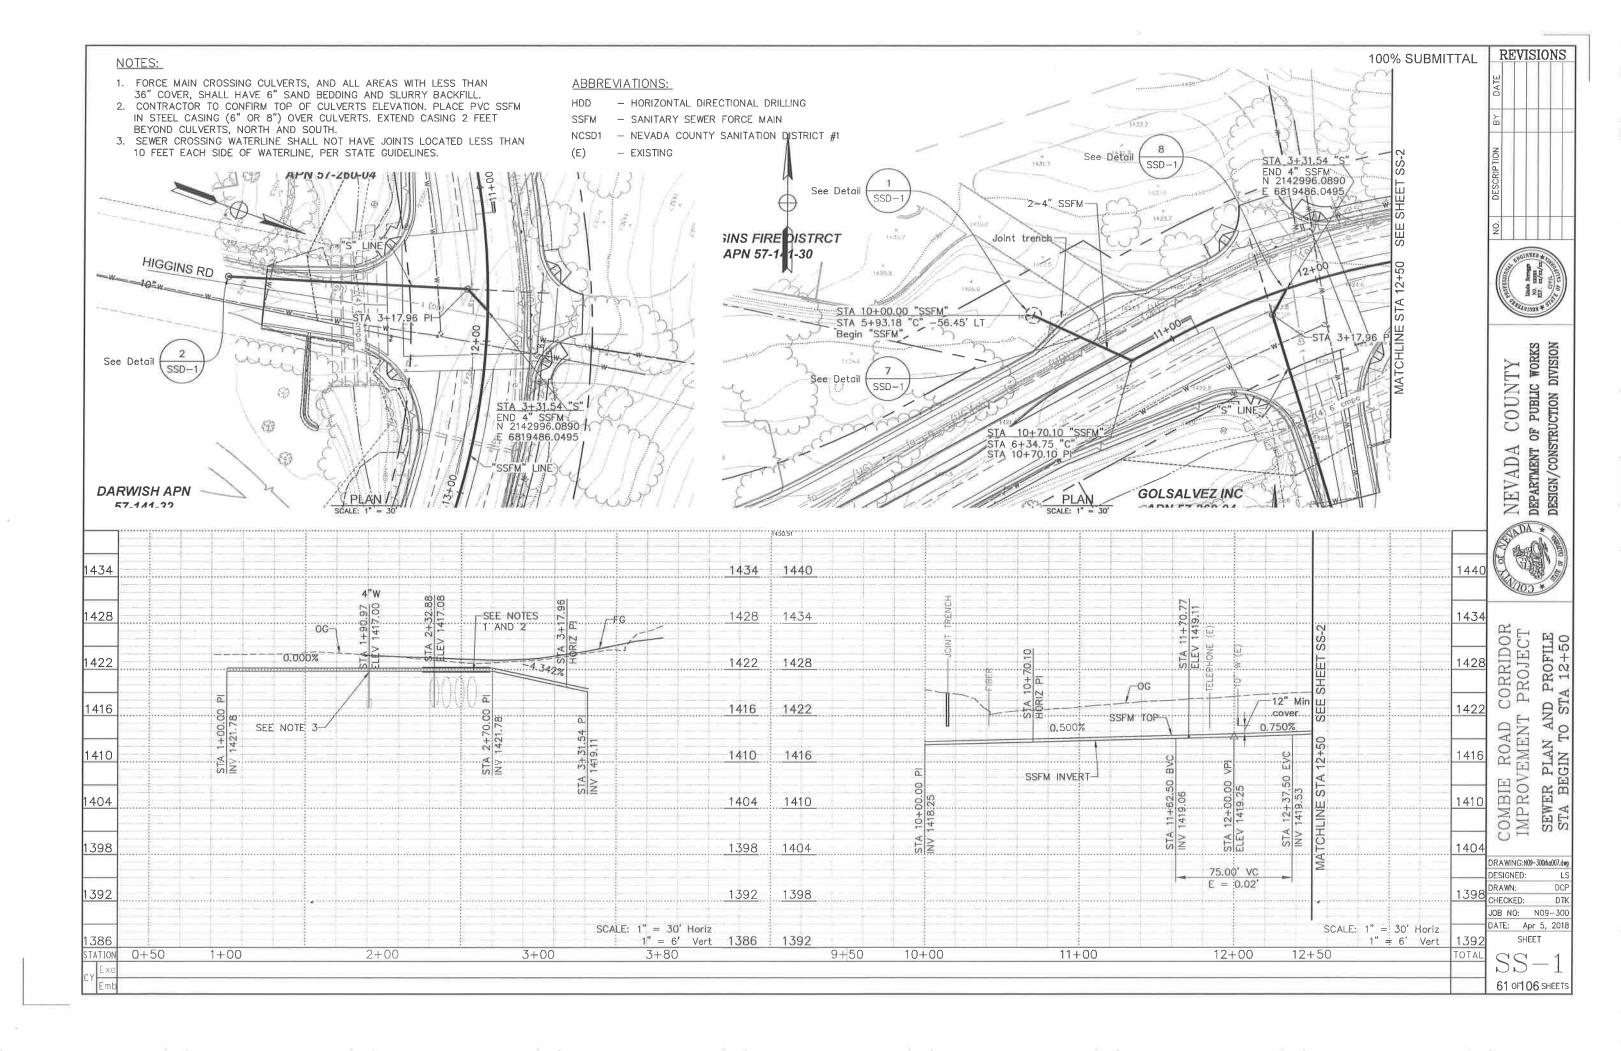


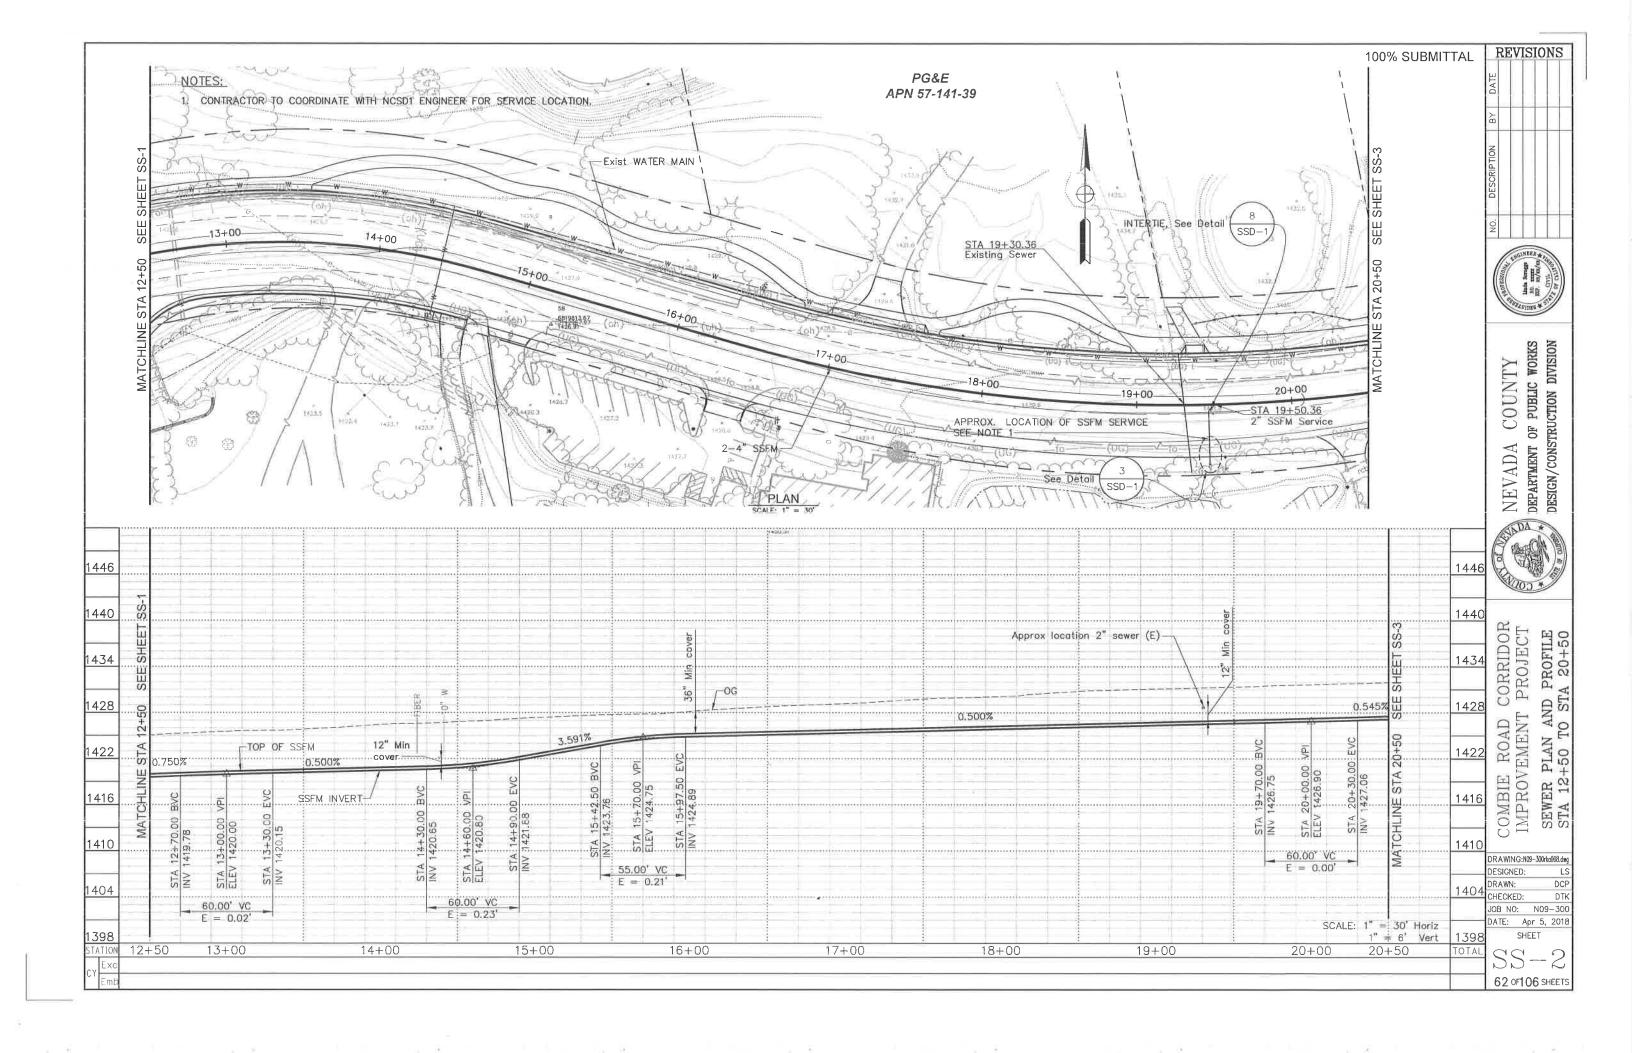

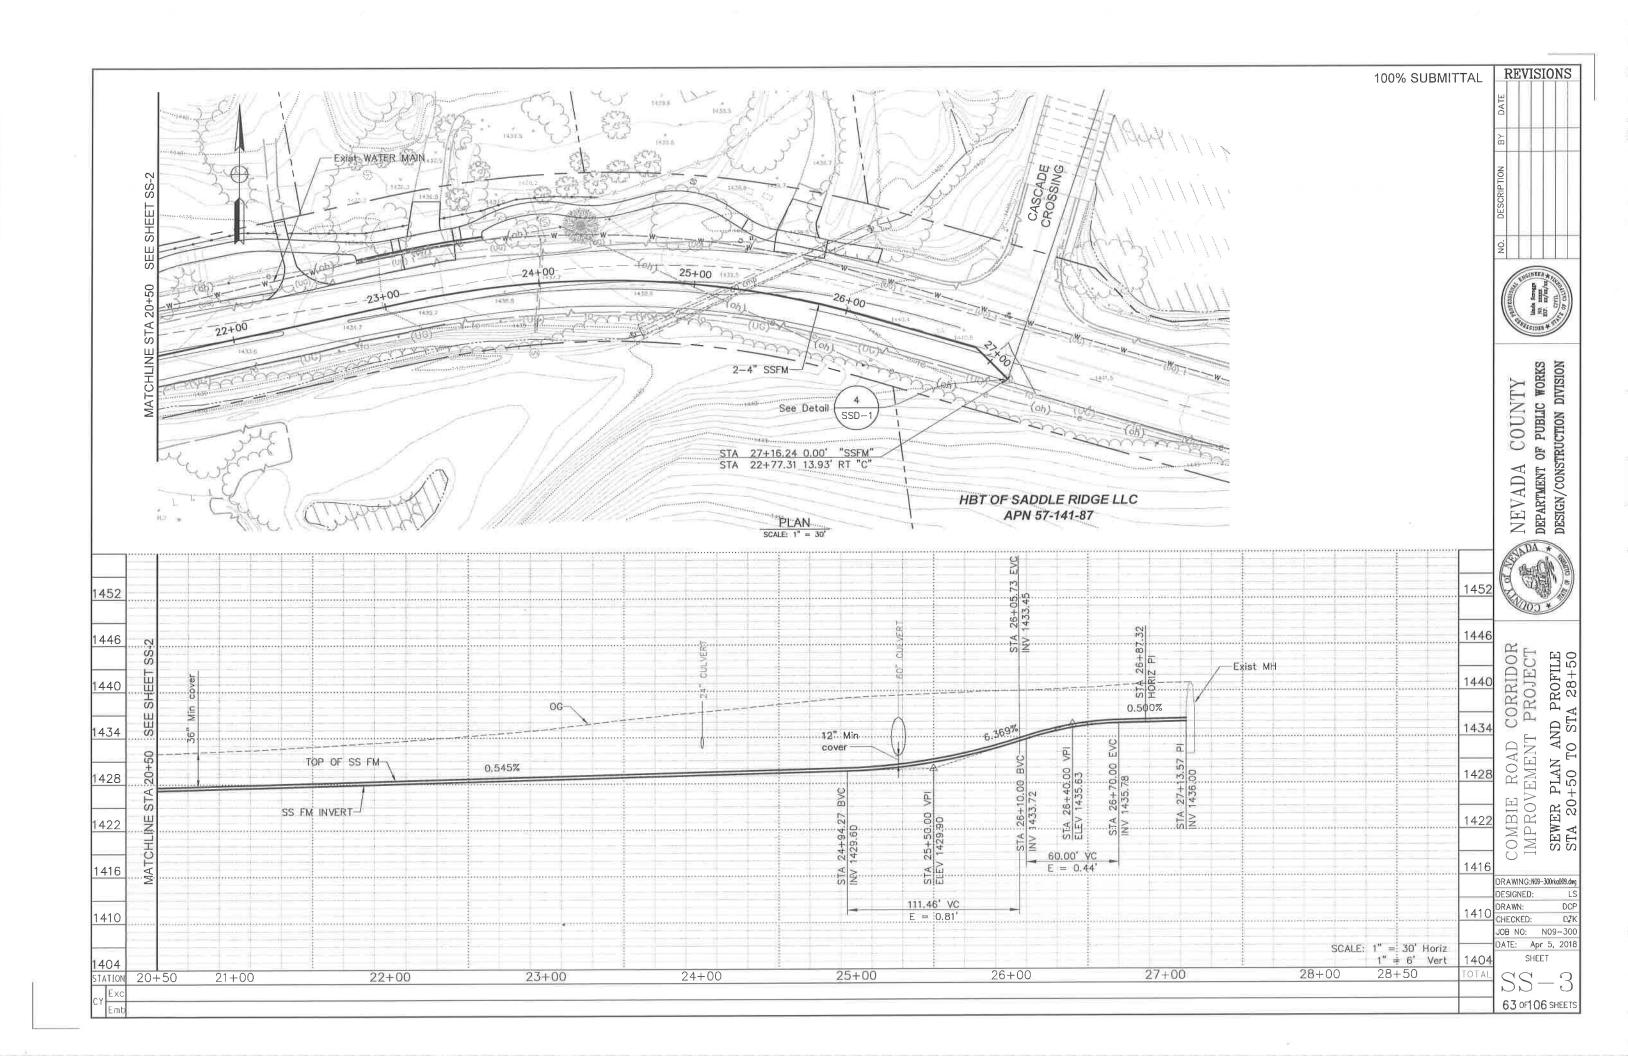

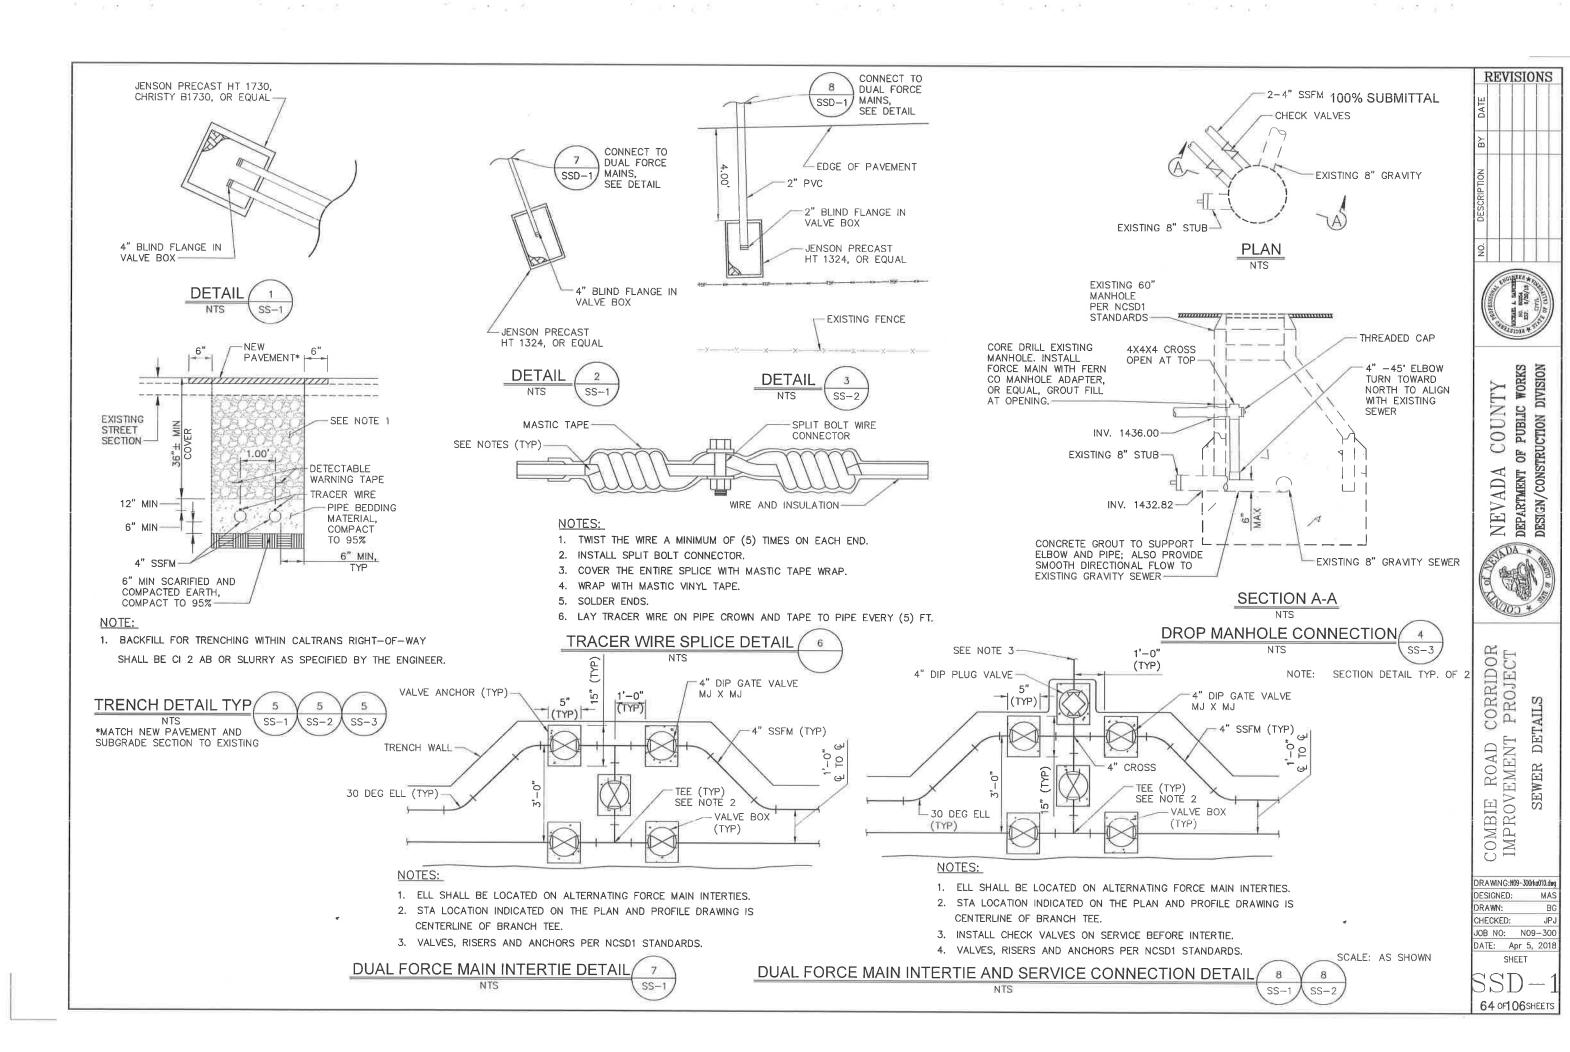

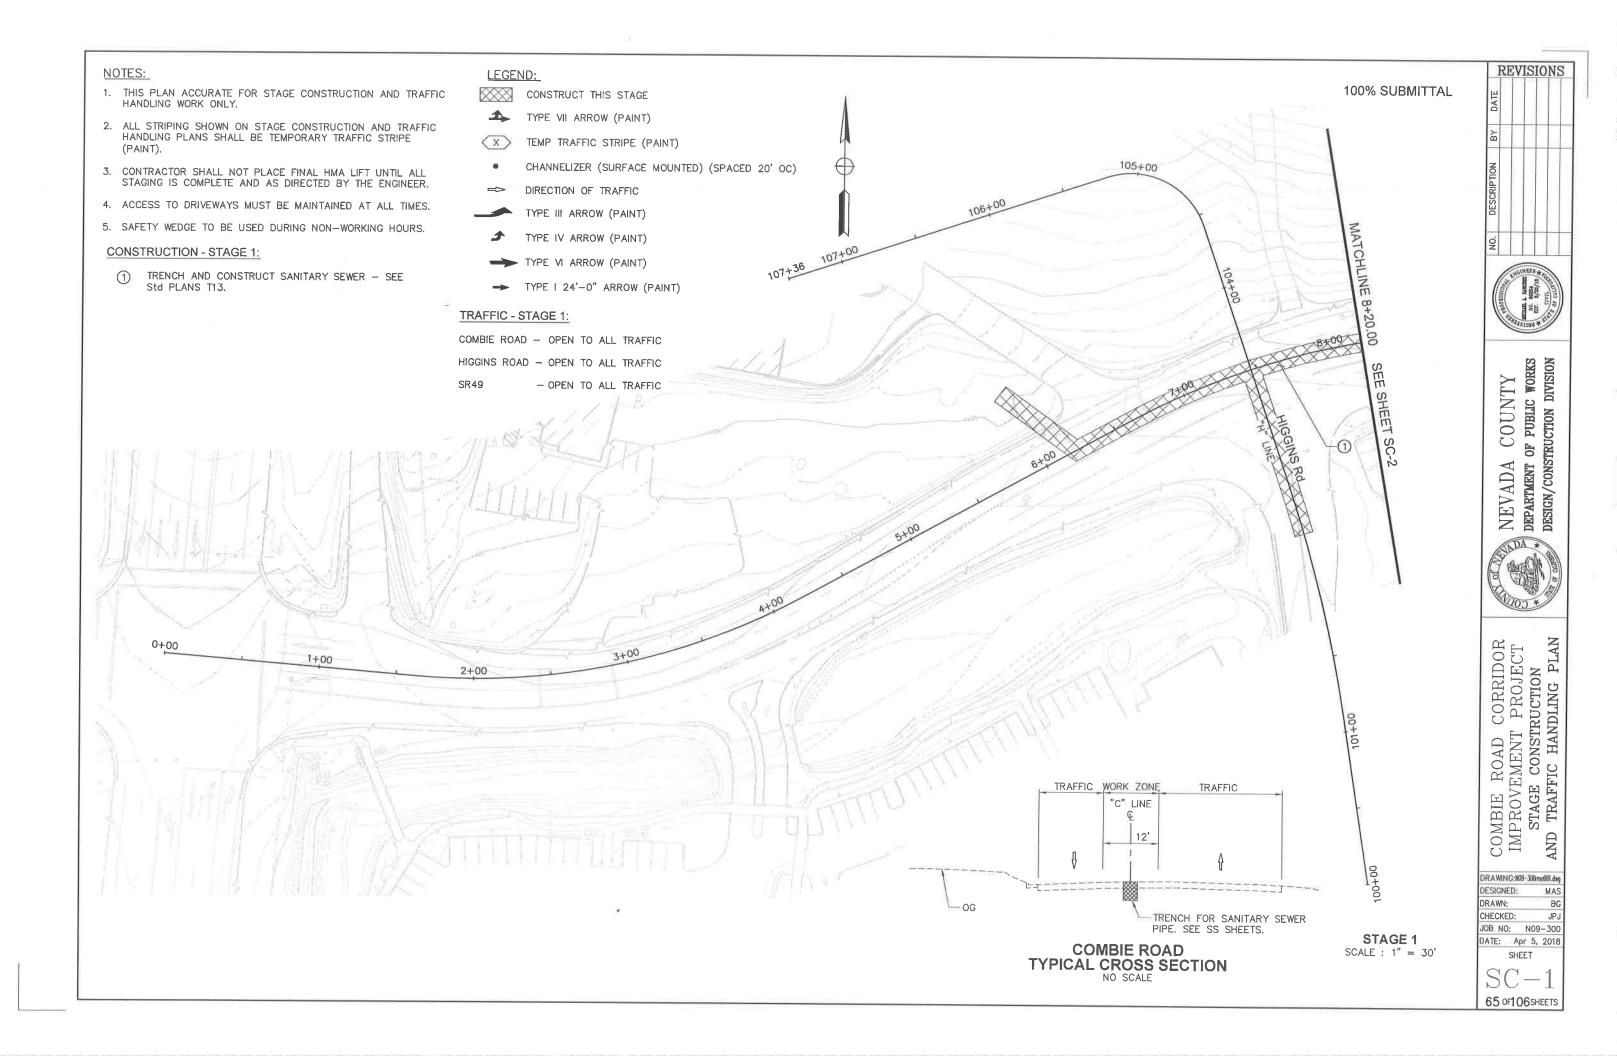

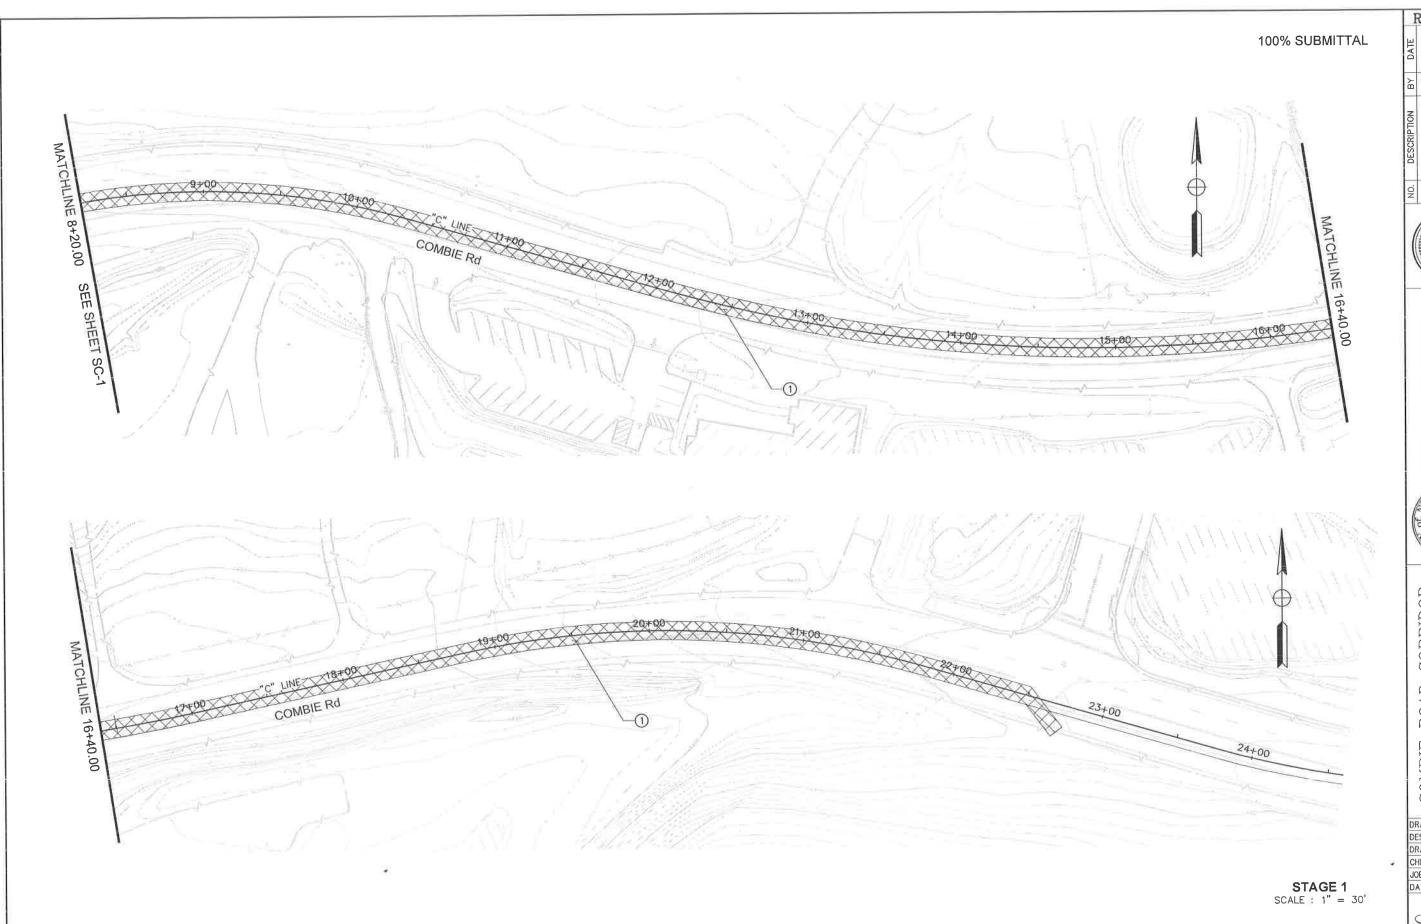

NO. DESCRIPTION BY DATE









COMBIE ROAD CORRIDOR IMPROVEMENT PROJECT STAGE CONSTRUCTION AND TRAFFIC HANDLING PLAN

| NG:N09-300rma002.dag |
|----------------------|
| NED: MAS |
| N: BG |
| (ED: JPJ |
| io: N09-300 |
| Apr 5, 2018 |
| SHEET |
| |

SC-2 66 OF1 06 SHEETS

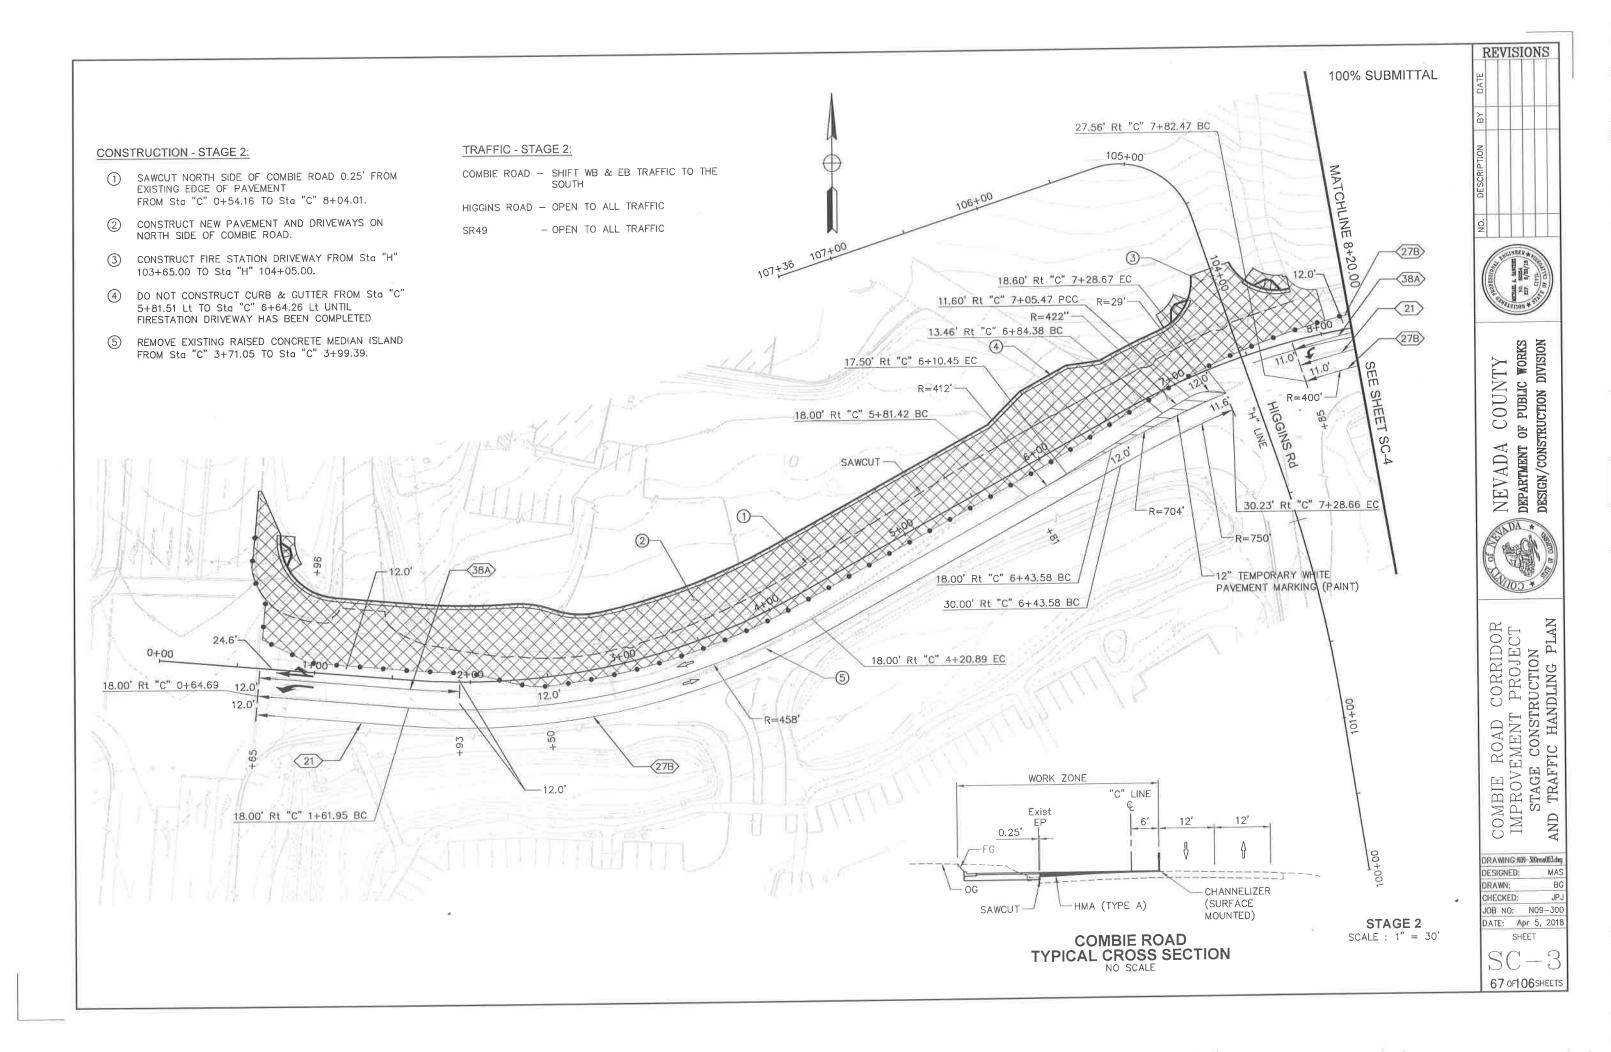

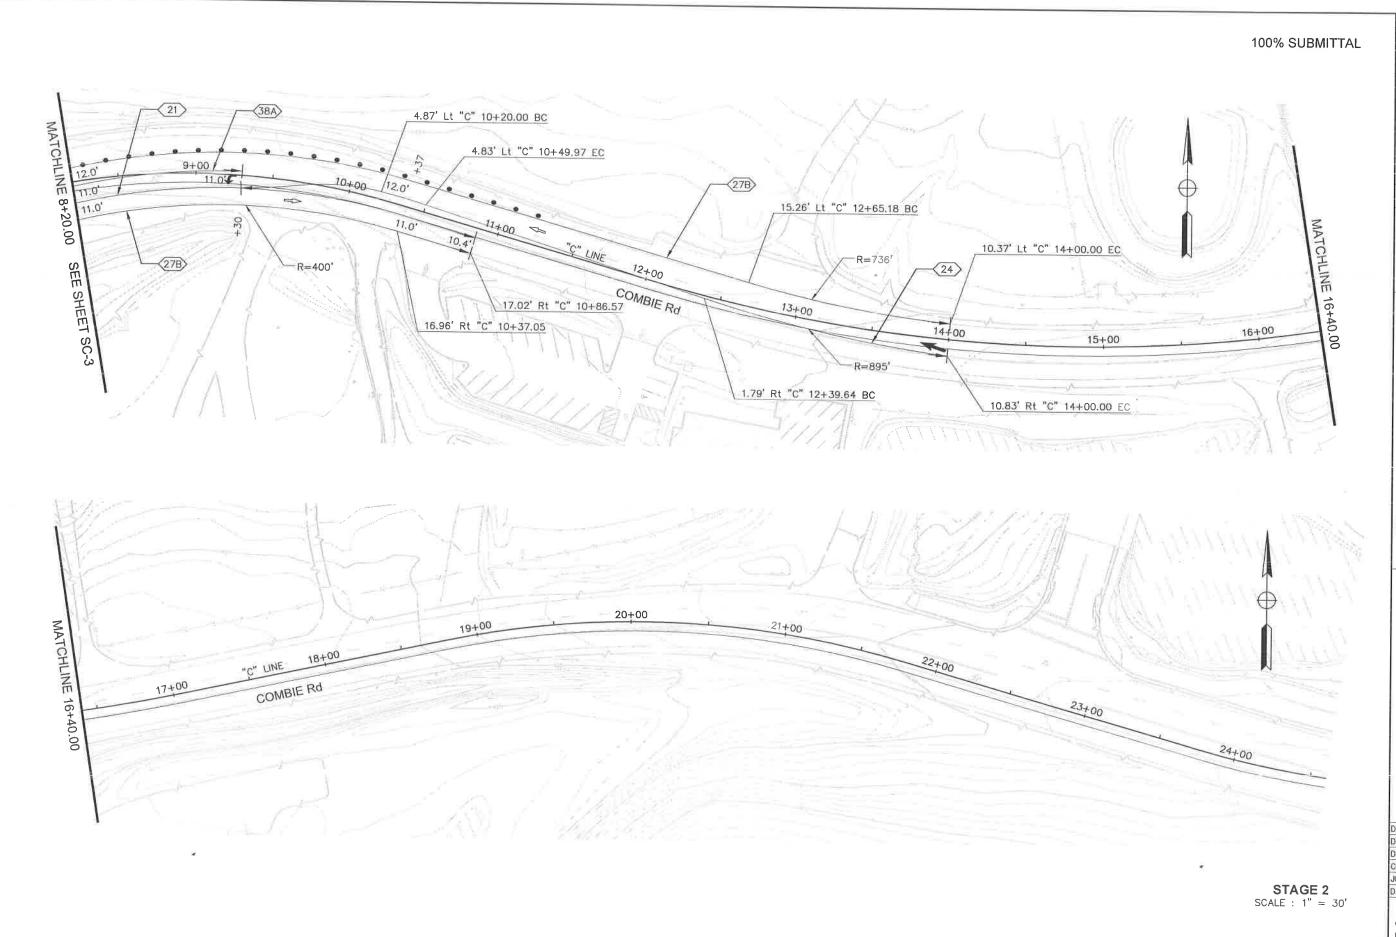









COMBIE ROAD CORRIDOR IMPROVEMENT PROJECT STAGE CONSTRUCTION AND TRAFFIC HANDLING PLAN

AND DRAWING:N09-300mia004.deg DESIGNED: MAS DRAWN: BG CHECKED: JOB NO: N09-300 DATE: Apr 5, 2018 SHEET

SC-4**68** OF **106** SHEETS

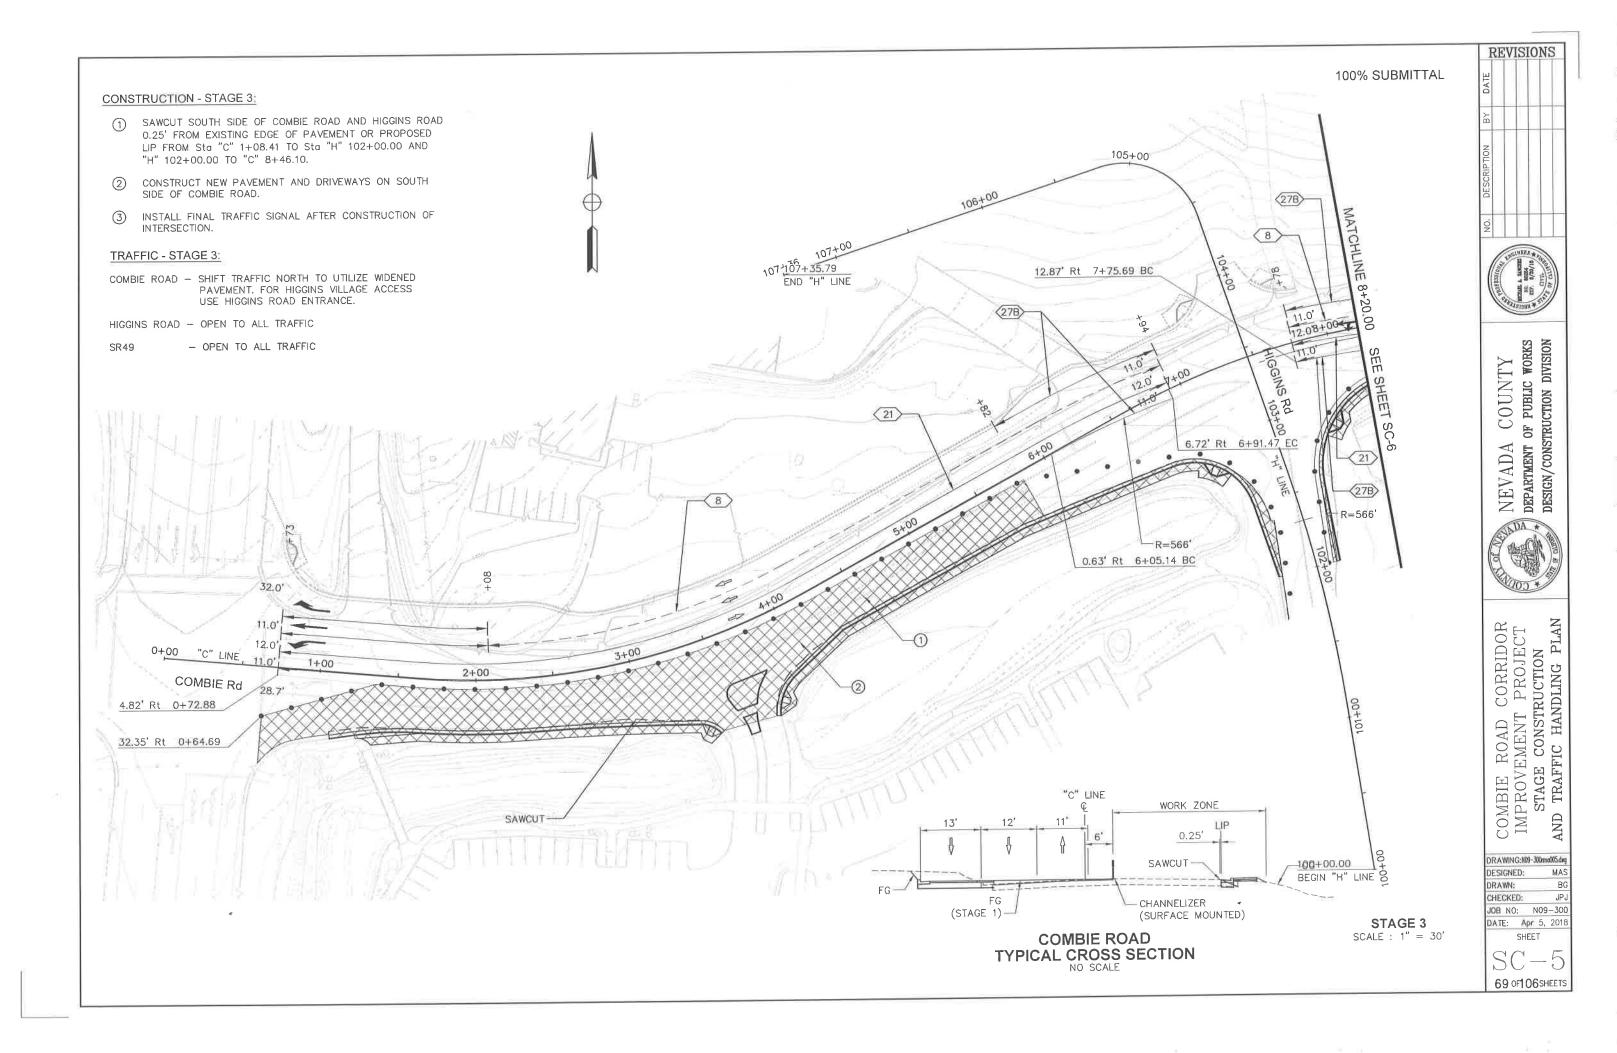

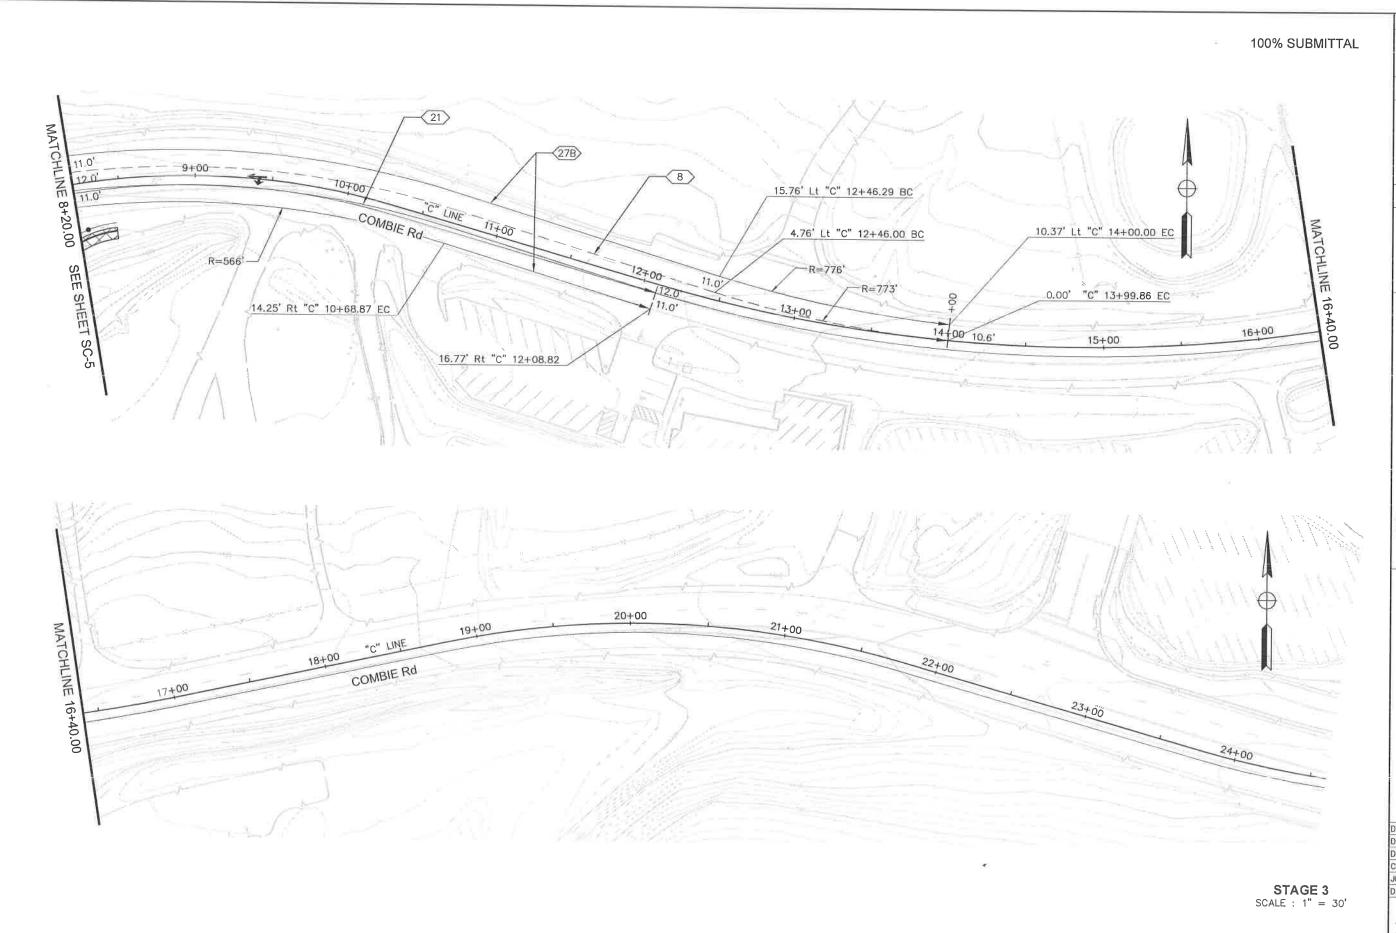







NEVADA COUNTY
DEPARTMENT OF PUBLIC WORKS
DESIGN/CONSTRUCTION DIVISION

COMBIE ROAD CORRIDOR IMPROVEMENT PROJECT STAGE CONSTRUCTION AND TRAFFIC HANDLING PLAN AND

DRAWING:N09-300mo006.dag DESIGNED: MAS DRAWN: CHECKED: JPJ JOB NO: NO9-300 DATE: Apr 5, 2018 SHEET

SC-670 OF 106 SHEETS

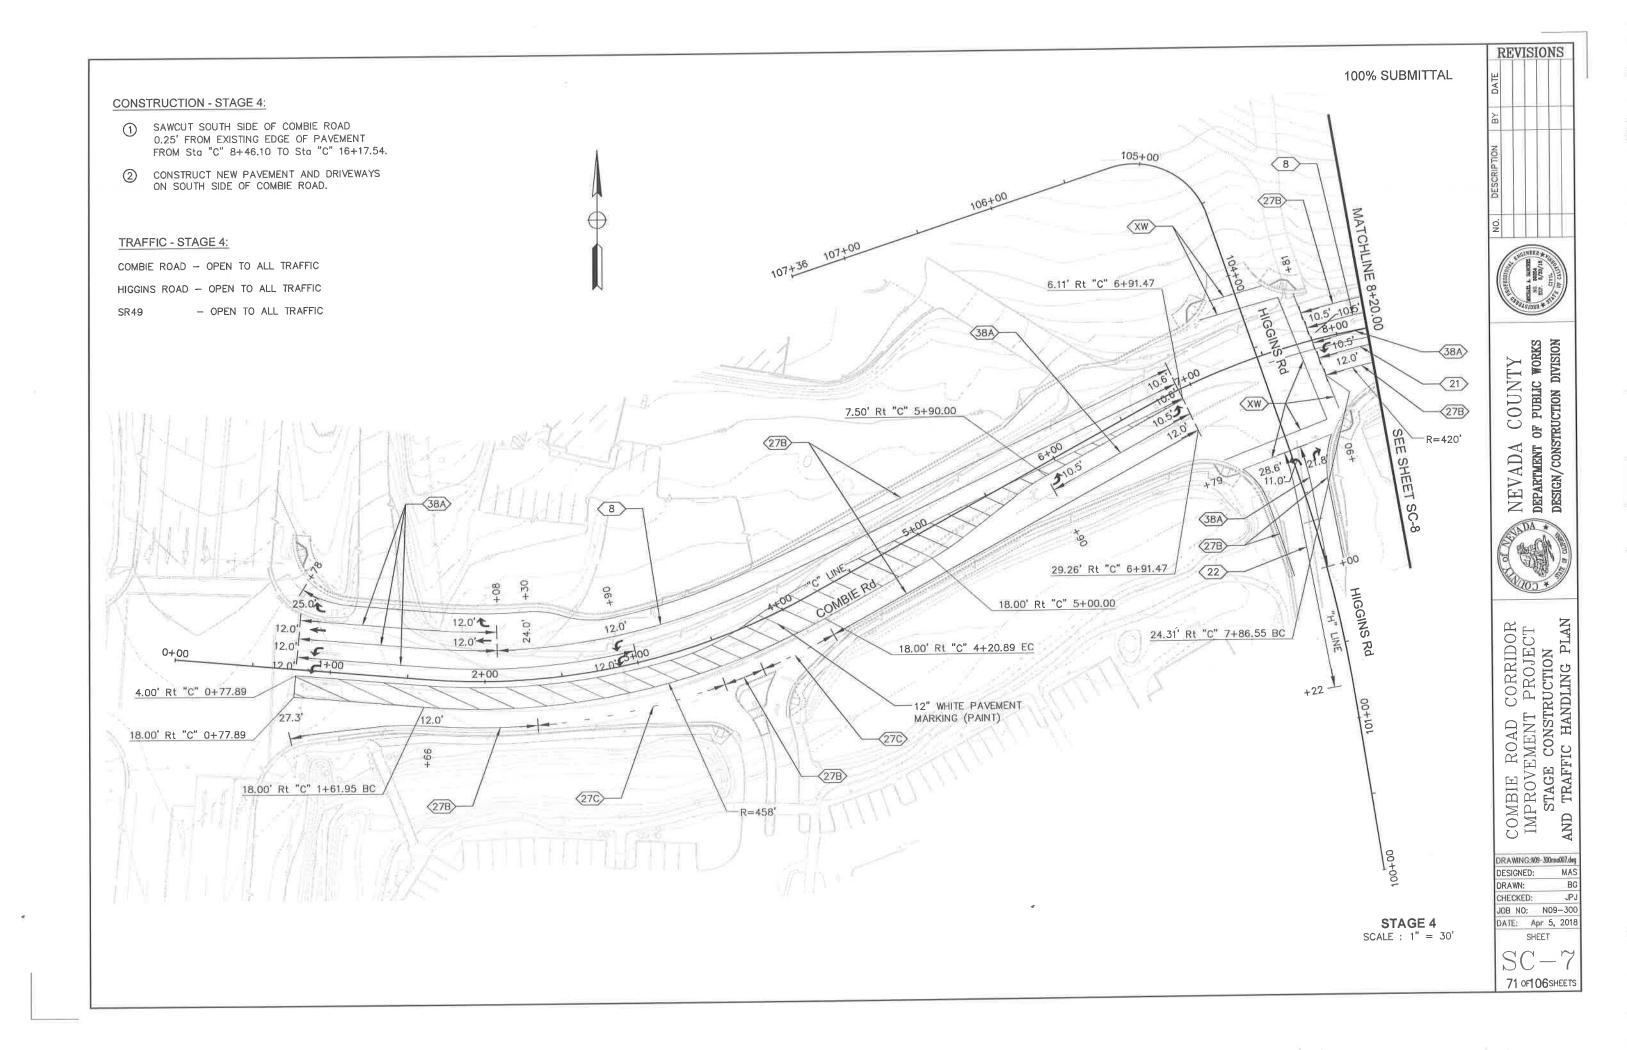

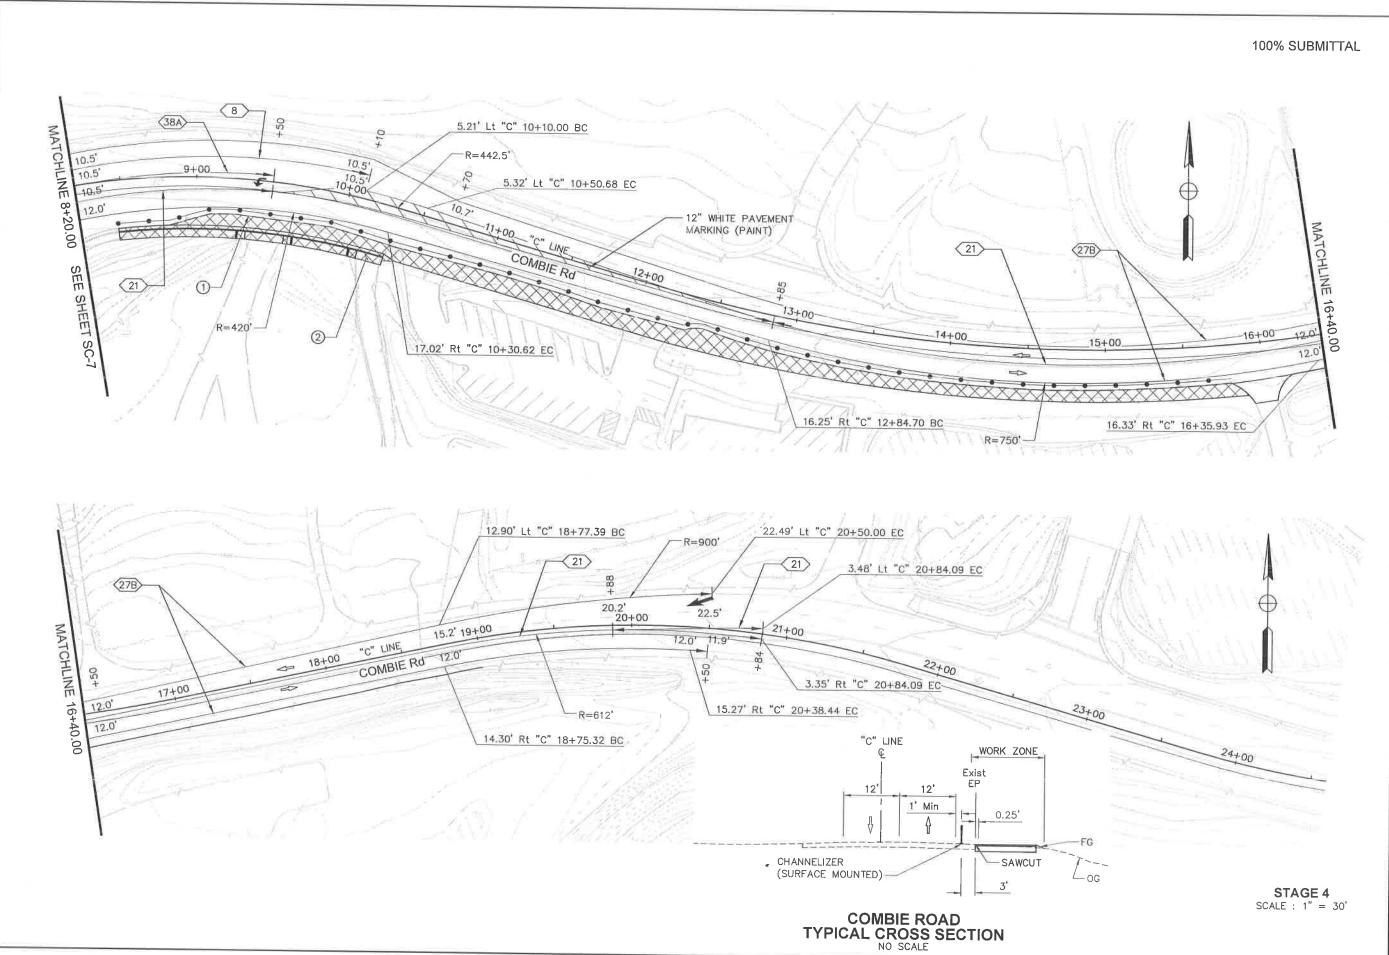






NEVADA COUNTY
DEPARTMENT OF PUBLIC WORKS
DESIGN/CONSTRUCTION DIVISION





COMBIE ROAD CORRIDOR IMPROVEMENT PROJECT STAGE CONSTRUCTION AND TRAFFIC HANDLING PLAN AND

| DRAWNG | :N09 | 300m | a008.di |
|----------|------|------|---------|
| DESIGNED |): | | MA |
| DRAWN: | | | В |
| CHECKED | : | | JP |
| JOB NO: | ١ | 109 | -30 |
| DATE: | Apr | 5, | 201 |
| S | HEE | Т | |
| ~~ | 4 | | |

SC-872 OF 106 SHEETS

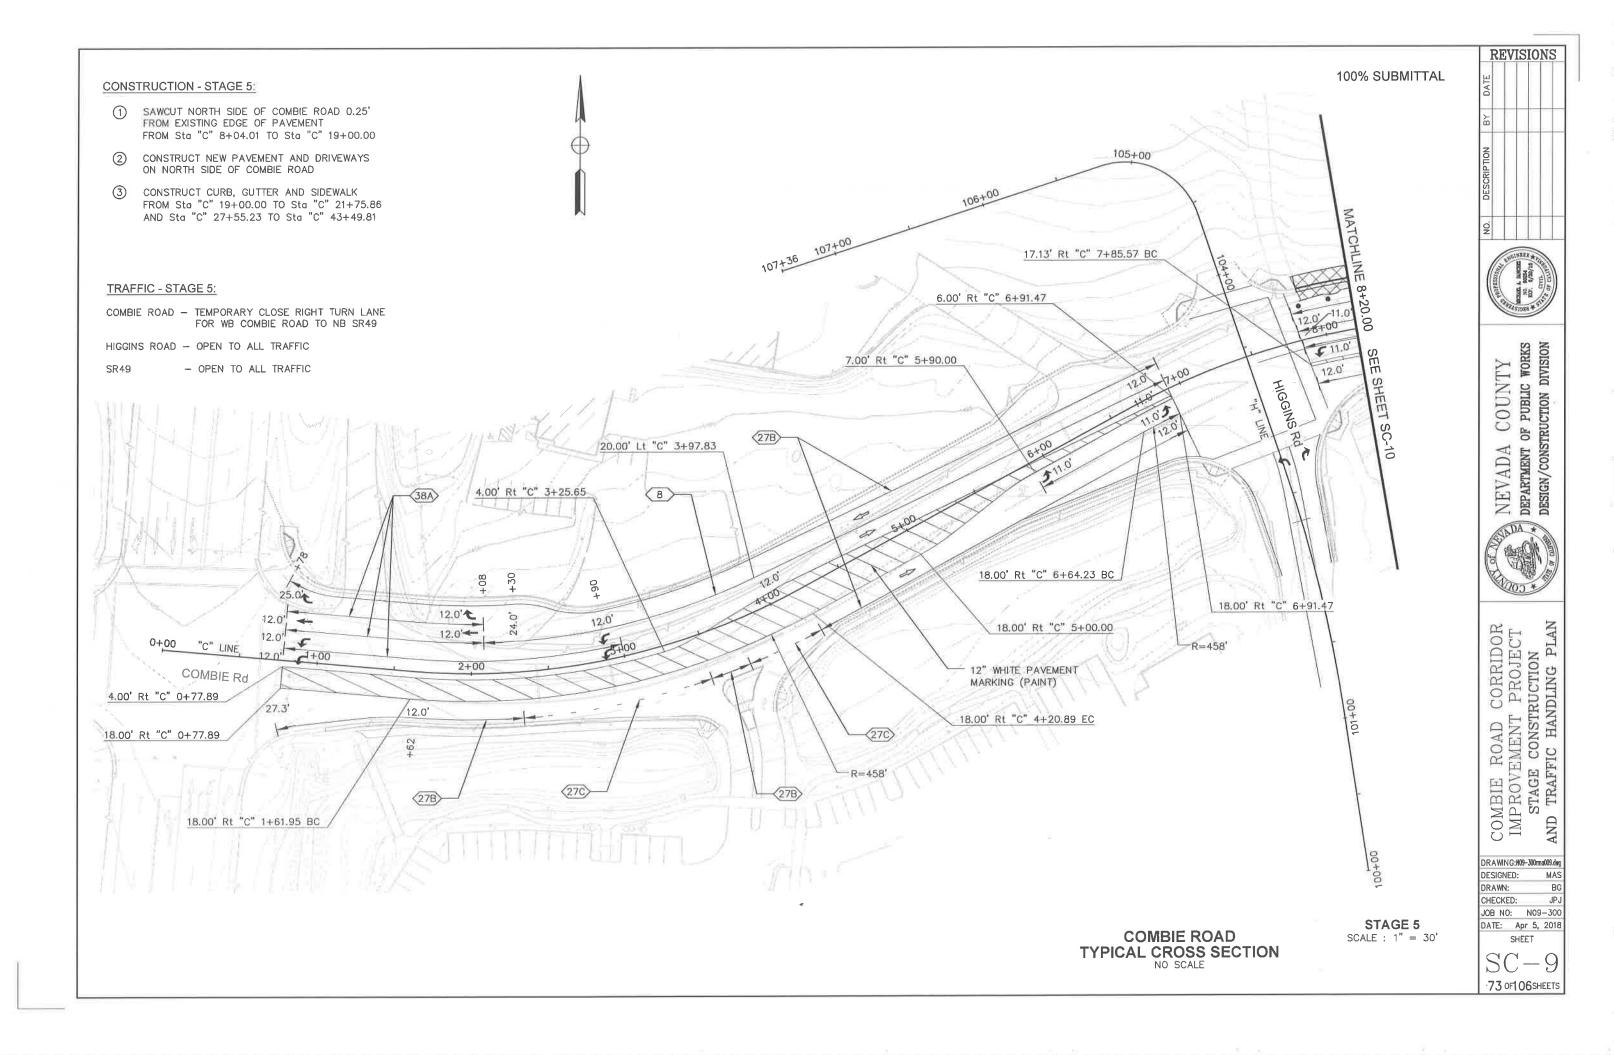

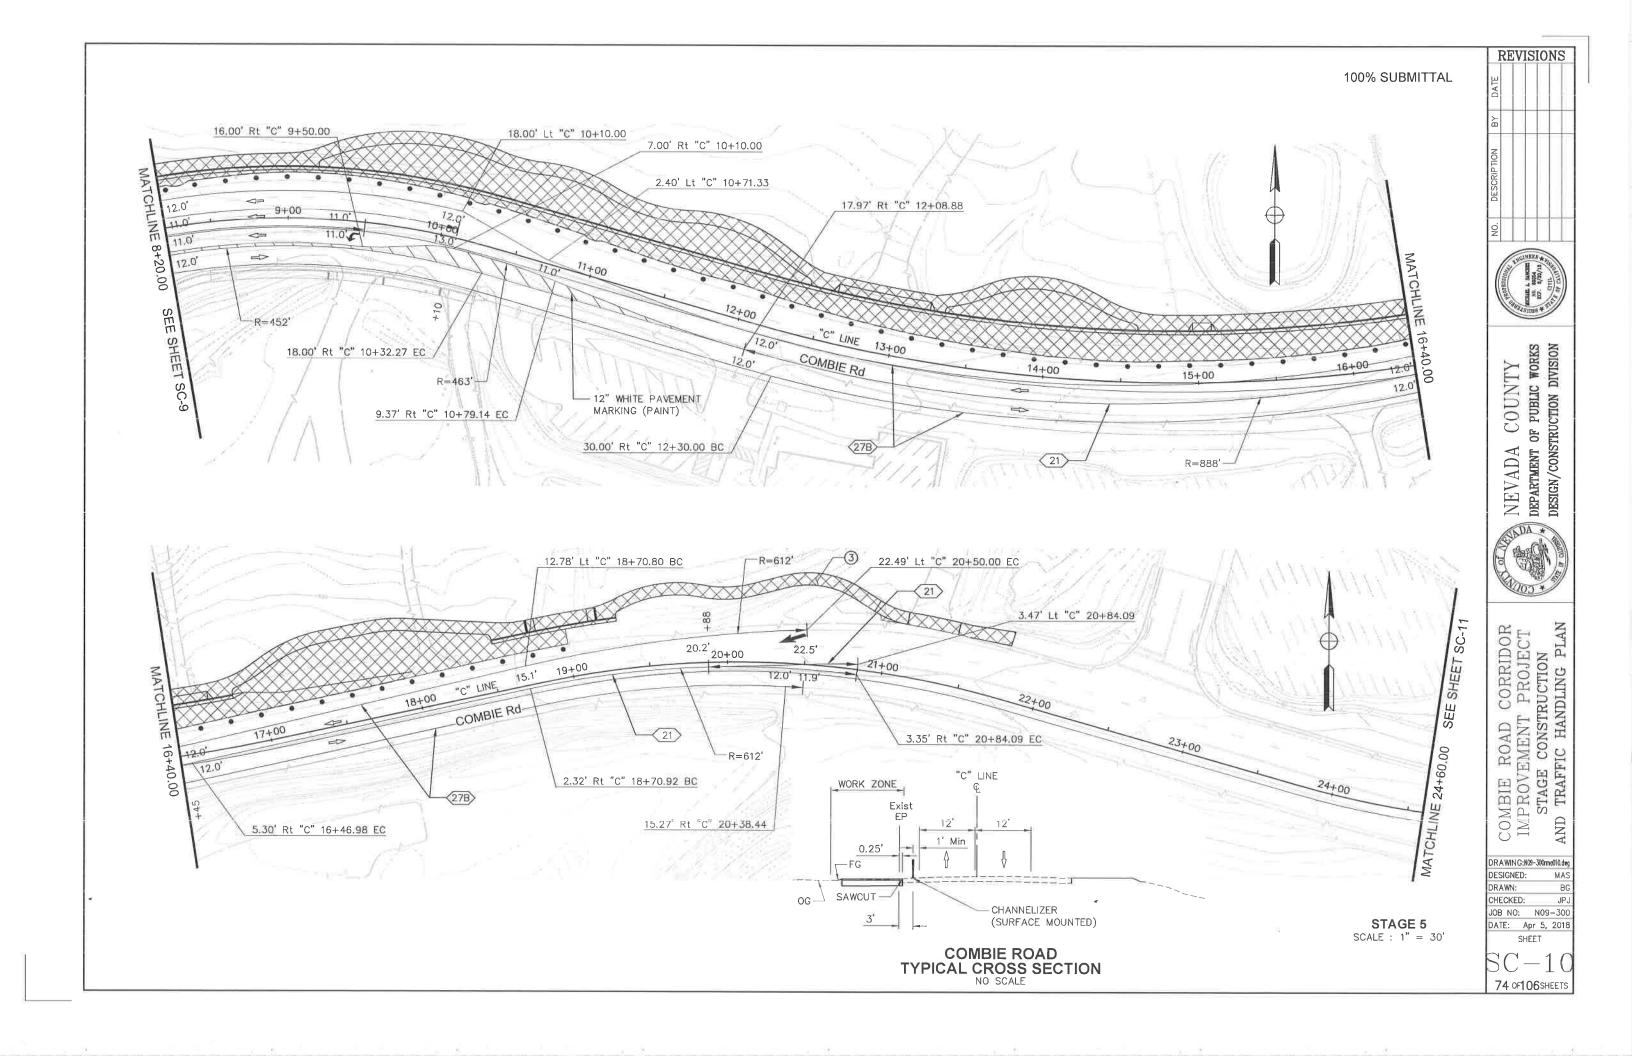

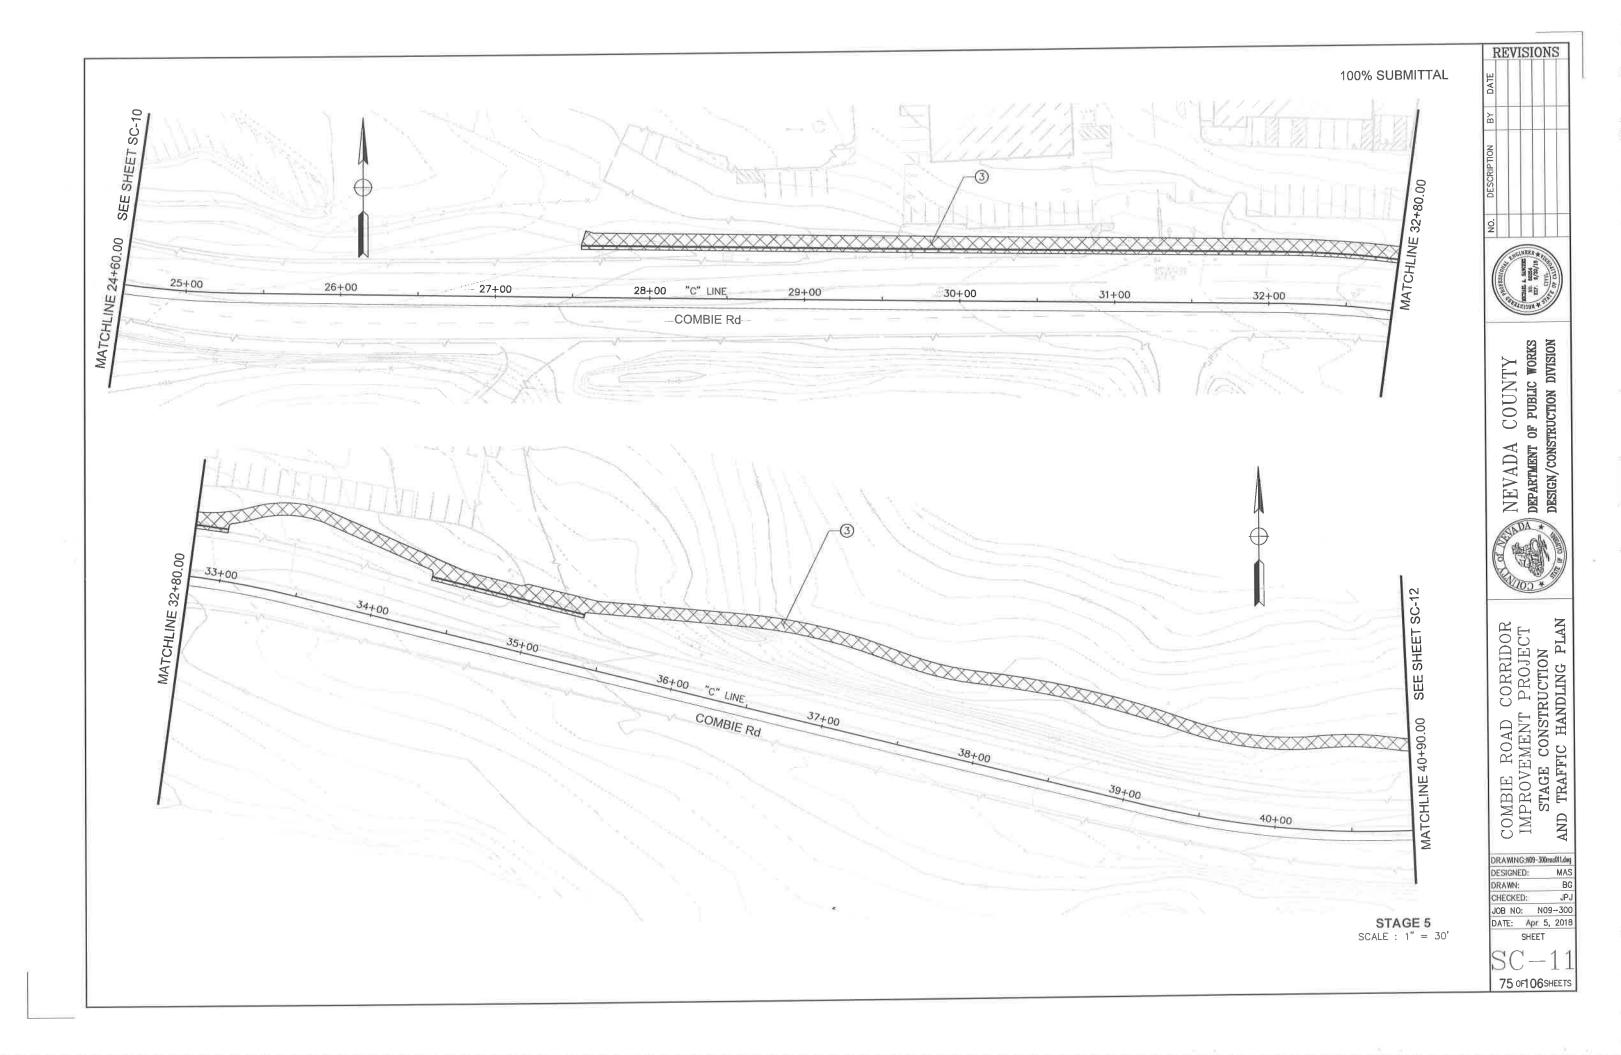

100% SUBMITTAL SEE SHEET L-11 MATCHLINE 40+90.00 **STAGE 5**SCALE : 1" = 30'

REVISIONS






NEVADA COUNTY
DEPARTMENT OF PUBLIC WORKS
DESIGN/CONSTRUCTION DIVISION




COMBIE ROAD CORRIDOR IMPROVEMENT PROJECT STAGE CONSTRUCTION AND TRAFFIC HANDLING PLAN AND

DRAWING:NO9-300rmo012.dag DESIGNED: DRAWN: MAS CHECKED: JPJ JOB NO: NO9-300 DATE: Apr 5, 2018

SHEET 76 OF 106 SHEETS

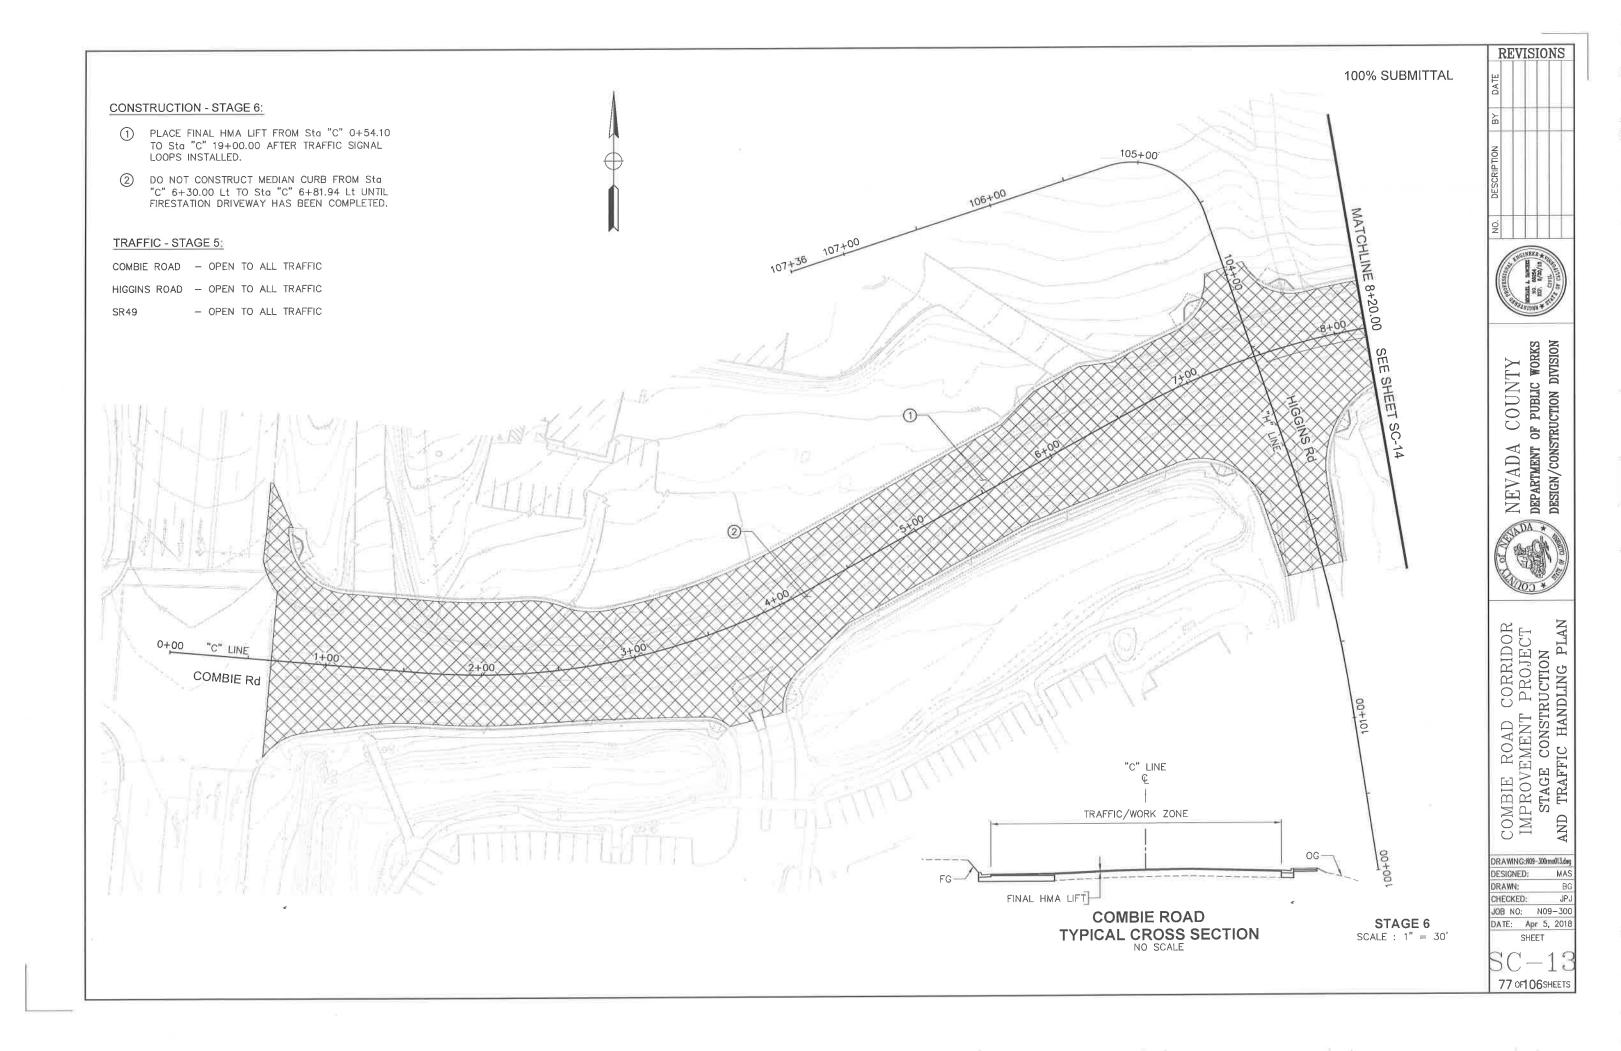

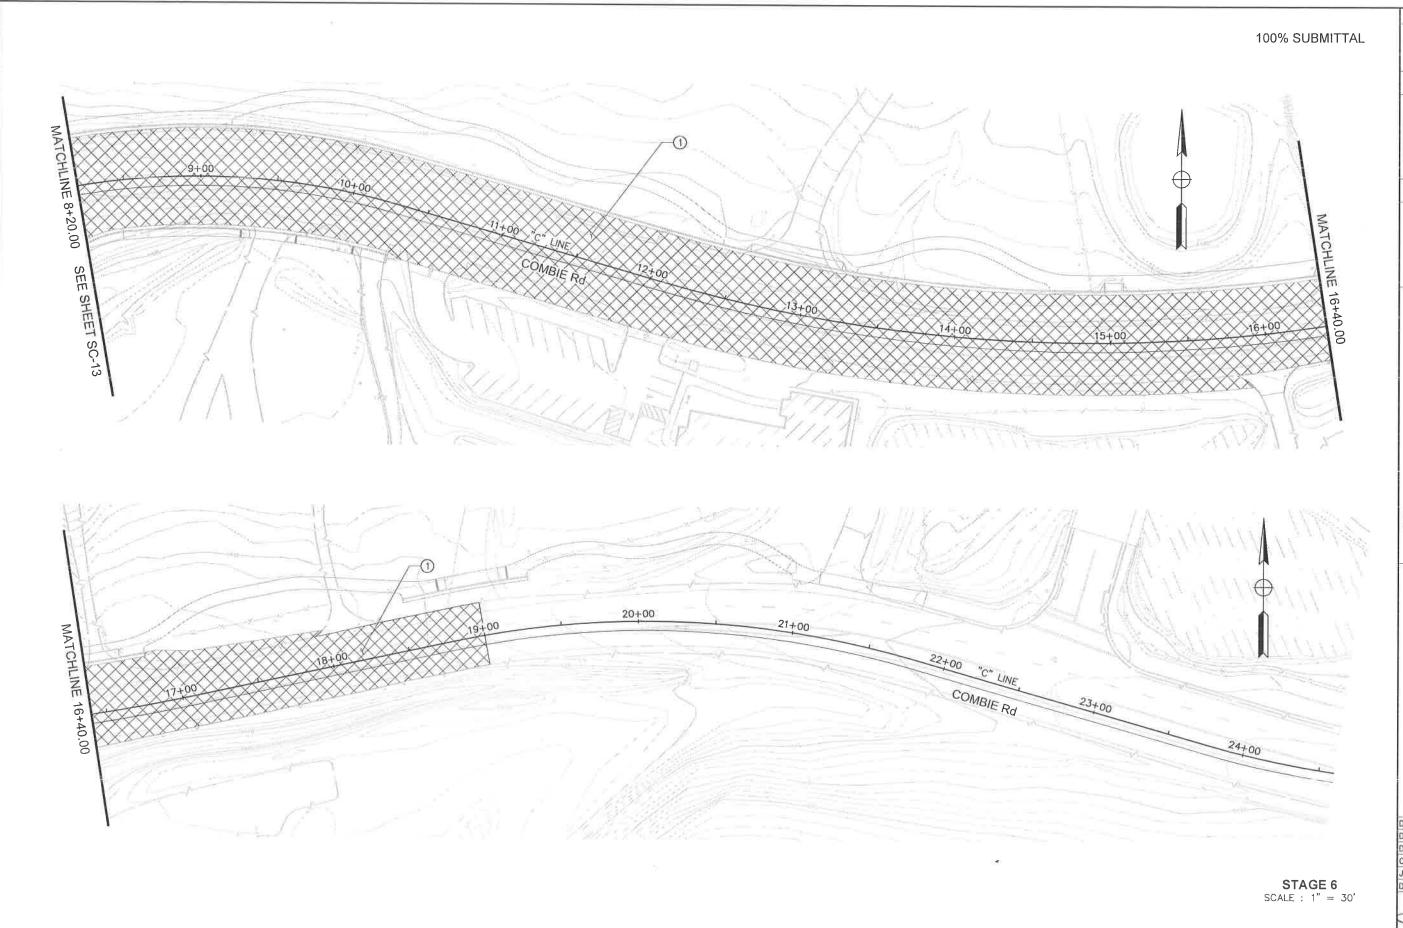

NO. DESCRIPTION BY DATE

SECTION BY DATE

NEVADA COUNTY
DEPARTMENT OF PUBLIC WORKS
DESIGN/CONSTRUCTION DIVISION



COMBIE ROAD CORRIDOR IMPROVEMENT PROJECT STAGE CONSTRUCTION AND TRAFFIC HANDLING PLAN

DRAWING:NO3-300ma014.ding
DESIGNED: MAS
DRAWIN: BG
CHECKED: JPJ
JOB NO: NO9-300
DATE: Apr 5, 2018

SHEET
SC-14
78 OF106SHEETS

STAGE CONSTRUCTION QUANTITIES

| SHEET No. | STAGE | | FRO | DΜ | | | Т | | | TEMPORARY HOT MIX ASPHALT★ | TEMPORARY TRAFFIC STRIPE (PAINT) | TEMPORARY PAVEMENT MARKING (PAINT) | REMOVE THERMOPLASTIC PAVEMENT MARKING | REMOVE THERMOPLASTIC TRAFFIC STRIPE | REMOVE YELLOW THERMOPLASTIC TRAFFIC STRIPE (HAZARDOUS WASTE) | CHANNELIZER (SURFACE MOUNTED) | TEMPORARY CONSTRUCTION P ENTRANCE | DESCRIPTION |
|--------------|-------|------|--------------------|----------------|-------|------|-------------------|--------------|----------|----------------------------|----------------------------------|------------------------------------|--|-------------------------------------|--|--------------------------------|-----------------------------------|--|
| | | LINE | STATION | OFFSET | Lt/Rt | LINE | STATION | OFFSET | Lt/Rt | TON | LF | SQFT | SQFT | LF | LF | 56 | - EA | |
| SC-3 | 2 | "C" | 0+50.00 | 85.00 | Lt | "C" | 8+20.00 | 10.00 | Lt | | | | | | | 50 | | |
| SC-3 | 2 | "C" | 5+81.00 | 0.00 | Lt/Rt | "C" | 8+05.00 | | Lt/Rt | 198.0 | 0.75 | | | | | | | STD. DETAIL 27B |
| SC-3 | 2 | "C" | 0+65.00 | 30.00 | Rt | "0" | 7+20.00 | 30.00 | Rt | | 655 | | | | | | | STD, DETAIL 21 |
| SC-3 | 2 | "C" | 0+65.00 | 18.00 | Rt | "C" | 5+90.00 | 18.00 | Rt | | 643 | | | | | | | STD. DETAIL 38A |
| SC-3 | 2 | "C" | 0+65.00 | 6.00 | Rt | "C" | 1+93.00 | 6.00 | Rt | | 128 | 269 | | | - | | | 12" TEMPORARY WHITE PAVEMENT MARKING |
| SC-3 | 2 | "C" | 5+90.00 | 0.00 | Lt/Rt | "C" | 7+20.00 | | Lt/Rt | | | 72 | | | | | | 12" TEMPORARY WHITE PAVEMENT MARKING (DIAGONALS) |
| SC-3 | 2 | #C# | 5+90.00 | 0.00 | Lt/Rt | "C" | 7+20.00 | | Lt/Rt | | | 27 | | | | | | TYPE VII (R) ARROW |
| SC-3 | 2 | "C" | 0+90.00 | 0.00 | Lt/Rt | | | | - | | | 42 | | - | | | | TYPE III (L) ARROW |
| SC-3 | 2 | "C" | 0+90.00 | 10.00 | Rt | - 52 | | ¥ | - | | - | 15 | | | | | | TYPE IV (L) ARROW |
| SC-3 | 2 | "C" | 7+90.00 | 10.00 | Rt | - | | 45.00 | - | | 30 | 13 | | | | | | STD. DETAIL 21 |
| SC-3 | 2 | "C" | 7+90.00 | 17.00 | Rt | "C" | 8+20.00 | 15.00 | Rt | | 30 | | - | | | | | STD. DETAIL 27B |
| SC-3 | 2 | "C" | 7+90.00 | 28.00 | Rt | "C" | 8+20.00 | 25.00 | Rt Lt | | 16 | | - | | | | | STD. DETAIL 27B |
| SC-3 | 2 | "C" | 8+04.00 | 10.00 | Lt | "C" | 8+20.00 | 10.00 | Rt | - | 30 | | | | | | | STD, DETAIL 38A |
| SC-3 | 2 | "C" | 7+90.00 | 6.00 | Rt | "C" | 8+20.00 | 3.00 8.00 | Lt | | 30 | | | 20 | | | | |
| SC-3 | 2 | "C" | 0+70.00 | 8.00 | Lt | "C" | +90.00 4+00.00 | 4,00 | Rt | | | | | 340 | | | | |
| SC-3 | 2 | "C" | 0+70.00 | 4.00 | Rt | "C" | 8+20.00 | 25.00 | Rt | | | | | 760 | | | | |
| SC-3 | 2 | "C" | 0+70,00 | 48.00 14.00 | Rt Rt | "C" | 3+70.00 | 22.00 | Rt | | i | | | | 303 | | | |
| SC-3 | 2 | "C" | 0+70.00 3+35.00 | 14.00 | Rt | "C" | 6+30.00 | 8.00 | Rt | 1 | | | | | 310 | | | |
| SC-3 | 2 | "C" | 4+10.00 | 20.00 | Rt | "C" | 5+40.00 | 10.00 | Rt | | | | | | 145 | | | |
| SC-3 | 2 | "C" | 6+60.00 | 10.00 | Rt | "C" | 7+40.00 | 15.00 | Rt | | | | | | 87 | | | |
| SC-3 SC-3 | 2 | "C" | 6+60.00 | 22.00 | Rt | "C" | 7+40.00 | 15.00 | Rt | | | | | | 87 | | | |
| SC-3 | 2 | "C" | 7+85.00 | 20.00 | Rt | "C" | 8+20.00 | 20.00 | Rt | | | | | | 35 | | | |
| SC-3 | 2 | "C" | 0+70.00 | 3.00 | Rt | | | | | | | | 42 | | | | | |
| SC-3 | 2 | "C" | 0+70.00 | 15.00 | Rt | | | | | | | | 42 | | | | - | THE WALL AND CHA |
| SC-4 | 2 | "C" | 19+25.00 | 3,00 | Rt | - | | - | | | | 15 | | | | | | TYPE IV (L) ARROW |
| SC-4 | 2 | "C" | 13+95.00 | 5.00 | Rt | | | + | 1- | | | 42 | | | | | | TYPE VI ARROW STD, DETAIL 27B |
| SC-4 | 2 | "C" | 8+20.00 | 25.00 | Rt | "C" | 10+86.00 | 17.00 | Rt | | 266 | | | | | | - | STD. DETAIL 21 |
| SC-4 | 2 | "C" | 8+20.00 | 14,00 | Rt | "C" | 10+86.00 | 6.00 | Rt | | 266 | | | - | | - | | STD. DETAIL 38A |
| SC-4 | 2 | "C" | 8+20.00 | 3.00 | Rt | "C" | 9+30.00 | 3,00 | Lt | | 110 | | | | | | | STD. DETAIL 27B |
| SC-4 | 2 | "C" | 8+20.00 | 10.00 | Lt | "C" | 14+00.00 | 10.00 | Lt | | 580 | | - | | | - | | STD. DETAIL 24 |
| SC-4 | 2 | "C" | 9+30,00 | 9.00 | Rt | "C" | 14+00.00 | 11.00 | Rt | | 470 | | - | | | 21 | | |
| SC-4 | 2 | "C" | 8+20.00 | 10.00 | Lt | "C" | 11+08.00 | 12.00 | Lt | - | - | - | | 75 | | | | |
| SC-4 | 2 | "C" | 8+20.00 | 1.00 | Lt | "C" | 8+95.00 | 3.00 | Lt | | | - | | 270 | | | | |
| SC-4 | 2 | "C" | 8+20.00 | 22.00 | Rt | "C" | 10+87.00 | 17.00 | Rt | | _ | | | 470 | | | | |
| SC-4 | 2 | "C" | 9+30.00 | 15.00 | Lt | "C" | 14+00.00 | 1.00 | Lt | - | | | | 270 | | | | |
| SC-4 | 2 | "C" | 11+25.00 | 14.00 | Lt | "C" | 14+00.00 | 12.00 | Rt | - | 1 | | | | 579 | | | |
| SC-4 | 2 | "C" | 8+20.00 | 14,00 | Rt | "C" | 14+00.00 | 4.00 | Rt | | | | | | 226 | | | |
| SC-4 | 2 | "C" | 9+30.00 | 8.00 | Rt | *H* | 101+85.00 | 15.00 | Lt | + | | | | | | 39 | | |
| SC-5 | 3 | "C" | 0+64.69 | 32.35 | Rt | - | 101-00,00 | 13,00 | | | | | | | | | | |
| SUBTOTAL | | | | | | | | | | 198.0 | 3224 | 482 | 84 | 2205 | 1772 | 116 | | |

*FOR TOTAL QUANTITY, SEE "ROADWAY QUANTITY" TABLE.





NEVADA COUNTY DEPARTMENT OF PUBLIC WORKS DESIGN/CONSTRUCTION DIVISION

COMBIE ROAD CORRIDOR IMPROVEMENT PROJECT STAGE CONSTRUCTION QUANTITIES

| DRAWNG:NO | 9 300rmh001.duc |
|-----------|-----------------|
| DESIGNED: | MAS |
| DRAWN: | BC |
| CHECKED: | JP. |
| JOB NO: | N09-300 |
| DATE: A | or 5, 2018 |

SHEET

STAGE CONSTRUCTION QUANTITIES

| SHEET No. STAC | AGE | | FR | ОМ | | | | | | * | E E | | | | | | Z | |
|----------------|-----|-----------|-----------|----------------|-------|----------|-----------|------------|--------------|--------------------------|--------------------------|---------------------------------------|----------------------|----------------------|--|----------------------------------|------------------------------------|---------------------|
| SC-5 2 | | LINE | STATION | OFFSET | Lt/Rt | LINE | T STATION | OFFSET | Lt/Rt | HOT MIX ASPHALT (TYPE A) | TEMPORARY TRAFFIC STRIP! | TEMPORARY PAVEMENT MARKING (PAINT) | REMOVE THERMOPLASTIC | REMOVE THERMOPLASTIC | REMOVE YELLOW THERMOPLASTIC TRAFFIC STRIPE (HAZARDOUS WASTE) | CHANNELIZER (SURFACE MOUNTED) | TEMPORARY CONSTRUCTION ENTRANCE | DESCRIPTION |
| 30-0 | 3 | "H" | 102+00.00 | 8.00 | Rt | "C" | 8+20.00 | 40.00 | Rt | TON | LF | SQFT | SQFT | LF | LF | EA | EA | |
| SC-5 3 | 3 | "C" | 8+15.00 | 3.00 | Lt | - 3 | 0120.00 | 40.00 | | | | - | | | | 7 | | |
| SC-5 3 | 3 | "C" | 0+73.00 | 34.00 | Lt | "C" | 2+08.00 | 34.00 | Lt | | 405 | 27 | | | | | | TYPE VII (L) ARROW |
| SC-5 3 | 3 | "C" | 0+73.00 | 23.00 | Lt | "C" | 2+08.00 | 23.00 | Lt | | 135 | | | | | | | STD. DETAIL 38A |
| SC-5 3 | 3 | "C" | 0+73.00 | 11.00 | Lt | "C" | 6+94.00 | 11.00 | Lt | | 135 | | | 0 | | | | STD. DETAIL 3BA |
| SC-5 3 | 3 | "C." | 0+73.00 | 0.00 | Lt/Rt | "C" | 6+92.00 | 7.00 | Rt | | 621 | | | | | | | STD. DETAIL 21 |
| SC-5 3 | 3 | "C" | 2+08.00 | 23.00 | Lt | "C" | 6+94.00 | 23.00 | | | 619 | | | | | | | STD. DETAIL 27B |
| SC-5 3 | 3 | "C" | 5+82.00 | 34.00 | Lt | "C" | 6+94.00 | 34.00 | Lt | | 486 | | | | | | | STD. DETAIL 8 |
| SC-5 3 | 3 | "C" | 7+78.00 | 22.00 | Lt | "C" | 8+20.00 | 22.00 | Lt | | 112 | | | | | | | STD. DETAIL 27B |
| SC-5 3 | | "C" | 7+78.00 | 11.00 | Lt | "C" | 8+20.00 | | Lt | | 42 | | | | | | | STD. DETAIL 27B |
| SC-5 3 | 3 | "C." | 7+78.00 | 1.00 | Rt | "C" | 8+20.00 | 11.00 | Lt | | 42 | | | | | | | STD. DETAIL 21 |
| SC-5 3 | 3 | мСи | 7+78,00 | 12.00 | Rt | "C" | | 1.00 | Rt | | 42 | | | | | | | STD. DETAIL 8 |
| SC-6 3 | | "C" | 8+20.00 | 30.00 | RI | "C" | 8+20.00 | 12.00 | Rt | | 42 | | | | | | | STD, DETAIL 27B |
| SC-6 3 | | "C" | 9+40.00 | 0.00 | L#Rt | - | 8+25.00 | 30.00 | Ri | | | | | | | 1 | | |
| SC-6 3 | | "C" | 8+20.00 | 19.00 | Lt | - "C" | 14.00.00 | - 10.00 | | | | 27 | | | | | | TYPE VII (L) ARROW |
| SC-6 3 | | "C" | 8+20.00 | 8.00 | Lt | | 14+00.00 | 10.00 | Lt | | 580 | | | | | | | STD. DETAIL 27B |
| SC-6 3 | | "C" | 8+20.00 | 4.00 | Rt | "C" | 14+00.00 | | Lt/Rt | | 580 | | | | | | | STD. DETAIL 8 |
| SC-6 3 | | "C" | 8+20.00 | 15.00 | | "C" | 12+10.00 | 5.00 | Rt | | 390 | | | | | | | STD. DETAIL 27B |
| SC-7 4 | | "C" | 0+90.00 | | Rt | "C" | 12+10.00 | 16.00 | Rt | | 390 | | | | | | | STD. DETAIL 21 |
| SC-7 4 | _ | "C!" | 0+90.00 | 40.00 25.00 | Lt | | | | - | | | 15 | | | | | | TYPE IV (R) ARROW |
| SC-7 4 | | "C" | 0+90.00 | | Lt | - | | | 16 | | | 31 | | | | | | TYPE I 24'-0" ARROW |
| SC-7 4 | | "C" | 0+90.00 | 15.00 | Lt | - | | • | 151 | | | 15 | | | | | | TYPE IV (L) ARROW |
| SC-7 4 | _ | "C" | | 3.00 | Lt | | * | • | 12 | | | 15 | | | | | | TYPE IV (L) ARROW |
| SC-7 4 | | "C" | 2+00.00 | 40.00 | Lt | | 5: | 190 | 3 e : | | | 15 | | | | | | TYPE IV (R) ARROW |
| SC-7 4 | | "C" | 2+00.00 | 25.00 | Lt | | - | 7.81 | | | | 31 | | | | | | TYPE I 24'-0" ARROW |
| SC-7 4 | | "C" | 2+90.00 | 15.00 | Lt | 5 | • | · · | | | | 15 | | | | - | | TYPE IV (L) ARROW |
| SC-7 4 | | "C" | 2+90.00 | 5.00 | Lt | , F. | 161 | (2) | :50 | | | 15 | | | | | | TYPE IV (L) ARROW |
| SC-7 4 | | | 5+90.00 | 10.00 | Rt | | | | 1965 | | | 15 | | | | | | TYPE IV (L) ARROW |
| | | "C" | 6+85.00 | 12.00 | Rt | - | 39 | <u>**</u> | | | | 15 | | | | | | TYPE IV (L) ARROW |
| | | | 102+90.00 | 2.00 | Rt | | | 190 | 120 | | | 15 | | | | | | TYPE IV (L) ARROW |
| | _ | | 102+90.00 | 15.00 | Rt | | | (4) | 190 | | | 15 | | | | | | TYPE IV (R) ARROW |
| 228 | | "C" | 7+90.00 | 5.00 | Rt | | | (a) | 52.0 | | | 15 | | | | | | TYPE IV (L) ARROW |
| SC-7 4 | _ | "C" | 0+78.00 | 32.00 | Lt | "C" | 2+08.00 | 32.00 | Lt | | 130 | | | | | | | STD. DETAIL 38A |
| SC-7 4 | | | 0+78.00 | 20.00 | Lt | "C" | 2+08.00 | 20.00 | Lt | | 130 | | | | | - | | STD. DETAIL 38A |
| SC-7 4 | | "C" | 0+78.00 | 8.00 | Lt | "C" | 2+90.00 | 8.00 | Lt | | 212 | | | | | | | STD. DETAIL 38A |
| SC-7 4 | | "C" | 0+78.00 | 45.00 | Rt | C | 2+30.00 | 30.00 | Rt | | 152 | | | | | | | STD. DETAIL 38A |
| | | "C" | 2+30.00 | 30.00 | Rt | "C" | 3+50.00 | 30 00 | Rt | | 120 | | | | | | | STD. DETAIL 278 |
| SC-7 4 | | VIV - V/I | 3+50.00 | 30.00 | Rt | "C" | 3+75.00 | 30.00 | Rt | | 25 | | | | | | | |
| SC-7 4 | | | 3+75.00 | 30.00 | Rt | "C" | 4+20.00 | 30.00 | Rt | | 45 | | | | | | | STD. DETAIL 27B |
| SC-7 4 | | "C" | 2+08.00 | 20.00 | Lt | "C" | 6+90.00 | 5.00 | Lt | | 482 | | | | | | | STD DETAIL 27C |
| SC-7 4 | | "C" | 0+78.00 | 56.00 | Lt | "C" | 6+90.00 | 15.50 | Lt | | 612 | | | | | | | STD. DETAIL 8 |
| | | | | | | | | | | | | | | | | | - 5 | STD_DETAIL 278 |
| SUBTOTAL | | | | | | | | | | | 6124 | 281 | | | | 8 | | |

* FOR TOTAL QUANTITY, SEE "ROADWAY QUANTITY" TABLE.

| R | EVI | SIC | NS |
|-------------|-----|-----|----|
| DATE | | | |
| BY | | | |
| DESCRIPTION | | | |
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NEVADA COUNTY DEPARTMENT OF PUBLIC WORKS DESIGN/CONSTRUCTION DIVISION



COMBIE ROAD CORRIDOR
IMPROVEMENT PROJECT
STAGE CONSTRUCTION
QUANTITIES

DRAWING: N09-300mib002.deg DESIGNED: MAS DRAWN: CHECKED: JPJ JOB NO: N09-300 DATE: Apr 5, 2018

SHEET

SCQ-

STAGE CONSTRUCTION QUANTITIES

| | | | | | | | | - 3 | IAGE | 7011011 | | TT GOA | NIIIES | | | | | |
|--------------|-------|------|-----------|--------|-------|------|-----------|--------|-------|-----------------------------|----------------------------------|------------------------------------|--|--|--|----------------------------------|------------------------------------|--|
| SHEET No. | STAGE | | FRO | OM | | | T | | | TEMPORARY HOT MIX ASPHALT * | TEMPORARY TRAFFIC STRIPE (PAINT) | TEMPORARY PAVEMENT MARKING (PAINT) | REMOVE THERMOPLASTIC PAVEMENT MARKING | REMOVE THERMOPLASTIC TRAFFIC STRIPE | REMOVE YELLOW THERMOPLASTIC TRAFFIC STRIPE (HAZARDOUS WASTE) | CHANNELIZER (SURFACE MOUNTED) | TEMPORARY CONSTRUCTION ENTRANCE | DESCRIPTION |
| | | LINE | STATION | OFFSET | Lt/Rt | LINE | STATION | OFFSET | Lt/Rt | TON | LF | SQFT | SQFT | LF | LF | EA | EA | PETAL ATO |
| SC-7 | 4 | "C" | 0+78.00 | 45.00 | Rt | "C" | 6+90.00 | 30.00 | Rt | | 612 | | | | | | | STD. DETAIL 27B |
| SC-7 | 4 | "C" | 5+90.00 | 18.00 | Rt | "C" | 6+90.00 | 18.00 | Rt | | 100 | | | | | | | STD, DETAIL 38A |
| SC-7 | 4 | "C" | 7+81.00 | 18.00 | Lt | "C" | 8+20.00 | 18.00 | Lt | | 39 | | | | | | | STD. DETAIL 27B |
| SC-7 | 4 | "C" | 7+83.00 | 9.00 | Lt | "C" | 8+20.00 | 9.00 | Lt | | 37 | | | | | | | STD. DETAIL 8 |
| SC-7 | 4 | "C" | 7+85.00 | 2.00 | Rt | "C" | 8+20.00 | 2.00 | Rt | | 35 | | | | | | | STD. DETAIL 38A |
| SC-7 | 4 | "C" | 7+87.00 | 13.00 | Rt | "C" | 8+20.00 | 13.00 | Rt | | 33 | | | | | | | STD. DETAIL 21 |
| SC-7 | 4 | "C" | 7+90.00 | 25.00 | Rt | "C" | 8+20.00 | 25.00 | Rt | | 30 | | | | | | | STD. DETAIL 27B |
| SC-7 | 4 | "H" | 102+00.00 | 10.00 | Rt | "H" | 102+79.00 | 28.00 | Rt | | 79 | | | | | | | STD. DETAIL 27B |
| SC-7 | 4 | "H" | 101+22.00 | 13.00 | Lt | "H" | 102+79.00 | 4.00 | Lt | | 157 | | | | | | | STD. DETAIL 22 |
| SC-7 | 4 | "H" | 102+00.00 | 0.00 | Lt/Rt | "H" | 102+79.00 | 7.00 | Rt | | 79 | | | | | | | STD, DETAIL 38A |
| SC-7 | 4 | *H* | 102+00.00 | 20.00 | Lt | "H" | 102+79.00 | 33.00 | Lt | | 79 | | | | | | | STD. DETAIL 27B |
| SC-7 | 4 | "H" | 103+93.00 | 0.00 | Lt/Rt | "H" | 103+93.00 | | Lt/Rt | | 36 | | | | | | | CROSSWALK |
| SC-7 | 4 | "H" | 103+83.00 | 0.00 | Lt/Rt | "H" | 103+83.00 | | LVRt | | 53 | | | | | | | CROSSWALK |
| SC-7 | 4 | "C" | 7+71.00 | 0.00 | Lt/Rt | "C" | 7+71.00 | | Lt/Rt | | 86 | | | | | | | CROSSWALK |
| SC-7 | 4 | "C" | 7+81.00 | 0.00 | Lt/Rt | "C" | 7+81.00 | | LVRt | | 80 | | | | | | | CROSSWALK |
| SC-7 | 4 | "H" | 102+89.00 | 0.00 | Lt/Rt | "H" | 102+89.00 | | Lt/Rt | | 61 | | | | | | | CROSSWALK |
| SC-7 | 4 | ″⊢* | 102+79.00 | 0.00 | Lt/Rt | "H" | 102+79.00 | | Lt/Rt | | 71 | | | | | | | CROSSWALK |
| SC-7 | 4 | "C" | 0+78.00 | 4.00 | Rt | "C" | 6+90.00 | 6.00 | Rt | | | 1255 | | | | | | 12" WHITE PAVEMENT MARKING |
| SC-7 | 4 | "C" | 0+78.00 | 4.00 | Rt | "C" | 6+90.00 | 6.00 | Rt | | | 884 | | | | | | 12" WHITE PAVEMENT MARKING (DIAGONAL) |
| SC-8 | 4 | "C" | 8+45.00 | 30.00 | Rt | "C# | 15+67.00 | 23.00 | Rt | | | | | | | 37 | | |
| SC-8 | 4 | "C" | 9+45.00 | 0.00 | Lt/Rt | - 10 | 13107.00 | (6) | - | | | 15 | | | | | | TYPE IV (L) ARROW |
| | | "C" | 8+20.00 | 21.00 | Lt | "C" | 16+40.00 | 21.00 | Lt | | 820 | | | | | | | STD. DETAIL 27B |
| SC-8 | 4 | | | | | "C" | 10+10.00 | 10.50 | Lt | | 190 | | | | | | | STD. DETAIL 8 |
| SC-8 | 4 | "C" | 8+20.00 | 10.50 | Lt | | 9+50.00 | 10.50 | Lt/Rt | | 130 | | | | | | | STD. DETAIL 38A |
| SC-8 | 4 | "C" | 8+20.00 | 0.00 | Lt/Rt | "C" | | 10.50 | Rt | | 130 | | | | - | | | STD. DETAIL 21 |
| SC-8 | 4 | "C" | 8+20.00 | 10.50 | Rt | "C" | 9+50.00 | 10.50 | | | 820 | | | | | | | STD. DETAIL 27B |
| SC-8 | 4 | "C" | 8+20.00 | 22.50 | Rt | "0" | 16+40.00 | 16.00 | Rt | | | | | | | | | STD. DETAIL 21 |
| SC-8 | 4 | "C" | 12+85.00 | 3.00 | Rt | "C" | 16+40.00 | 3.00 | Rt | | 355 410 | | | | - | | | STD. DETAIL 27B |
| SC-8 | 4 | "C" | 16+40.00 | 8.00 | Lt | "C" | 20+50.00 | 25.00 | Lt | | | | | | | | | STD. DETAIL 21 |
| SC-8 | 4 | "C" | 16+40.00 | 3.00 | Rt | "C" | 20+84.00 | 2.50 | Rt | _ | 444 | | | | - | | | STD. DETAIL 21 |
| SC-8 | 4 | "C" | 16+40.00 | 2.00 | Rt | "C" | 20+84.00 | 3.50 | Lt | | 444 | | | | | | | STD. DETAIL 27B |
| SC-8 | 4 | "C" | 16+40.00 | 15.00 | Rt | "C" | 20+50.00 | 10.00 | Rt | | 410 | (0 | | | | | | TYPE VIARROW |
| SC-8 | 4 | "C" | 20+45.00 | 15.00 | Lt | | | | - | | | 42 | | | | | | O CONTROL OF THE CONT |
| SC-8 | 4 | "C" | 9+50.00 | 7.00 | Rt | "C" | 12+85.00 | 4.00 | Rt | | | 991 | | | | | | 12" WHITE PAVEMENT MARKING |
| SC-8 | 4 | "C" | 9+50.00 | 7.00 | Rt | "C" | 12+85.00 | 4,00 | Rt | | | 184 | | | | | | 12" WHITE PAVEMENT MARKING (DIAGONAL) |
| SC-8 | 4 | "C" | 14+00.00 | 1.00 | Lt | "C" | 16+40.00 | 4.00 | Lt | | | | | 240 | - | | | |
| SC-8 | 4 | "C" | 14+00.00 | 11.00 | Lt | ,C,, | 16+40.00 | 16.00 | Lt | | | | | 240 | | | | |
| SC-8 | 4 | "C" | 14+00.00 | 12.00 | Rt | "C" | 16+40.00 | 4.00 | Rt | | | | | | 240 | | | |
| SC-8 | 4 | "C" | 16+40.00 | 14.00 | Lt | "C" | 20+50.00 | 22.00 | Lt | | | | | 410 | | | | |
| SC-8 | 4 | "C" | 16+40.00 | 4.00 | Lt | "C" | 20+50.00 | 12.00 | Lt | | | | | 410 | | | | |
| SC-8 | 4 | "C" | 16+40.00 | 4.00 | Rt | "C" | 20+84.00 | 3.00 | Rt | | | | | | 410 | | | |
| | | "C" | 19+88.00 | 4.00 | Rt | "C" | 20+84.00 | 3.00 | Lt | | | | | 70 | | | | |
| | 4 | | | | | | | | | | | | | | 1 | 2 | | |
| SC-8 | 5 | | | 23.00 | Lt | "C" | 8+05.00 | 23.00 | Lt | | | | | 1 | | | | |
| | | "C" | 7+90.00 | 23.00 | Lt | "C" | 8+05.00 | 23.00 | Lt | | | | | | | 2 | | |

* FOR TOTAL QUANTITY, SEE "ROADWAY QUANTITY" TABLE.

REVISIONS





NEVADA COUNTY DEPARTMENT OF PUBLIC WORKS DESIGN/CONSTRUCTION DIVISION PART OF THE PART O

COMBIE ROAD CORRIDOR
IMPROVEMENT PROJECT
STAGE CONSTRUCTION
QUANTITIES

DRAWING:N09-300mb303.deg DESIGNED: MAS JPJ CHECKED: JOB NO: N09-300 DATE: Apr 5, 2018

SHEET

REVISIONS





NEVADA COUNTY DEPARTMENT OF PUBLIC WORKS DESIGN/CONSTRUCTION DIVISION


COMBIE ROAD CORRIDOR IMPROVEMENT PROJECT STAGE CONSTRUCTION QUANTITIES

| DRAWN | G:N09- | 500m | 6004.deg |
|---------|--------|------|----------|
| DESIGNE | 0: | | MAS |
| DRAWN: | | | BG |
| CHECKE | D: | | JPJ |
| JOB NO | : 1 | 109 | -300 |
| DATE: | Apr | 5, | 2018 |
| | SHEE | Т | |
| SC | Q | | 4 |
| 82 0 | 106 | SH | EETS |

STAGE CONSTRUCTION QUANTITIES

| - | | | | | | | | | IAGE | 201431 | RUCTIC | IN QUA | NIIIIE | 5 | | | | |
|--------------|----------|-------------|----------|-----------------|----------|------|--------------------|----------------|----------|----------------------------|----------------------------------|------------------------------------|--|--|--|----------------------------------|------------------------------------|---------------------------------------|
| SHEET No. | STAGE | | FR | | | | 4 | 0 - | | TEMPORARY HOT MIX ASPHALT* | TEMPORARY TRAFFIC STRIPE (PAINT) | TEMPORARY PAVEMENT MARKING (PAINT) | REMOVE THERMOPLASTIC PAVEMENT MARKING | REMOVE THERMOPLASTIC TRAFFIC STRIPE | REMOVE YELLOW THERMOPLASTIC TRAFFIC STRIPE (HAZARDOJS WASTE) | CHANNELIZER (SURFACE MOUNTED) | TEMPORARY CONSTRUCTION ENTRANCE | DESCRIPTION |
| SC-9 | 5 | LINE "C" | 7+81.00 | OFFSET 18.00 | Lt/Rt | LINE | STATION | OFFSET | Lt/Rt | TON | LF | SQFT | SQFT | LF | LF | EA | EA | |
| SC-9 | 5 | "C" | 7+83.00 | 6.00 | Lt | "C" | 8+20.00 | 18.00 | Lt | | 39 | | | | | | | STD. DETAIL 27B |
| SC-9 | 5 | "C" | 7+85.00 | 5.00 | Lt | "C" | 8+20.00 | 6.00 | Lt | | 37 | | | | | | | STD. DETAIL 8 |
| SC-9 | 5 | "C" | 7+85.00 | 16.00 | Rt Rt | "C" | 8+20.00 8+20.00 | 5.00 | Rt | | 35 | | | | | | | STD, DETAIL 21 |
| SC-9 | 5 | "C" | 7+87.00 | 16.00 | Rt | "C" | 8+20.00 | 16.00 16.00 | Rt | | 67 | | | | | | | 12" WHITE PAVEMENT MARKING |
| SC-9 | 5 | "C" | 7+90.00 | 30.00 | Rt | "C" | 8+20.00 | 30.00 | Rt Rt | | 7 | | | | | | | 12" WHITE PAVEMENT MARKING (DIAGONAL) |
| SC-10 | 5 | "C" | 8+20.00 | 25,00 | Lt | "C" | 16+40.00 | 14.00 | Lt | | 30 | | | | | | | STD. DETAIL 27B |
| SC-10 | 5 | "C" | 16+40.00 | 16.00 | Lt | "C" | 18+95.00 | 18.00 | Lt | | | | | | | 42 | | |
| SC-10 | 5 | "C" | 8+20.00 | 18.00 | Li | "C" | 16+40.00 | 5.00 | Lt | | 820 | | | | - | 13 | | |
| SC-10 | 5 | "C" | 8+20.00 | 6.00 | Lt | "C" | 10+10.00 | 6.00 | Lt | | 190 | | | | | | | STD. DETAIL 27B |
| SC-10 | 5 | "C" | 8+20.00 | 5.00 | Rt | "C" | 9+50.00 | 5.00 | Rt | | 130 | | | | | | | STD. DETAIL 38A |
| SC-10 | 5 | "C" | 8+20.00 | 16.00 | Rt | "C" | 12+08.00 | 5.00 | Lt/Rt | | 765 | | | | | | | STD. DETAIL 38A |
| SC-10 | 5 | "C" | 8+20.00 | 16.00 | Rt | "C" | 12+08.00 | | Lt/Rt | | 174 | | | = == | | | | 12" WHITE PAVEMENT MARKING |
| SC-10 | 5 | "C" | 12+08.00 | 18.00 | Rt | "C" | 16+40.00 | 6.00 | Rt | | 432 | | | | | | | 12" WHITE PAVEMENT MARKING (DIAGONAL) |
| SC-10 | 5 | "C" | 8+20,00 | 30.00 | Rt | "C" | 16+40.00 | 18.00 | Rt | | 820 | | | | | | | STD. DETAIL 21 |
| SC-10 | 5 | "C" | 9+45.00 | 15.00 | Rt | - | 10.40.00 | 10.00 | - 111 | | 020 | 15 | | | - | | | STD. DETAIL 27B |
| SC-1 TO SC-9 | | "C" | 0+74.74 | 0.00 | Lt/Rt | "C" | 43+40.57 | | Lt/Rt | | | 15 | | | | | 2 | TYPE IV (L) ARROW |
| SUBTOTAL FR | OMSCQ-3 | | | | | | | | | | 05.40 | 15 | | | | | | |
| | | | | | | | | | | | 3546 | 15 | | | | 55 | 2 | |
| SUBTOTAL FR | | | | | | | | | | 198.0 | 3224 | 482 | 84 | 2205 | 1772 | 116 | | |
| SUBTOTAL FR | | | | | | | | | | | 6124 | 281 | | | | 8 | | |
| SUBTOTAL FR | OM SCQ-3 | | | | | | | | | | 5820 | 3371 | | 1370 | 650 | 39 | | |
| SUBTOTAL | | | | | | | | | | 198.0 | 18714 | 4149 | 84 | 3575 | 2422 | 218 | 2 | |

^{*} FOR TOTAL QUANTITY, SEE "ROADWAY QUANTITY" TABLE.

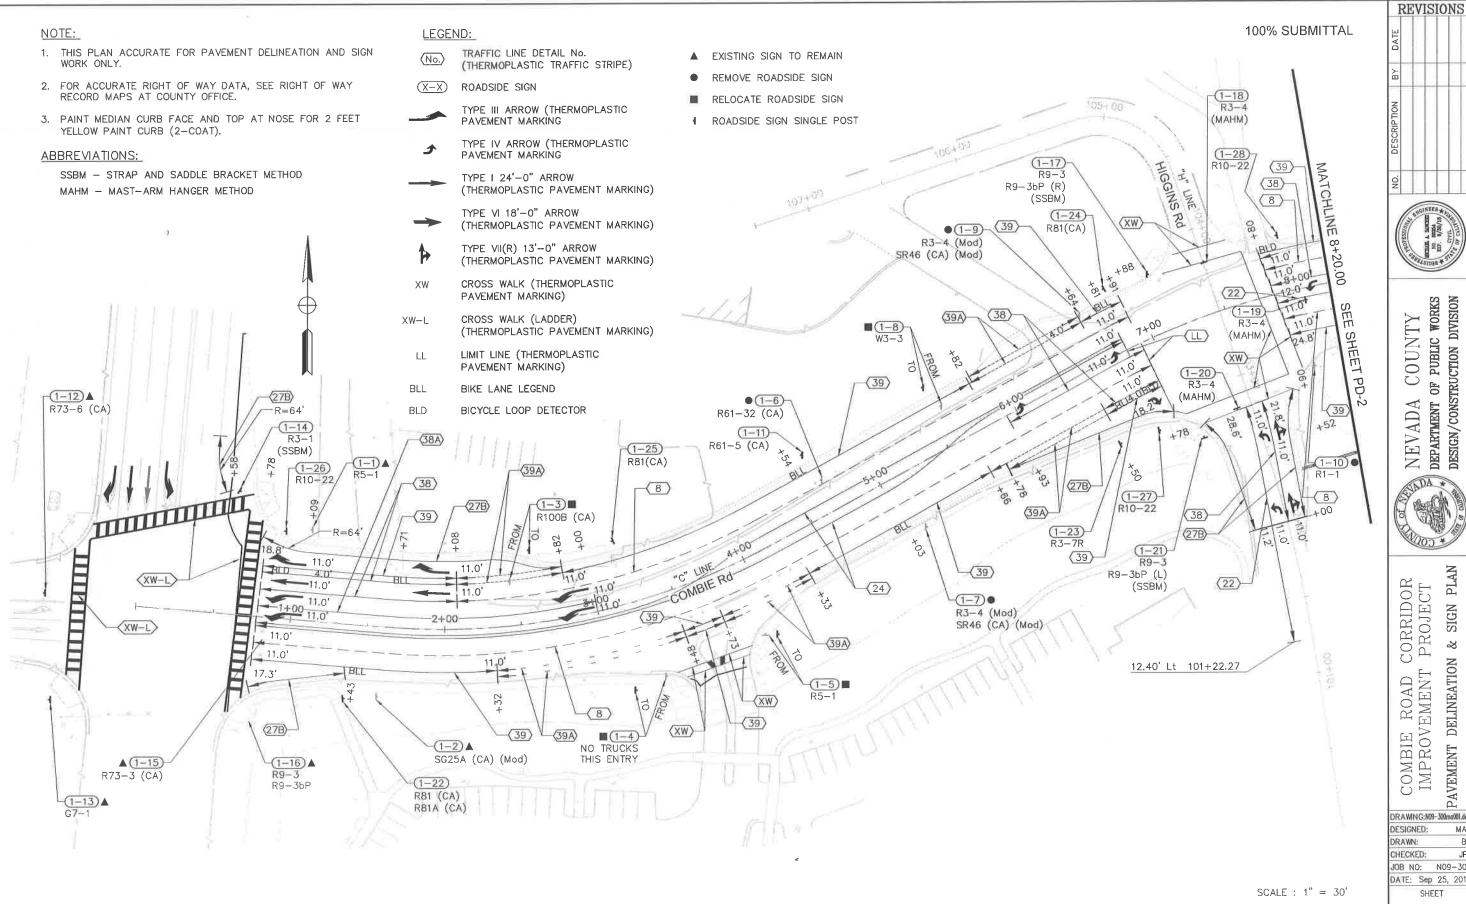

COUNTY
OF PUBLIC WORKS OF NEVADA DEPARTMENT CORRIDOR PROJECT


DIVISION

DESIGN/CONSTRUCTION

PLAN SIGN ಷ DELINEATION COMBIE ROAD (IMPROVEMENT

DRAWING:N09-300ma001.dag DESIGNED: MAS DRAWN: CHECKED: JOB NO: NO9-300 DATE: Sep 25, 2018 SHEET

83 of 106 SHEETS

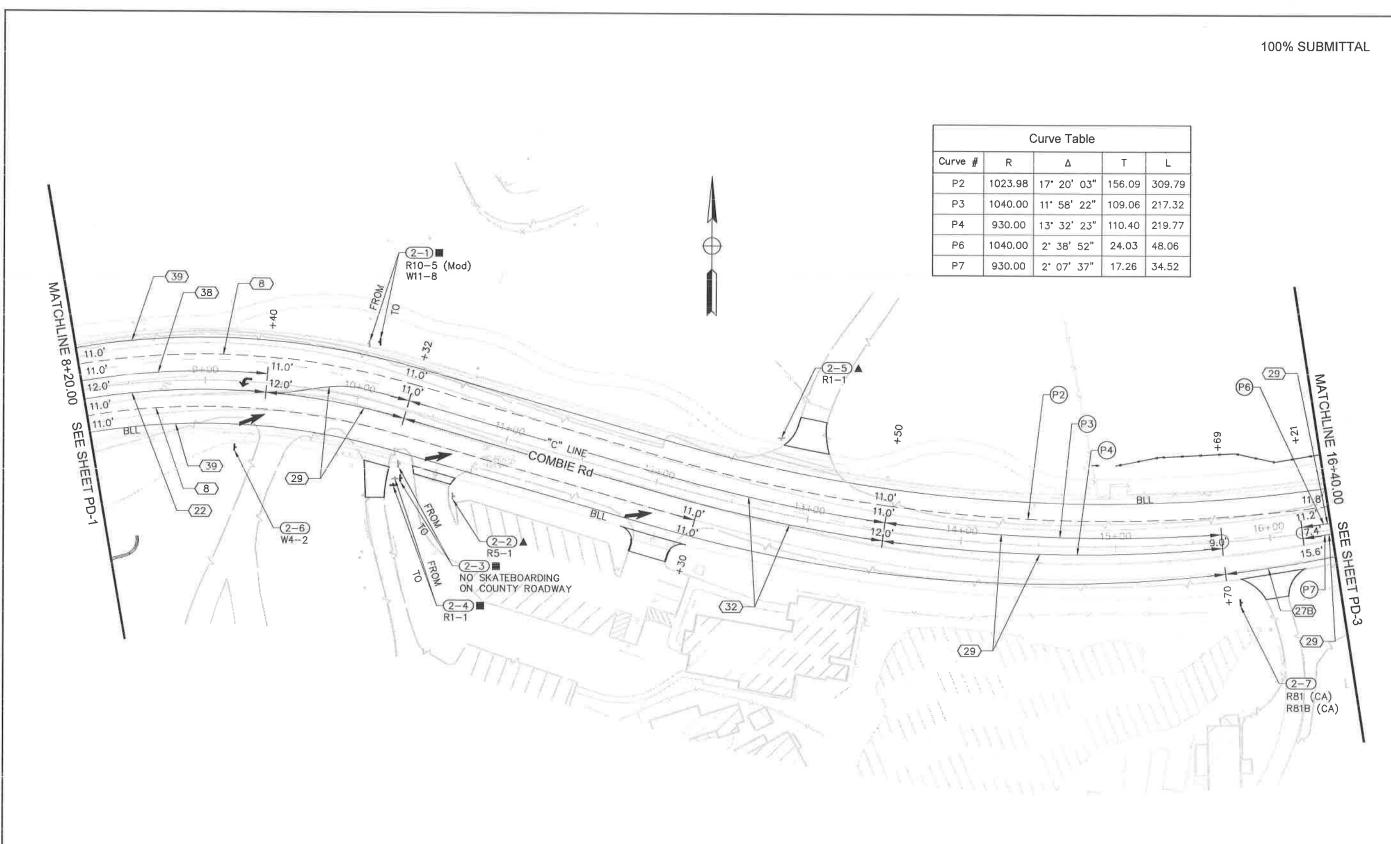

NEVADA COUNTY
DEPARTMENT OF PUBLIC WORKS
DESIGN/CONSTRUCTION DIVISION


REVISIONS

COMBIE ROAD CORRIDOR IMPROVEMENT PROJECT PAVEMENT DELINEATION & SIGN PLAN

DRAWING:N09-300mn002.dng
DESIGNED: MAS
DRAWN: BG
CHECKED: JPJ
JOB NO: N09-300
DATE: Apr 5, 2018

SHEET PD-2 84 0F1 06 SHEETS

SCALE : 1'' = 30'

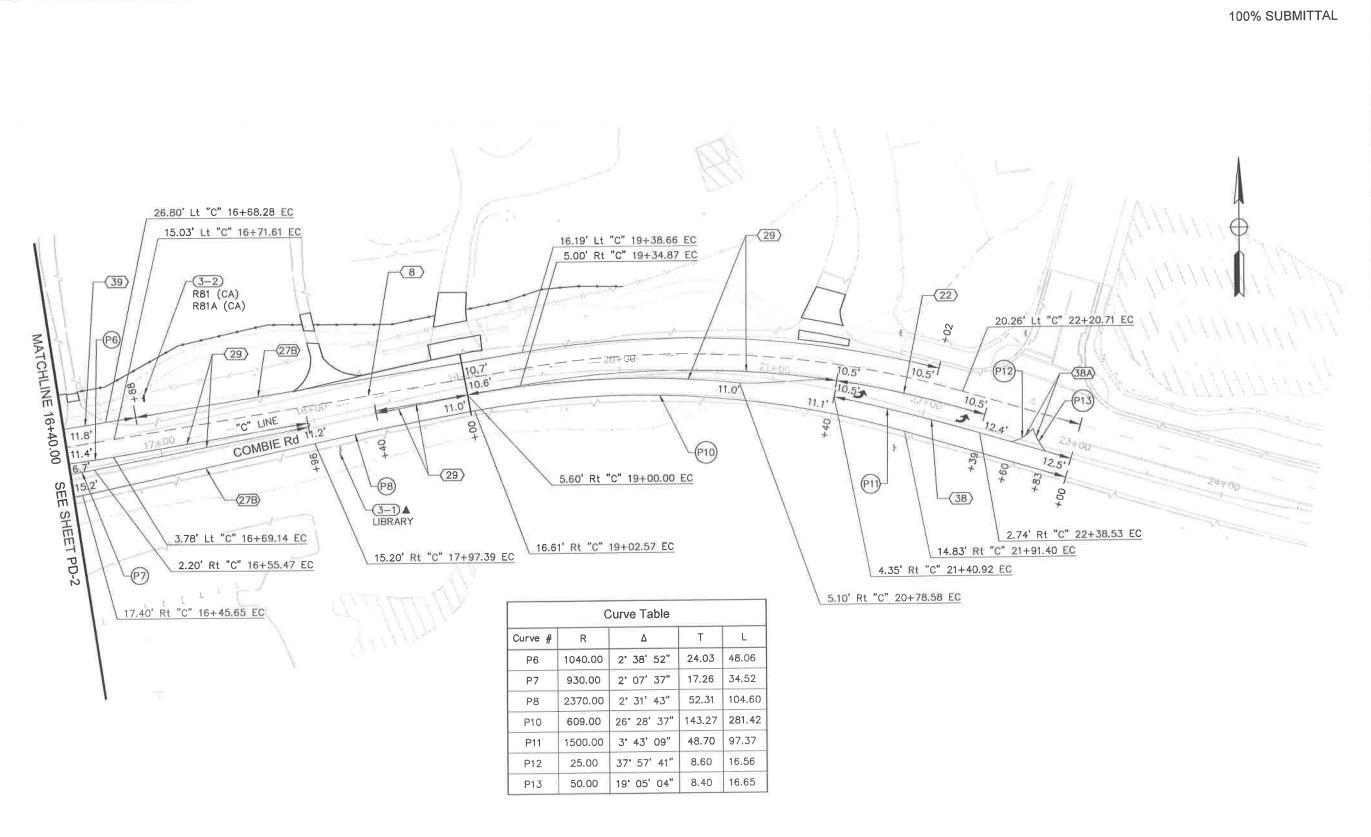

SCALE : 1" = 30'

NO. DESCRIPTION BY DATE

SEASON STATES OF THE SEASO



NEVADA COUNTY DEPARTMENT OF PUBLIC WORKS DESIGN/CONSTRUCTION DIVISION



D CORRIDOR
NT PROJECT
ATION & SIGN PLAN

COMBIE ROAD C IMPROVEMENT I

DESIGNED: MAS
DRAWN: BG
CHECKED: JPJ
JOB NO: NO9-300
DATE: Apr 5, 2018

SHEET
PD-1

PAVEMENT DELINEATION QUANTITIES


| | ī — | | | | | | | | A LIAIL 14 | DELIN | EATION | HINAUS | IES | | | | |
|--------------|--------|----------------|----------------|------------------|--------------|----------|---------------|-----------|------------|-----------|--|-----------------------|---------------------|--------|------------------------|-----------------------------------|--|
| SHEET No. | | FROM | | - | ТО | | DETAIL No. | | THERMOP | LASTIC TR | AFFIC STRIP | E | PAINT CURB (2-COAT) | | T MARKER EFLECTIVE) | THERMOPLASTIC PAVEMENT MARKING | DESCRIPTION |
| | | | | | | | | 4" | 6" | 8** | 4" (BROKEN 17-7) | 6" (BROKEN 8-4) | PAINT CL | TYPE D | TYPE G | THERMO! PAVEMEN | |
| PD-1 | LINE | STATION | | LINE | STATION | | | LF | LF | LF | LF | LF | LF | EA | EA | SQFT | |
| PD-1 | "C" | 1+14 2+08 | Lt | - | | :#X | ļ- | | | | | | | | | 31 | TYPE I 24'-0" ARROW |
| PD-1 | "C" | 0+00 | Lt | | - | | - | | | | | | | | | 31 | TYPE I 24'-0" ARROW |
| PD-1 | "C" | 0+10 | Lt. | | | (4) | - | | - | - | 1 | | | | | 31 | TYPE I 24'-0" ARROW |
| PD-1 | "C" | 1+14 | Lt | - | | - 5 | | | | | - | | | | | 31 | TYPE I 24'-0" ARROW |
| PD-1 | "C" | 1+14 | Lt | - | - | - | | | | | | | | - | | 42 | TYPE III (L) ARROW |
| PD-1 | "C" | 2+90 | Lt | | | - 2 | | | | | | | | · | | 42 | TYPE III (L) ARROW |
| PD-1 | "C" | 2+90 | Lt | | - | 1.7 | | | | | | | | | | 42 | TYPE III (L) ARROW TYPE III (L) ARROW |
| PD-1 PD-1 | "C" | -+20 | Lt | * | - | 9 | | | | | | | | | | 42 | TYPE III (R) ARROW |
| PD-1 | "C" | 0+12 1+14 | 11 | - | - | | | | | | | | | | | 42 | TYPE III (R) ARROW |
| PD-1 | "C" | 2+08 | Lt | - | | .* | | | | | | | | | | 42 | TYPE III (R) ARROW |
| PD-1 | "C" | 5+93 | Lt/Rt | | | - | | | | | | | | | | 42 | TYPE III (R) ARROW |
| PD-1 | "C" | 6+78 | Lt/Rt | - | | - 5 | | | | | | | | | | 15 | TYPE IV (L) ARROW |
| PD-1 | 19-114 | 102+52 | LVRt | 12 | | | | | | | | | | | | 15 | TYPE IV (L) ARROW |
| PD-1 | "C" | 6+81 | Rt | o e : | | - | | | | | | | | + | | 15 | TYPE IV (L) ARROW |
| PD-1 | "H" | 102+00 | Rt | - | | | | | | | | | | - | | 15 27 | TYPE IV (R) ARROW |
| PD-1 | "H" | 102+00 | Lt | 1983 | | * | | | | | | | | | | 15 | TYPE VII (R) ARROW TYPE IV (L) ARROW |
| PD-1 | "H" | 102+52 | Rt | - | - | | | | | | | | | | | 27 | TYPE VI (R) ARROW |
| PD-1 PD-1 | 101 | 0+79 | Lt | | | | | | | | | | | | | 2 | BICYCLE LOOP DETECTOR |
| PD-1 | "C" | 1+71 4+54 | Lt | | | • | | | | | | | | | | 7 | BIKE LANE |
| PD-1 | "C" | 6+81 | ഥ | (#) (#) | | | | | | | | | | | | 7 | BIKE LANE |
| PD-1 | "C" | 1+43 | Rt | 20 E | (#: 12 | | | | | | - | | | | | 7 | BIKE LANE |
| PD-1 | *O* | 5+03 | Pt | | | | | | | | | | | | | 7 | BIKE LANE |
| PD-1 | "C" | 6+60 | Rt | | | | | | | | | | | - | | 7 | BIKE LANE |
| PD-1 | "C" | 6+90 | Rt | | | | | | | | | | | 1 | | 7 | BIKE LANE |
| PD-1 | "C" | 3+37 | Rt | - | | - | | | | | | | | - | | 35 | BICYCLE LOOP DETECTOR |
| PD-1 | "C" | 3+42 | Rt | 729 | | | | | | | | | | | | 32 | CROSS WALK CROSS WALK |
| PD-1 | id-Iu | 102+78 | Lt/Rt | - | | 063 | | | | | | | | | | 60 | CROSS WALK |
| PD-1 | "H" | 102+88 | LVRt | - 14 | - | 747 | | | | | | | | | | 70 | CROSS WALK |
| PD-1 | "C" | 7+70 7+80 | Lt/Rt Lt/Rt | | | 350 | | | | | | | | | | 85 | CROSS WALK |
| PD-1 | "C" | 103+78 | Lt/Rt | | - 2 | | | | | | | | | | | 85 | CROSS WALK |
| PD-1 | "H" | 103+88 | Lt/Rt | - | | | | | | | | | | | | 52 | CROSS WALK |
| PD-1 | "C" | -+35 | Lt/Rt | - | | - | | | | | | | | - | | 35 | CROSS WALK |
| PD-1 | "C" | -+25 | Lt | "Ç" | +55 | Lt | | | | | | | | | | 450 | CROSS WALK LADDER |
| PD-1 | "C" | 0+78 | Lt/Rt | | 3 | 340 | | | | | | | | | | 510 630 | CROSS WALK LADDER |
| PD-1 | "C" | 6+91 | Rt | - | | :2:5 | | | | | | | | | | 45 | CROSS WALK LADDER LIMIT LINE |
| PD-1 | "C" | 0+78 | Lt/Rt | | *: | - | | | | | | | | | | 60 | UMIT LINE |
| PD-1 | "C" | -+28 -+50 | Lt: | *C* | +20 | Lt | | | | | | | | | | 50 | LIMIT LINE |
| PD-1 | "C" | 3+80 | Rt | * | | - | | | | | | | | | | 40 | UMIT LINE |
| PD-1 | "C" | +78 | LL | "C" | 2+08 | Lt | 38 | | | 120 | | | | | | 12 | LIMIT LINE |
| PD-1 | "C" | +78 | ш | "C" | 2+08 | Lt | 38 | | | 130 | | | | | 6 | | |
| PD-1 | "C" | +78 | Lt | "C" | 2+08 | Lt | 39 | | 130 | 100 | | | | | 6 | | |
| PD-1 | "C" | +78 | Lt | "C" | 2+90 | Lt | 38A | | | 212 | | | | | | | |
| PD-1 | "C" | 5+93 | Rt | "C" | 6+91 | Rt | 38 | | | 98 | | | | | 5 | | |
| PD-1 | #C# | 6+50 | Rt | "C" | 6+91 | Rt | 38 | | | 41 | | | | | 2 | | |
| PD-1 | "C" | 102+00 7+80 | Rt | "H" | 102+78 | Rt | 38 | | | 78 | | | | | 4 | | |
| PD-1 | #C# | 7+80 +78 | Lt Lt | "C" | 8+20 | Lt | 38 | 400 | | 40 | | | | | 2 | | |
| PD-1 | "C" | +78 | Rt | "C" | 2+82 1+43 | Lt Rt | 27B 27B | 196 62 | | | | | | | | | |
| PD-1 | "C" | 2+82 | Lt | "C" | 5+82 | Lt | 39 | 02 | 290 | | | | | | | | |
| PD-1 | "C" | +78 | Rt | "C" | 2+32 | Rt | 39 | | 159 | | | | - | | | | |
| PD-1 | "C" | 2+32 | Rt | "C" | 3+48 | Rt | 39A | | 100 | | | 124 | | | | | |
| PD-1 | "C" | 2+32 | Rt | "C" | 3+48 | Rt | 39A | | | | | 124 | | | | | |
| PD-1 | "C" | 3+73 | Rt | "C" | 4+33 | Rt | 39A | | | | | 63 | | | | | |
| PD-1 | "C" | 3+73 | Rt | "C" | 4+33 | Rt | 39A | | | | | 63 | | | | | |
| PD-1 | "C" | 4+33 | Rt | "C" | 5+66 | Rt | 39 | | 134 | | | | | | | | |
| PD-1 | "C" | 5+66 5+78 | Rt Rt | "C" | 6+50 | Rt | 39A | | | | | 84 | | | | | |
| UBTOTAL | | 0.70 | 111 | 9 | 6+50 | Rt | 39A | 250 | 742 | 700 | | 73 | | | | | |
| | | | | | | | | 258 | 713 | 729 | | 531 | | | 25 | 2886 | |

100% SUBMITTAL

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COMBIE ROAD CORRIDOR IMPROVEMENT PROJECT PAVEMENT DELINEATION QUANTITIES

DRAWING:N09-300md001.dwg DESIGNED: MAS DRAWN: CHECKED: JOB NO: NO9-300 DATE: Sep 25, 2018 SHEET

PDQ-1 87 OF 106 SHEETS

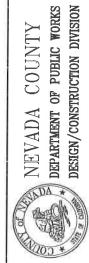PAVEMENT DELINEATION QUANTITIES

| SHEET | | FROM | | | то | | DETAIL No. | | THERMOPL | ASTIC TRA | AFFIC STRIP | E | CURB (2 COAT) | | T MARKER FLECTIVE) | THERMOPLASTIC PAVEMENT MARKING | DESCRIPTION |
|--------------|------|----------------|-------------|------|----------------|-------------|---------------|------------|----------|-----------|-------------|-----------------------|---------------|----------|-----------------------|-----------------------------------|--------------------------|
| No. | | | | | | | 140. | 4" | 6" | 8" | 17-7) | 6" (BROKEN 8-4) | PAINT | TYPE D | TYPE G | | |
| | LINE | STATION | Lt/Rt | LINE | STATION | Lt/Rt | | LF | LF | LF | LF | LF | LF | EA | EA | SQFT | |
| PD-1 | "C" | 6+50 | Rt | "C" | 6+91 | RI | 39 | | 41 | | | 81 | | | | | |
| PD-1 | "C" | 5+82 | Lt | "C" | 6+64 | Lt | 39A | | | | | 81 | | | | | |
| PD-1 | "C" | 5+82 | Lt Lt | "C" | 6+64 6+91 | Lt | 39A 39 | | 29 | | | | | | | | |
| PD-1 PD-1 | "C" | 6+64 3+48 | Rt | "C" | 3+73 | Rt | 39 | | 25 | | | | | | | | |
| PD-1 | "C" | 3+48 | Rt | "C" | 3+73 | Rt | 39 | | 25 | | | | | | | | |
| PD-1 | "C" | 5+78 | Rt | "C" | 6+91 | Rt | 27B | 114 | | | | | | | | | |
| PD-1 | "H" | 102+00 | LI | "H" | 102+78 | Lt | 27B | 78 | | | | | | | | | |
| PD-1 | #H#? | 102+00 | Rt | THE | 102+78 | Rt | 27B | 78 | 10 | | - | | | | | | |
| PD-1 | °C" | 7+80 | Lt | "C" | 8+20 | Lt | 39 | | 40 | - | | | | | | | |
| PD-1 | "C" | 7+80 | Rt | "C" | 8+20 2+82 | RI Lt | 39 39A | | 40 | | | 69 | | | | | |
| PD-1 PD-1 | "C" | 2+08 2+08 | Li Li | "C" | 2+82 | LI | 39A | | | | | 69 | | | | | |
| PD-1 | "C" | 2+08 | Lt | "C" | 6+91 | Lt | 8 | | | | 483 | | | | | | |
| PD-1 | "C" | 2+08 | Rt | "C" | 6+91 | RI | 8 | | | | 623 | | | | | | |
| PD-1 | "C" | 7+80 | Lt | "C" | 8+20 | Lt | 8 | | | | 40 | | | | | | |
| PD-1 | "C" | 7+80 | Rt | "C" | 8+20 | Rt | 8 | | | | 40 | | | | | | |
| PD-1 | *C" | +78 | Lt/Rt | "C" | 6+81 | Lt/Rt | 24 | 603 | | | - | | | | | | |
| PD-1 | .C. | +78 | Lt/Rt | "C" | 6+81 | Lt/Rt | 24 | 603 156 | | | | | | 10 | | | |
| PD-1 | "H" | 101+22 7+81 | Lt Lt | "H" | 102+78 | Lt | | 100 | | | | | | | | 2 | BICYCLE LOOP DETECTOR |
| PD-1 PD-1 | "C" | 7+80 | Rt | "C" | B+20 | Rt | 22 | 40 | | | | | | 4 | | | |
| PD-2 | "C" | 8+20 | Lt | "C" | 16+40 | Lt | 39 | | 820 | | | | | | | | |
| PD-2 | "C" | B+20 | Rt | "C" | 15+70 | RI | 39 | | 748 | | | | | | | | |
| PD-2 | "C" | 8+20 | Ll | "C" | 16+40 | Lt | 8 | | | | 820 | | | | | | |
| PD-2 | "C" | 8+20 | Rt | "C" | 12+30 | Rt | 8 | 400 | | | 410 | | | 8 | | | |
| PD-2 | "C" | 8+20 | Rt | "C" | 9+40 10+32 | Rt Lt/Rt | 22 | 120 126 | _ | | | | | 3 | | | |
| PD-2 | "C" | 9+40 9+40 | Lt/Rt Rt | "C" | 10+32 | Rt | 29 | 120 | - | | | | | 3 | | | |
| PD-2 | "C" | 8+20 | Lt | "C" | 9+40 | Lt | 38 | | | 120 | | | | | 6 | | |
| PD-2 | "C" | 9+40 | L1/Rt | | - 2 | Vei | | | | | | | | | | 15 | TYPE IV (L) ARROW |
| PD-2 | "C." | 10+32 | Lt | "C" | 13+50 | Lt | 32 | 698 | | | | | | 15 15 | | | |
| PD-2 | "C" | 10+32 | Rt | "C" | 13+50 | Rt | 32 | 700 436 | - | - | | | | 10 | | | |
| PD-2 | "C" | 13+50 | Lt Rt | "C" | 15+69 15+69 | Lt RI | 29 | 438 | | | | | | 10 | | | |
| PD-2 PD-2 | "C" | 13+50 15+70 | Rt | "C" | 16+40 | Rt | 27B | 72 | - | | | | | | | | |
| PD-2 | "C" | 16+21 | Lt | "C" | 16+40 | Lt | 29 | 40 | | | | | | 1 | | | |
| PD-2 | "C" | 16+21 | Rt | "C" | 16+40 | Rt | 29 | 40 | | | | | | 1 | | 40 | TYPE VIARROW |
| PD-2 | "C" | 9+40 | Rt | 17 | 576 | | | | | | | | | - | | 42 42 | TYPE VIARROW |
| PD-2 | "C" | 10+50 | RL | = = | 14.5 | | | | - | - | | | | | | 42 | TYPE VIARROW |
| PD-2 | "C" | 11+90 | Rt | | | - | | | | | | | | | | 15 | TYPE IV (L) ARROW |
| PD-3 PD-3 | "C" | 21+40 16+88 | Rt Lt | "C" | 22+02 | Lt | 27B | 525 | | | | | | | | | |
| PD-3 | "C" | 16+40 | Rt | "C" | 23+00 | RI | 27B | 660 | | | | | | | | | |
| PD-3 | "C" | 21+40 | Rt | "C" | 23+00 | Rt | 38 | | | 160 | | | - 82 | | | | |
| PD-3 | "C" | 22+60 | Lt/Rt | "C" | 22+71 | Lt/Rt | 38A | | | 11 | | | | | - | | |
| PD-3 | "C" | 22+71 | LI/Rt | "C" | 22+83 | Lt/Rt | 38A | 00 | | 12 | | | | 8 | | | |
| PD-3 | "C" | 21+40 | Lt | "C" | 22+39 | Lt | 39 | 99 | 44 | | - | | | | | | |
| PD-3 PD-3 | "C" | 16+40 16+40 | Lt | "C" | 16+88 17+96 | Lt | 29 | 310 | 17 | | | | | 7 | | | |
| PD-3 | "C" | 16+40 | Rt | "C" | 17+96 | Rt | 29 | 310 | | | | | | 7 | | | |
| PD-3 | "C" | 18+40 | Lt | "C" | 21+40 | Lt | 29 | 600 | | | | | | 13 | | | |
| PD-3 | "C" | 18+40 | Rt | "C" | 21+40 | Rt | 29 | 600 | | | | | | 13 | | 15 | TYPE N'(L) ARROW |
| PD-3 | "C" | 22+20 | Lt | | | * | | | | | | | - 4 | - | | 15 | CURB NOSE PAINT (YELLOW) |
| PD-1 | "C" | +78 | Rt | "C" | +78 | Rt | | | | | - | - | 4 | _ | | | CURB NOSE PAINT (YELLOW) |
| PD-1 | "C" | 6+80 | Rt | "C" | 6+82 | Rt | - | | | | - | | | | | 11 | |
| PD-1 | "C" | 6+81 | Lt/Rt Li | | | | 27B | 38 | | | | | | | | | |
| PD-1 PD-1 | "C" | 7+90 | Lt/Rt | | | | -10 | - 55 | | | | | | | | 15 | TYPE N (L) ARROW |
| 1 0 1 | | | 2.7133 | | | | | 7604 | 1812 | 303 | 2416 | 300 | 8 | 128 | 6 | 199 | |
| UBTOTAL F | | | | | | | | 258 | 713 | 729 | | 531 | | | 25 | 2886 | |

100% SUBMITTAL







NEVADA COUNTY DEPARTMENT OF PUBLIC WORKS DESIGN/CONSTRUCTION DIVISION



COMBIE ROAD CORRIDOR
IMPROVEMENT PROJECT
PAVEMENT DELINEATION
QUANTITIES

DRAWING:N09-300md002.dug MAS DESIGNED: DRAWN: CHECKED: JPJ JOB NO: NO9-300 DATE: Sep 25, 2018

SHEET

| DA COUNTY | DEPARTMENT OF PUBLIC WORKS | |
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REVISIONS

COMBIE ROAD CORRIDOR
IMPROVEMENT PROJECT
SIGN QUANTITIES

| DRAWING:N09-300m | e001,d |
|------------------|--------|
| DESIGNED: | MA |
| DRAWN: | В |
| CHECKED: | JF |
| JOB NO: NO9 | -30 |
| DATE: Apr 5, | 201 |
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METHOD) INSTALL SIGN (STRAP AND SADDLE BRACKET INSTALL SIGN (MAST-ARM HANGER METHOD) SHEET SIGN CODE SIGN No. SIGN SIGN MESSAGE COMMENTS SIGN ONE RELOCATE ROADSIDE REMOVE ROADSIGN ROADSIDE SIGN -FEDERAL CALIFORNIA EΑ EA EΑ EA EA UNAUTHORIZED VEHICLES PARKED IN DESIGNATED ACCESSIBLE SPACES NOT PD-1 1-3 DISPLAYING DISTINGUISHING PLACARDS OR SPECIAL LICENSE PLATES ISSUED FOR R100B 1 PERSONS WITH DISABILITIES WILL BE TOWED AWAY AY THE OWNER'S EXPENSE PD-1 1-4 NO TRUCKS THIS ENTRY PD-1 1-5 R5-1 DO NOTENTER PD-1 1-6 R61-32 "DOUBLE LANE CONTROL" SYMBOL PD-1 R3-4 (Mod) "U-TURN PROHIBITED" SYMBOL 1-7 PD-1 SR46 (Mod) EMERGENCY ACCESS KEEP CLEAR PD-1 1-8 W3-3 "STOPLIGHT/SIGNAL AHEAD" SYMBOL PD-1 R3-4 (Mod) "U-TURN PROHIBITED" SYMBOL 1-9 PD-1 SR46 (Mod) EMERGENCY ACCESS KEEP CLEAR PD-1 1-10 R1-1 PD-1 1-11 R61-5 "DOUBLE LANE CONTROL LEFT AND RIGHT TURN" SYMBOL PD-1 1-14 R3-1 "NO RIGHT TURN" SYMBOL PD-1 R9-3 NO PEDESTRIAN CROSSING 1-17 PD-1 R9-3bP "USE CROSSWALK" SYMBOL PD-1 1-18 R3-4 "U-TURN PROHIBITED" SYMBOL PD-1 1-19 R3-4 "U-TURN PROHIBITED" SYMBOL PD-1 1-20 R3-4 "U-TURN PROHIBITED" SYMBOL PD-1 R9-3 NO PEDESTRIAN CROSSING 1-21 PD-1 R9-3bP USE CROSSWALK PD-1 R81 BIKE LANE SYMBOL 1-22 PD-1 R81A BEGIN PD-1 1-23 R3-7R RIGHT LANE MUST TURN RIGHT PD-1 1-24 R81 BIKE LANE SYMBOL PD-1 1-25 R81 BIKE LANE SYMBOL PD-1 1-26 R10-22 PD-1 1-27 R10-22 PD-1 1-28 R10-22 PD-2 R10-5 (Mod) 2-1 LEFT ON GREEN ARROW ONLY PD-2 W11-8 "EMERGENCY VEHICLE (FIRE TRUCK)" SYMBOL PD-2 2-3 NO SKATEBOARDING ON COUNTY ROADWAY PD-2 2-4 R1-1 STOP PD-2 2-6 W4-2 LANE ENDS, MERGE LEFT PD-2 R81 BIKE LANE SYMBOL 2-7 PD-2 R81B END PD-3 R81 BIKE LANE SYMBOL 3-2 PD-3 R81A BEGIN TOTAL

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REVISIONS





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NEVADA COUN' DEPARTMENT OF PUBLIC DESIGN/CONSTRUCTION D

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COMBIE ROAD CORRIDOR IMPROVEMENT PROJECT SIGN QUANTITIES

| DESIGNE | D: | | MAS |
|---------|------|-----|------|
| DRAWN: | | | BG |
| CHĘCKE |); | | JP |
| JOB NO: | 1 | 109 | -300 |
| DATE: | Apr | 5, | 2018 |
| | SHEE | Т | |
| S(| - (| | 2 |

90 OF 106 SHEETS

DRAWING:N09-300me002.dag

SIGN QUANTITIES

| | | | | | | | BACKG | ROUND | LEG | END | | ROAL | SIDE | | | | |
|--------------|-----------------------|---------|------------|-----------------------|-----------|--------------|------------|---------------------------|----------------|---------------------------|--------------------|--|--------|--|--|--|--|
| No. OF SIGNS | SIGN No. | SIGN | N CODE | PANEL SIZE (L x D) | SIGN AREA | SINGLE FACED | TING COLOR | RETROREFLECTIVE ASTM TYPE | SHEETING COLOR | RETROREFLECTIVE ASTM TYPE | PROTECTIVE OVERLAY | FURNISH SINGLE SHEET ALUMINUM SIGN (UNFRAMED) | | DESCRIPTION (REMARKS) | | | |
| | | | | | | | SHEETING | RET R | 出 | ETR | PREMIUM | 0.063" | 0.080" | | | | |
| | | FEDERAL | CALIFORNIA | INCH x INCH | SQFT | | ত | 配 | <u>v</u> | 깥 | | SQFT | SQFT | LEFT LANE LEFT TURN ONLY. RIGHT LANE THRU OR RIGHT | | | |
| 1 | 1-11 | | R61-5 | 36X30 | 7,5 | Х | WHITE | VIII | BLACK | - 2 | X | 8 | | RIGHT TURN PROHIBITED | | | |
| 1 | 1-14 | R3-1 | | 24X24 | 4.0 | Х | WHITE | VIII | BLACK | | X | 4 | | | | | |
| 3 | 1-18, 1-19, 1-20 | R3-4 | | 24X24 | 4.0 | Х | WHITE | VIII | BLACK | | X | 12 | | U-TURN PROHIBITED | | | |
| 2 | 1-17, 1-21 | R9-3 | | 18X12 | 1,5 | Х | WHITE | VIII | BLACK | - 5. | X | 3 | | NO PEDESTRIAN CROSSING | | | |
| 2 | 1-17, 1-21 | R9-3bP | | 12X18 | 1.5 | Х | WHITE | VIII | BLACK | 12 | Х | 3 | | USE CROSSWALK | | | |
| 5 | 1-22, 1-24, 1-25. | | R81 | 24X18 | 3.0 | Х | WHITE | VIII | BLACK | • | X | 15 | | BIKE LANE | | | |
| 2 | 2-7, 3-2 1-22, 3-2 | | R81A | 12X5 | 0.4 | X | WHITE | VIII | BLACK | 2 | X | 1 | | BEGIN | | | |
| 1 | 2-7 | | R81B | 8X5 | 0.3 | Х | WHITE | VIII | BLACK | | X | 1 | | END | | | |
| 4 | 1-23 | R3-7R | 1,010 | 30X30 | 6.3 | X | WHITE | VIII | BLACK | * | X | 6 | | RIGHT LANE MUST TURN RIGHT | | | |
| 2 | 1-25, 1-27, 1-28 | R10-22 | | 18X12 | 1.5 | X | WHITE | VIII | BLACK | | X | 5 | | TO REQUEST GREEN WAIT ON | | | |
| 1 | 2-6 | W4-2 | | 36X36 | 9.0 | Х | YELLOW | VIII | BLACK | * | Х | 9 | | LANE ENDS | | | |
| ÷ | | | | | | | | | | | | 66.1 | | | | | |

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ROADWAY QUANTITIES

| SHEET No. | | FROM | | ТО | ROADWAY EXCAVATION | EMBANKMENT (N) | HOT MIX ASPHALT (TYPE A) | CLASS 2 AGGREGATE BASE | PLACE HOT MIX ASPHALT (MISCELLANEOUS AREA) | REMOVE BASE AND SURFACING | COLD PLANE ASPHALT CONCRETE PAVEMENT | DETECTABLE WARNING SURFACE | REMOVE CONCRETE CURB, GUTTER AND SIDEWALK | REMOVE CONCRETE ISLAND | MINOR CONCRETE (CURB-MATCH EXIST) | MINOR CONCRETE (MISCELLANEOUS CONSTRUCTION) | MINOR CONCRETE (CURB AND GUTTER) | MINOR CONCRETE (ISLAND PAVING) | MINOR CONCRETE (DRIVEWAY) | MINOR CONCRETE (SIDEWALK) | MINOR CONCRETE (CURB RAMP) | COMMENTS |
|--------------|------|-----------|------|----------|--------------------|----------------|--------------------------|------------------------|---|---------------------------|---|----------------------------|--|------------------------|--------------------------------------|--|----------------------------------|--------------------------------|---------------------------|---------------------------|----------------------------|------------------------------------|
| 1.4 | LINE | STATION | LINE | STATION | CŸ | CY | TON | CY | SQYD | CY | SQYD | SQFT | LF | SQYD | LF | CY | CY | CY | CY | CY | CY | |
| L-1 | "C" | +58.45 | | | | | | 3 | | | | | | | | | | | | | 2.60 | CURB RAMP |
| L-1 | "C" | 3+32,17 | | | | | | 1 | | | | | | | | | | | | | 1.35 | |
| L-1 | "C" | 3+76.88 | | | | | | 1 | | | | - 1 | | | | | | | - | | 1.43 | CURB RAMP |
| L-1 | "C" | 7+08.87 | | | | | | 2 | | | | | | | | | | | | | 2.42 | CURB RAMP |
| L-1 | "C" | 6+88,01 | - | | | | | 2 | | | | | | | | | | | | | 2.23 | CURB RAMP |
| L-1 | "C" | 7+63,07 | - | | | | Y | 3 | | | | | | | | | | | | | 2.68 | CURB RAMP |
| L-2 | "C" | 7+83.74 | | | | | | 2 | | | | | | | | | | | | | 2.09 | CURB RAMP |
| L-2 | "C" | 43+33.82 | - | | | | | 1 | | | | | | | | | | | | | 0.81 | CURB RAMP |
| L-2 L-2 | "C" | 1+20.00 | - | | | | 10 | 17 | 62 | | | | | | | | | | 2.83 | | 0.01 | DWY No. 1 |
| L-2 | "C" | 3+00.00 | | | | | 19 | 30 | 113 | | | | | | | | | | 4,34 | | | DWY No. 2 |
| L-1 | "C" | 10+20,00 | | | - | | 6 | 10 | 35 | | | | | | | | | | 2.13 | | | DWY No. 3 |
| L-1, L-2 | "C" | 12+00.00 | - | | | | 2 | 3 | 14 | | | | | | | | | | | | | DWY No. 4 |
| L-2 | "C" | 12+90.00 | 1 1 | | - | | 7 | 9 | 42 | | | | | | | | | | | | | DWY No. 5 |
| | "C" | 15+00.00 | + | | | | 8 | 16 | 48 | | | | | | | | | | 5.85 | | | DWY No. 6 |
| L-1, L-2 | "C" | 16+00.00 | | | - | | | 5 | | | | | | | | | | | 1.39 | | | DWY No. 7 |
| | "C" | 16+50,00 | | | | | 7 | 9 | 40 | | | | | | | | | | | | | DWY No. 8 |
| L-1 | "C" | 18+00.00 | | | | | 9 | 3 | 4 | | | | | | | | | | 2.50 | | | DWY No. 9 |
| L-1, L-2 | "C" | 19+00.00 | | | | | 14 | 12 | 55 | | | | | | | | | 9 | | | | DWY No. 10 |
| L-2 | "C" | 21+20.00 | | | | | 26 | 25 34 | 80 152 | | | | | | | | | | 6.95 | | | DWY No. 11 |
| L-1 | "C" | 29+40.00 | | | | | 27 | 46 | 162 | | | | | | | | | | | | | DWY No.:12 |
| L-1 | "C" | 31+30.00 | | | | | 30 | 53 | 176 | | | | | | | | | | 10.21 | | | DWY No. 13 |
| L-2 | "C" | 35+10.00 | | | | | 11 | 18 | 65 | | | | | | | | | | 13.86 | | | DWY No. 14 |
| L-2 | "C" | +64.69 | "C" | 17+97.67 | | | 644 | 1198 | - 55 | | | | | | | | | | 3.24 | | | DWY No. 15 |
| L-2 | "C" | 2+32.02 | "C" | 4+32.59 | | | 59 | 109 | - | | | | | | | | | | | | | COMBIE NORTH STRUCTURAL SECTION |
| L-2 | "H" | 102+00.00 | "H" | 102+75.3 | | | 6 | 11 | | | | | | | | | | | | | | HIGGINS DWY STRUCTURAL SECTION |
| L-2 | "C" | 8+80,75 | "C" | 15+90.03 | | | 165 | 306 | | | | | | | | | | - | | | | HIGGINS RD WEST STRUCTURAL SECTION |
| 0.5 | "C" | +64.69 | "C" | 1+45.79 | | | 38 | | | | 374 | | | | | | | | | | | COMBIE SOUTH STRUCTURAL SECTION |
| C-5 | "C" | 6÷50.00 | "C" | 8+80. | | | | | | | 1209 | | | | | | | | | | | |
| | "C" | 7+45,96 | "C" | 7+66.82 | | | | | | | 50 | | | | | - | | | | | | |
| L-2 | "H" | 102+00,00 | 'H" | 102+20 | | | 8 | | | | 83 | | | | | | | | | | | |
| | "C" | 13+85.00 | "C" | 14+30. | | | | | | | 97 | | | | | | | | | | | |
| BTOTAL | | | | | | | | | | | | | | | | | | | | | | |
| TOTAL | | | * | | | | 1098 | 1929 | 1048 | | 1814 | | | | | | | | 53.30 | | 15.61 | |

⁽N) NOT A SEPARATE PAY ITEM, FOR INFORMATION ONLY.

REVISIONS



NEVADA COUNTY
DEPARTMENT OF PUBLIC WORKS
DESIGN/CONSTRUCTION DIVISION



COMBIE ROAD CORRIDOR IMPROVEMENT PROJECT SUMMARY OF QUANTITIES

DRAWING:N09-300sb001.dwg DESIGNED: DRAWN:

CHECKED:

JOB NO: NO9-300 DATE: Apr 5, 2018

SHEET Q-1

| 00% | SI | JBMITTAL |
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ROADWAY QUANTITIES

| SHEET No. | | FROM | | ТО | ROADWAY EXCAVATION | EMBANKMENT (N) | HOT MIX ASPHALT (TYPE A) | CLASS 2 AGGREGATE BASE | PLACE HOT MIX ASPHALT (MISCELLANEOUS AREA) | REMOVE BASE AND SURFACING | COLD PLANE ASPHALT CONCRETE PAVEMENT | DETECTABLE WARNING SURFACE | REMOVE CONCRETE CURB, GUTTER AND SIDEWALK | REMOVE CONCRETE ISLAND | MINOR CONCRETE (CURB-MATCH EXIST) | MINOR CONCRETE (MISCELLANEOUS CONSTRUCTION) | MINOR CONCRETE (CURB AND GUTTER) | MINOR CONCRETE (ISLAND PAVING) | MINOR CONCRETE (DRIVEWAY) | MINOR CONCRETE (SIDEWALK) | MINOR CONCRETE (CURB RAMP) | COMMENTS |
|--------------|----------|---------------------|----------|----------------------|--------------------|----------------|--------------------------|------------------------|---|---------------------------|---|----------------------------|--|------------------------|--------------------------------------|--|----------------------------------|--------------------------------|---------------------------|---------------------------|----------------------------|-----------------------------|
| 1 | LINE | STATION | LINE | STATION | CY | CY | TON | CY | SQYD | CY | SQYD | SQFT | LF | SQYD | LF | CY | CY | CY | CY | CY | CY | |
| L-1, L-2 | "C" | 16+30.00 | "C" | 16+70. | | | 1011 | | | | 176 | | | | | | | | | | | |
| L-1, L-2 | "C" | 18+80.00 | "C" | 19+00. | | | 9 | | | | 91 | | | | | | | | | | | |
| L-1 | "C" | +64.69 | "C" | 19+00. | - | | 2311 | | 1 | | - | | | | | | | | | | | OVERLAY VOLUME |
| L-1 | "C" | +56.44 | "C" | 7+28.11 | _ | | 2311 | 70 | | | | | | | | | 39 | | | | | CURB (TYPE A2-6) |
| L-1 | "" | 1+00.27 | "C" | 3+42.17 | | | | 28 | | | | | | | | | 16 | | | | | CURB (TYPE A2-6) |
| L-1, L-2 | "C" | 3+76,36 | "H" | 102+00. | | | | 44 | İ | | | | | | | | 25 | | | | | CURB (TYPE A2-6) |
| L-2 | "H" | 102+00.00 | "C" | 10+32.37 | | | | 34 | | | | | | | | | 19 | | | | | CURB (TYPE A2-6) |
| | "C" | 7+63.07 | "C" | 16+80,91 | 1 | | | 97 | 1 | | | | | | | | 55 | | | | | CURB (TYPE A2-6) |
| L-2 | "C" | 18+52.43 | "C" | 19+31.95 | | | | 9 | 1 | | | | | | | | 5 | | | | | CURB (TYPE A2-6) |
| L-2 | "C" | 27+55.23 | "C" | 33+00.01 | | | | 58 | | | | | | | | | 32 | | | | | CURB (TYPE A2-6) |
| | "C" | 34+32.43 | "C" | 35+34.22 | | | | 11 | | | | | | | | | 6 | | | | | CURB (TYPE A2-6) |
| L-2 | "C" | 42+56.69 | "C" | 43+20.8 | | | | 6 | | | | | | | | | 4 | | | | | CURB (TYPE A2-6) |
| L-2 | "C" | +78.52 | "C" | 6+81.34 | | | | | | | | | | | | | 6 | | | | | CURB (TYPE A3-6) |
| | "C" | +78.52 | "C" | 6+81.34 | | | | | | | | | | | | | 6 | | | | | CURB (TYPE A3-6) |
| L-1 | "C" | 7+28.11 | "H" | 104+05. | | | | | | | | | | | | | 0 | | | | | CURB (TYPE A1-6) |
| L-1 | "H" | 104+05.00 | "C" | 7+63.07 | | | | | | | | | | | | | 0 | | | | | CURB (TYPE A1-6) |
| L-1 | "C" | 3+51.81 | "C" | 3+79.45 | | | | | | | | | | | | | 2 | | | | | CURB (TYPE A1-6) |
| | | | | | | | | | | | | | | | 16,17 | | | | | | | DWY No. 5 |
| L-2 | | | | | | | | | | | | | | | 7.19 | | | | | | | DWY No. 13 |
| L-2 | | | | | | | | | | | | | | 5,15 | 29.11 | | | | | | | DWY No. 14 |
| | | | | | | | | | | | | | | | 11,43 | | | | | | | DWY No. 15 |
| L-2 | | | | | | | | | | | | | | | 19.90 | | | | | | | HIGGINS PORK CHOP ISLAND |
| L-2 | | | | | | | | 6 | | | | | | | | 3.20 | | | | | | VALLEY GUTTER AT DWY No. 13 |
| L-2 | 55 - 107 | | - course | | | | | 9 | - | | | | | | | 4.46 | | | | 40.24 | - | VALLEY GUTTER AT DWY No. 14 |
| | *C** | 1+27.61 | "C" | 3+32.17 | | | | 13 | | | | | | | | | | | | 13.21 18.66 | | SIDEWALK SIDEWALK |
| | "C" | 3+85.67 | "C" | 6+88.01 | | | | 19 | | | | | | | | | | | | | | |
| | "C" | 7+99.47 | "C" | 10+08.46 | | | | 12 115 | | | - | | | | | | - | | | 11.87 | | SIDEWALK SIDEWALK |
| | "C" | 7+85.03 19+20.14 | "C" | 18+76.89 20+93.06 | | | | 115 | | | | | | | | | | | | 18.99 | | SIDEWALK |
| | "C" | 27+55.23 | "C" | 28+97.6 | | | | 14 | | | | | | | | | | | | 13.95 | | SIDEWALK |
| | "C" | 27+55.25 | "C" | 30+82.59 | | | | 12 | | | | | | | | | | | | 11.56 | | SIDEWALK |
| | "C" | 31+76.12 | "C" | 43+36.58 | | | | 112 | | | | | | | | | | | | 111.82 | | SIDEWALK |
| | | 31170,12 | | 40100.00 | | | | 114 | | | | | | | | | | | | | | |
| SUBTOTAL | | | | P ₍₁₎ | | | 2320 | 686 | | | 268 | | | 5,15 | 83.80 | 7.66 | 216 | | | 314.95 | | |

(N) NOT A SEPARATE PAY ITEM, FOR INFORMATION ONLY,

REVISIONS

NEVADA COUNTY
DEPARTMENT OF PUBLIC WORKS
DESIGN/CONSTRUCTION DIVISION

COMBIE ROAD CORRIDOR IMPROVEMENT PROJECT SUMMARY OF QUANTITIES

DRAWING:N09-300sb002.dwg
DESIGNED: MAS BG JPJ

CHECKED: JOB NO: N09-300 DATÉ: Apr 5, 2018

SHEET 92 OF 106 SHEETS

| 00% | SI | IRM | ITT | ΔΙ |
|-------|----|-------|------|----------|
| UU 70 | OL | ועוסנ | 1114 | \sim L |

ROADWAY QUANTITIES

| | | | | | - | | | | | | | | | | | | | | | | | |
|--------------|-------------------------|-----------------|------|-----------|------|----------------|--------------------------|------------------------|---|---------------------------|---|----------------------------|--|------------------------|--------------------------------------|--|----------------------------------|--------------------------------|---------------------------|---------------------------|----------------------------|-------------------------------|
| SHEET No. | FROM LINE STATION LINE | | | TO | | EMBANKMENT (N) | HOT MIX ASPHALT (TYPE A) | CLASS 2 AGGREGATE BASE | PLACE HOT MIX ASPHALT (MISCELLANEOUS AREA) | REMOVE BASE AND SURFACING | COLD PLANE ASPHALT CONCRETE PAVEMENT | DETECTABLE WARNING SURFACE | REMOVE CONCRETE CURB, GUTTER AND SIDEWALK | REMOVE CONCRETE ISLAND | MINOR CONCRETE (CURB-MATCH EXIST) | MINOR CONCRETE (MISCELLANEOUS CONSTRUCTION) | MINOR CONCRETE (CURB AND GUTTER) | MINOR CONCRETE (ISLAND PAVING) | MINOR CONCRETE (DRIVEWAY) | MINOR CONCRETE (SIDEWALK) | MINOR CONCRETE (CURB RAMP) | COMMENTS |
| | LINE | STATION | LINE | STATION | CY | CY | TON | CY | SQYD | CY | SQYD | SQFT | LF | SQYD | LF | CY | LF | CY | CY | CY | CY | |
| | "C" | 3+25.65 | *C* | 5+92.76 | | | | | | | | | | | | | | 38 | | | | ISLAND PAVING |
| | "C" | 1+24.66 | "C" | 1+36.13 | | | | | | | | | 11.00 | | | | | | | | | HIGGINS MARKETPLACE |
| | "C" | 27+55.23 | "C" | 27+93.78 | | | | | | | | | 40.00 | | | | | | | | | EAST SIDEWALK CONFORM |
| | "" | 3+71.05 | "C" | 3+99.31 | | | | | | | | | 79.00 | 5 | | | | | | | | HIGGINS DRIVEWAY |
| | "C" | 6+07.97 | "C" | 6+55.12 | | | | | | 20 | | | | | | | | | | | | EXISTING FIRESTATION DRIVEWAY |
| | "C" | +64.69 | "C" | 17+97,67 | 3583 | 9 | | | | | | | | | | | | | | | | COMBIE NORTH-WEST |
| | "C" | 1+08:86 | "C" | 2+32,02 | 4 | 17 | | | | | | | | | | | | | | | | HIGGINS MARKETPLACE WEST |
| | "C" | 4+32.59 | "C" | 102+00.00 | 27 | 101 | | | | | | | | | | | | | | | | HIGGINS ROAD WEST |
| | "H" | 102+00.00 | "C" | 15+90,03 | 110 | 161 | | | | | | | | | | | | | | | | HIGGINS ROAD EAST |
| | "C" | 16+80.12 | "C" | 20+93.14 | 21 | 105 | | | | | | | | | | | | | | | | SIDEWALK WEST |
| | "C" | 27+58.71 | "C" | 43+20,05 | 556 | 113 | | | | | | | | | | | | | | | | SIDEWALK EAST |
| | "C" | 16+80.12 | "C" | 43+20.05 | 181 | 86 | | | | | | 3.1 | | | | | | | | | | LANDSCAPE |
| | "C" | 2+32.02 | "C" | 4+32.59 | 158 | | | | | | | | | | | | | | | | | HIGGINS MARKETPLACE DWY |
| | "C" | 9+54.20 | "C" | 9+96.80 | 6 | 9 | | | | | | | | | | | | | | | | HIGGINS MARKETPLACE SIDEWALK |
| | "C" | 8+54.11 | "C" | 8+80.75 | 112 | 165 | | | | | | | | | | | | | | | | NORTHRIDGE GRADING |
| | "C" | 3+55.00 | | | | | | | | | | 16.0 | | | | | | | | | | |
| | "C" | 3+65.00 | | | | | | | | | | 16.0 | | | | | | | | | | |
| | | | | | | | | | | | | | | | | | | | | | | |
| UBTOTAL FR | ROM SHEET | Q-3 | | | 4758 | 767 | | | | 20 | | 32.0 | 51.00 | 5 | | | | 38 | | | | |
| ROM STAGE | CONSTRUC | TION QUANTITIES | | | | | 198 | | | | | | | | | | | | | | | |
| UBTOTAL FR | | | | | | | 1098 | 1929 | 1048 | | 1814 | | | | | | | - | 53 | | 16 | |
| UBTOTAL FR | | | | | | | 2320 | 686 | 1040 | | 268 | | | 5 | 84 | 8 | 216 | | 53 | 315 | 16 | |
| | | | | | | | 2020 | 5,00 | | | 200 | | | υ | 04 | 0 | 210 | | | 375 | | |
| TOTAL | | | | | 4758 | 767 | 3616 | 2615 | 1048 | 20 | 2082 | 32.0 | 51.00 | 10 | 84 | 8 | 216 | 38 | 53 | 315 | 16 | |

(N) NOT A SEPARATE PAY ITEM, FOR INFORMATION ONLY.

REVISIONS



NEVADA COUNTY
DEPARTMENT OF PUBLIC WORKS
DESIGN/CONSTRUCTION DIVISION



COMBIE ROAD CORRIDOR IMPROVEMENT PROJECT SUMMARY OF QUANTITIES

DRAWING:N09-300sb003.dwg DESIGNED: DRAWN: CHECKED: JPJ JOB NO: N09-300 DATE: Apr 5, 2018 SHEET

| F | EΙ | ΛIS | 101 | IS |
|-------------|----|------|-----|----|
| DATE | | | | |
| В | İ | | | |
| DESCRIPTION | | | | |
| Ö. | | | | |
| | 1 | CISE | ERA | |





| TY | WORKS | IVISION | |
|---------|--------------|-----------------------|--|
| COUNTY | PUBLIC WORKS | CONSTRUCTION DIVISION | |
| \circ | QF. | TRU | |
| EVADA | PARTMENT OF | SIGN/CONS | |



COMBIE ROAD CORRIDOR IMPROVEMENT PROJECT SUMMARY OF QUANTITIES

| DRAWING:NO | 19-300sb004.dw |
|----------------|----------------|
| DESIGNED: | MA |
| DRAWN: | B |
| CHECKED: | JP |
| JOB NO: | N09-30 |
| AND FRANCE TAX | F 004 |

DATE: Apr 5, 2018 SHEET

94 OF 106 SHEETS

FENCE QUANTITIES

| SHEET No. | | FROM | | | то | | % RELOCATE GATE | T REMOVE FENCE | FENCE T (TYPE BW, 4-STRAND, WOOD POST) |
|--------------|-----|----------|----|-----|----------|-----|-----------------|----------------|--|
| EC-1 | "C" | 14+85 | Lt | "C" | 14+89.23 | Lt | | | 5 |
| EC-1 | "C" | 15+00.58 | Lt | "C" | 16+45.77 | Lt | | | 140 |
| EC-1 | "C" | 16+53.28 | Lt | "C" | 18+05.81 | Lt | | | 154 |
| EC-1 | "C" | 18+12.65 | Lt | "C" | 18+89.65 | Lt | | | 79 |
| EC-1 | "C" | 19+08.25 | Rt | "C" | 20+02.84 | Rt | | | 104 |
| EC-1 | "C" | 15+00.00 | Rt | - | * | | 1 | | |
| EC-1 | "C" | 19+00.00 | Rt | - | * | - 2 | 1 | | |
| EC-1 | "C" | 14+84.61 | Lt | "C" | 15+73.58 | - 3 | | 119 | |
| EC-1 | "C" | 16+56.72 | Rt | "C" | 18+04.60 | 3 | | 156 | |
| EC-1 | "C" | 18+32 01 | Lt | "C" | 20+02,84 | 3 | | 181 | |
| TOTAL | | | | | | | 2 | 456 | 482 |

GENERAL NOTES:


- ALL WORK SHALL CONFORM TO THE 2015 EDITION OF THE STATE OF CALIFORNIA DEPARTMENT OF TRANSPORTATION (CALIFORNIS) STANDARD PLANS AND STANDARD SPECIFICATIONS AND MOST RECENT REVISIONS, 2014 CALIFORNIA MUTCD, AND THE SPECIAL REPORTS.
- THE CONTRACTOR IS RESPONSIBLE FOR VERIFICATION OF ALL EXISTING UNDERGROUND UTILITIES, WHETHER OR NOT THEY ARE SHOWN ON THESE PLANS. THE CONTRACTOR SHALL CONTACT USA (800-227-2600) AT LEAST 48 HOURS BEFORE BEGINNING WORK.
- EXISTING IMPROVEMENTS, INCLUDING SUBSTRUCTURES, THAT ARE DAMACED BY THE CONTRACTOR, WHICH ARE NOT DESIGNATED BY THE PLANS OR SPECIFICATIONS TO BE DISTURBED, SHALL BE RESTORED OR REPAIRED TO THE SATISFACTION OF THE ENGINEER AT THE CONTRACTOR'S EXPENSE.
- 4. THE CONTRACTOR SHALL POSSESS A VALID CLASS A OR C10 CONTRACTOR'S LICENSE AT THE TIME OF BID OPENING AND FOR THE DURATION OF THE PROJECT.


IMPROVEMENT PROJECT PLANS FOR


NEVADA COUNTY


DEPARTMENT OF PUBLIC WORKS

COMBIE ROAD CORRIDOR **IMPROVEMENT PROJECT**

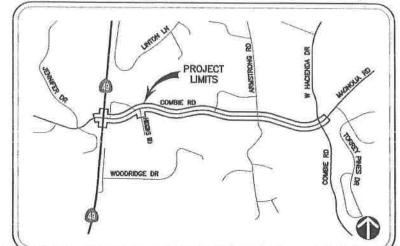


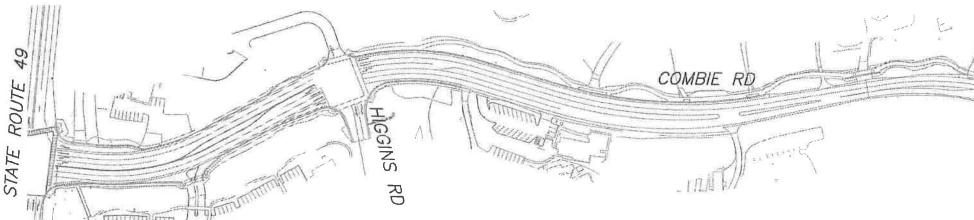

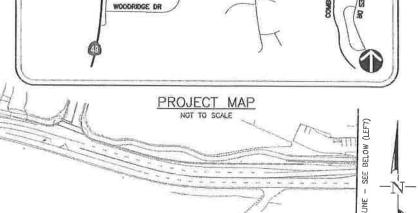

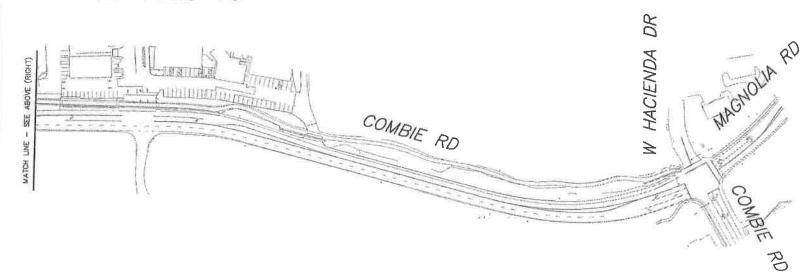



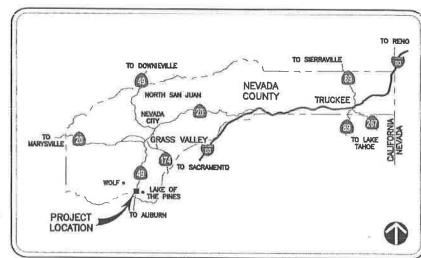

COUNTY MAP

SHEET INDEX:

SHEET TITLE E-1 COVER SHEET

COMBIE ROAD AND STATE ROUTE 49 TRAFFIC SIGNAL MODIFICATION PLAN

COMBIE ROAD AND HIGGINS ROAD TRAFFIC SIGNAL INSTALLATION PLAN

APPLICABLE 2015 CALTRANS STANDARD PLANS

RSP ES-1A RSP ES-1B RSP ES-1C ES-2A RSP ES-5B ES-5C ES-5D RSP ES-6A RSP ES-7A RSP ES-7B RSP ES-7F RSP ES-3C ES-4A ES-4B RSP ES-4C RSP ES-4D RSP ES-7G RSP ES-7H RSP ES-7M RSP ES-7N ES-70 ES-7P ES-7R

ABBREVIATIONS:

PACIFIC GAS & ELECTRIC

APPROVED BY:

DEPARTMENT OF PUBLIC WORKS

DATE CHAIR BOARD OF SUPERVISORS

DATE

--- OF ---

EER

4

X

工

L


COMBIE ROAD CORRIDOR IMPROVEMENT PROJECT

COVER SHEET

E-1


Underground Service Alert Call: TOLL FREE 811/800 227-2600

TWO WORKING DAYS BEFORE YOU DIG year. Its officers or openia shall not be responsible for the occuracy or completeness of electronic comes of this alon street

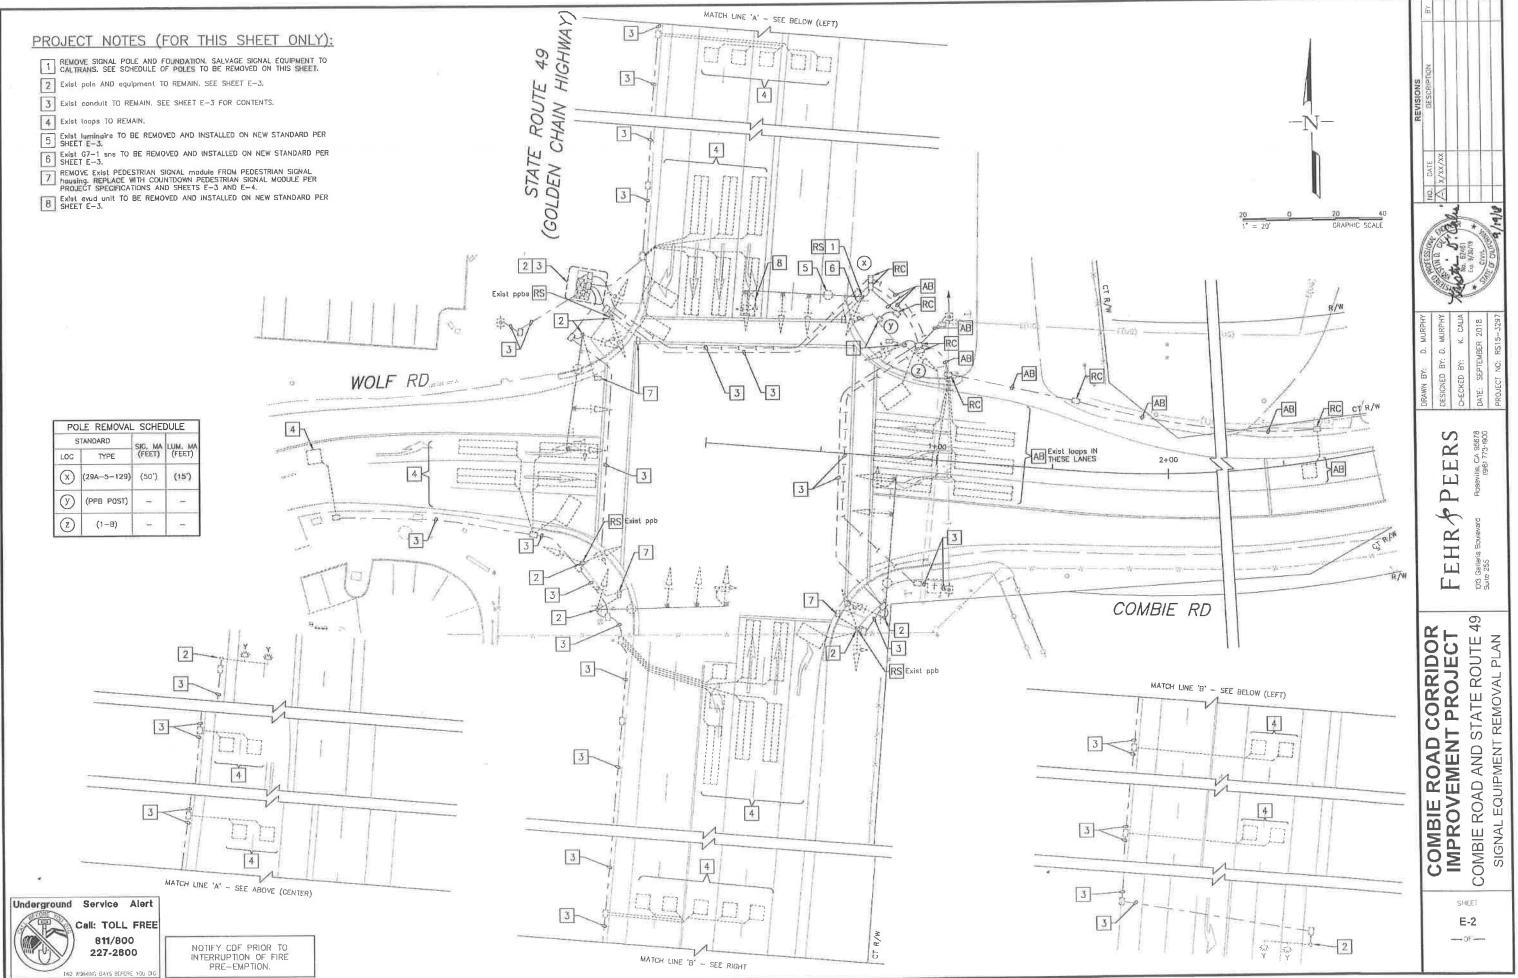

CADD


To the second state of the second state of the second state of the second state of the state of

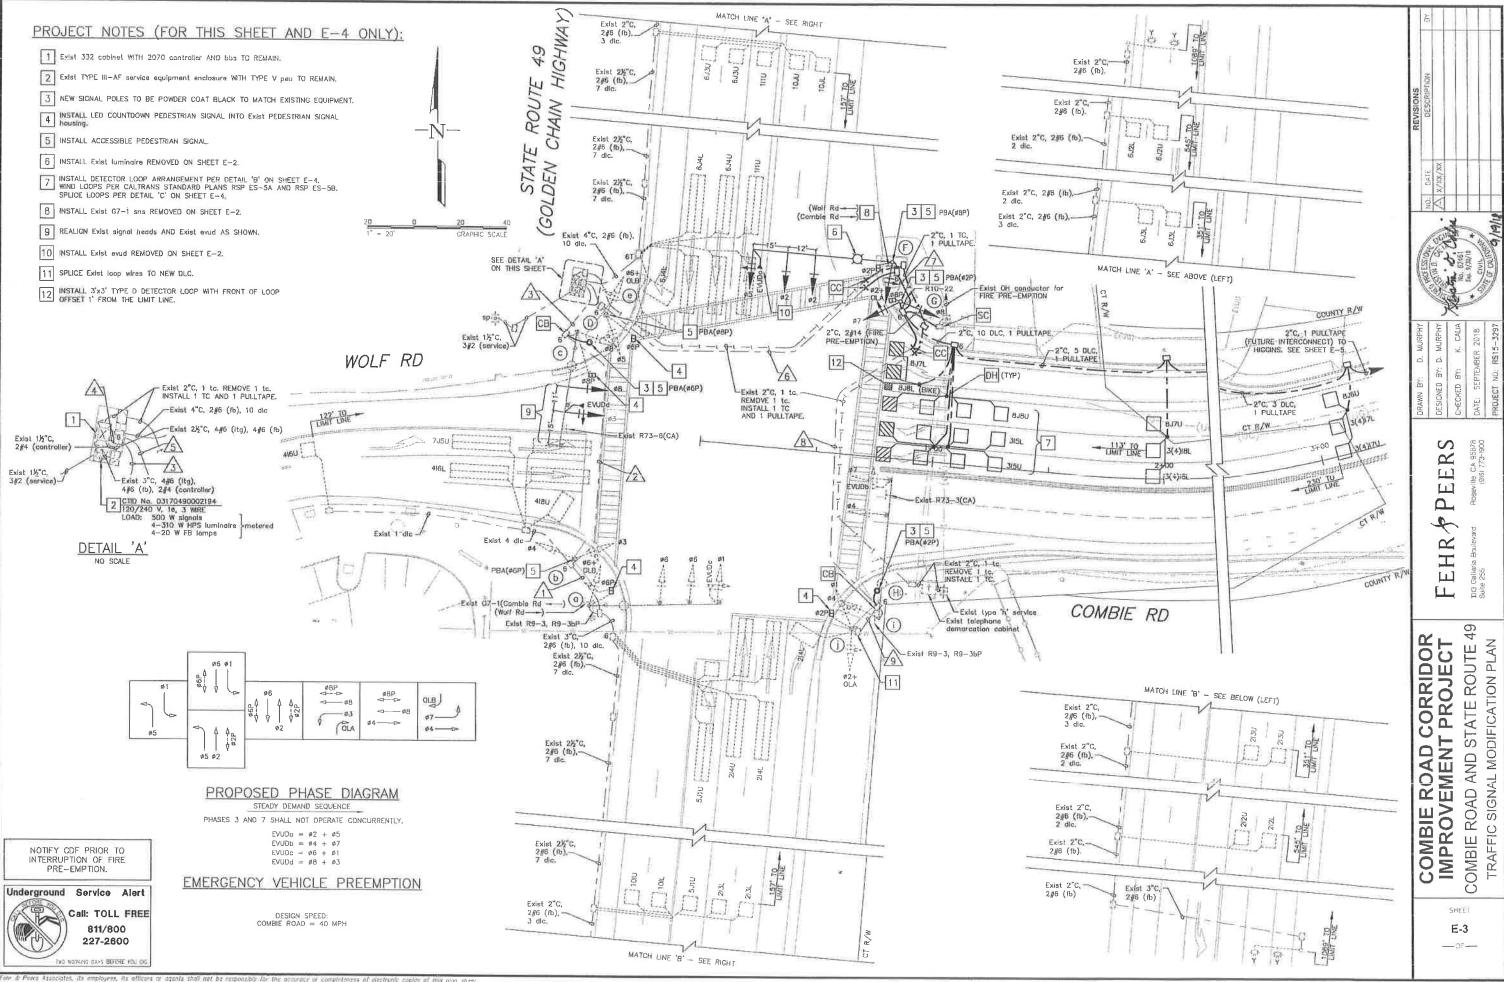


| | | 0011511 | OTC | D C | 01155 | VI II F | | | | | | | | |
|-------------|----------|--------------|----------------------|--------------------------|--------|---------|---------|---------|----------|------|--------|-------|--|--|
| | | CONDU | CIO | K S | CHEL | JULE | | | | | | | | |
| COI | | DESIGNATION | NUMBER OF CONDUCTORS | | | | | | | | | | | |
| CABLE TYPE | S | PHASE | | RUN NUMBER AND SIZE (in) | | | | | | | | | | |
| ONDEE THE | D | TIMSE | | Λ | 2 | 3 | 4 | <u></u> | <u>6</u> | A | 8 | 1 | | |
| | | | | (3") | (4") | (4") | (3-4") | (4") | (4") | 2-3" | (2 ½") | (1 ½" | | |
| VEH-PED | | 1,6+OLB,6P | _ | (1) - | | (1) | (1)_ | /- | /- | -/- | -/- | -/- | | |
| 12CSC / | (b) | 3,4 | 6 | -/- | (1)(1) | (1)(1) | (1)(1) | -/- | -/- | -/- | -/- | -/- | | |
| / | © | 3,8,8P | | -/- | -/- | (1)/ | (1)/_ | -/- | -/- | -/- | -/- | -/- | | |
| / | (D) | - | 6 | -/- | -/- | -/1 | -/1 | -/- | -/_ | -/- | -/- | F/. | | |
| / | e | 5,6+0LB,6P | 8 | -/- | -/- | -/- | 1/1 | 1/1 | -/_ | -/_ | -/- | -/- | | |
| 1 | | 2+0LA,5,2P | 8 | -/- | -/- | -/- | 1/1 | 1/1 | 1/1 | -/- | -/- | -/- | | |
| | | 7,8,8P | 2 | -/- | -/- | -/_ | 11 | 1/1 | 1/1 | 1/1 | -/- | -/ | | |
| / | B | | 2 | -/- | -/ | -/- | -/1 | -/1 | -/1 | -/1 | -/1 | -/ | | |
| PPB | | 4,7 | | -/ | -/ | -/ | 1/ | 1/ | 1/ | 1 | 1 | -/ | | |
| 3CSC | | 1,2+0LA,2P | | -/- | -/ | -/ | 1/ | 1/ | 1/ | 1/ | 1/ | 1 | | |
| TOTAL CABL | | CONDUCTORS | | (1) | (2)(1) | (3)(1) | (3)5(1) | 5 4 | 4/3 | 3/2 | 2/1 | 1/ | | |
| #14 | FIRE | PRE-EMPTION | | - | - | - | 2 | 2 | 2 | 2 | - | - | | |
| <i>u</i> - | | LIGHTING | | (2) | (2) | (2) | 700 | 2 | 2 | 2 | 2 | - | | |
| #6 | FLAS | SHING BEACON | | (2) | (2) | (2) | | V=X | - | = | - | 8 | | |
| | ø1 | | | - | | | (2) | 7=7 |)=\ | (E) | | | | |
| | ø2 | | | (6) | (6) | (6.) | (6)1 | 1 | 1 | 1 | 1 | 1 | | |
| | ø3 | | | - | | - | 5 | 5 | 5 | 5 | - | | | |
| TYPE | Ø4 | | | = | (3) | (3) | (3) | - | 1 | | 7 | - | | |
| В | ø5 | | | (2) | (2) | (2) | (2) | - | | = | = | 773 | | |
| DLC | ø6 | | | - | 3#6 | 2=: | (6) | - | 1 7 | | | | | |
| | ø7 | | |) = 1 | (1) | (1) | (1) | | 11-1 | 1- | *** | 100 | | |
| | ø8 | | | | - | 1- | 5 | 5 | 5 | 5 | ** | 71 | | |
| | COUNT LO | OP | | (2) | (2) | (2) | (4) | | - 5 | - | 77. | 75 | | |
| TOTAL DLCs | | | | (10) | (14) | (14) | (24)11 | 11 | 11 | 1.1 | 1 | 1 | | |
| EVUC (OPTIC | | | | (1) | (1) | (2) | (2)2 | 2 | 2 | 1 | 1 | - | | |
| GPS RADIO E | | | | | - | (1) | (1) | - : | F. | | #15 | | | |
| PULLTAPE (F | | ERCONNECT) | | - | | - | 1 | 1 | 1 | 1 | - | - | | |
| PERCENT FIL | L | | | 21 | 18 | 24 | 18 | 28 | 24 | 17 | 25 | 22 | | |

ALL CONDUITS, CABLES, AND CONDUCTORS SHALL BE NEW UNLESS OTHERWISE NOTED.

(XX) = DENOTES EXISTING CONDUIT OR CONDUCTOR TO REMAIN

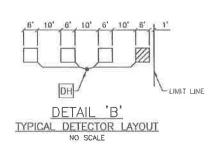

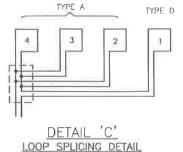

DETAIL 'C'
LOOP SPLICING DETAIL

| (P) | (1-B) | - | 391 | | (1V-2-T) | _ | ø6 | | | 5 |
|-------|-------------|-------|-------------|-------------------|-----------|----------|--------------|-------------|---------|--|
| 0 | (29A-5-129) | (50') | (15') | (MAT) (MAS) | (SV-1-TB) | (SP-1-T) | # | 2/ | (310 W) | 4 9 (GPS EVP radio), (EVUDd), (R73-6(CA) sign). |
| 0 | PPB POST | ~ | \$48 | - | - | =: | Ø6 | - | 4 | 3 5 |
| e | (1-8) | :#: | ₹). | - | (TV-2-T) | (SP-1-T) | ø8 | _ | - | 4 5 |
| (F) | 61A-5-100 | 60' | 15' | MAT MAS MAS | SV-1-TB | SP-1-T | øB | | 6 310 W | 3 5 8 10 INSTALL EVUDO ATOP SIGNAL HEAD. |
| (G) | 18 | === | = | | TV~2+T | SP-1-T | ø2 | | = | 3 5 INSTALL R10-22 SIGN ON SIGNAL POLE. |
| (H) | PPB POST | = | = | 122 | = | = | ø2 | - | = | 3 5 |
| ① | (61A-5-129) | (60') | (15') | (MAT) (MAS) | (SV-1-TB) | 20 | 3 (7) | 30 | (310 W) | (EVUDb), (R73-3(CA) sign), (R9-3 sign), (R9-3bP sign). |
| 1 | (1-8) | 72E | 20 | 1925 | (TV-2-T) | (SP-1-T) | ₩. | a 20 | an i | 4 |
| OTES: | | | | | | | | | | |

EQUIPMENT SCHEDULE

REMARKS

(310 W) 4 (EVUDc), (G7-1 sign), (R9-3 sign), AND (R9-3bP sign).

APS PBA

ø ARROW

1. ALL EQUIPMENT IS NEW UNLESS CITIERWISE NOTES.
2. PEDESTRIAN PUSH BUTTONS SHALL BE ACCESSIBLE PEDESTRIAN SIGNALS (APS) WITH 9"x15" R10-3E SIGN.
3. PEDESTRIAN SIGNALS SHALL BE LED COUNTDOWN PEDESTRIAN SIGNAL MODULE.
4. SEE SHEET E-3 FOR PROJECT NOTES

VEHICLE SIGNAL MOUNTING
MAST POLE
(MAT)
(MAS)
(MAS)
(SV-1-Ti

SIG. MA LUM, MA (FEET) (FEET)

(15")

PEDESTRIAN SIGNAL MOUNTING

STANDARD

TYPE

(61A-5-129) (55')

EERS 1 FEHR


DOTS (

COMBIE ROAD CORRIDOR IMPROVEMENT PROJECT
COMBIE ROAD AND STATE ROUTE 49
EQUIPMENT AND CONDUCTOR SCHEDULES

SHEET E-4

--- OF---

Febr & Press Associates, its employees, its afficers or equats shall not be responsible for the accuracy or consistences of electronic coales of this plan sheet.

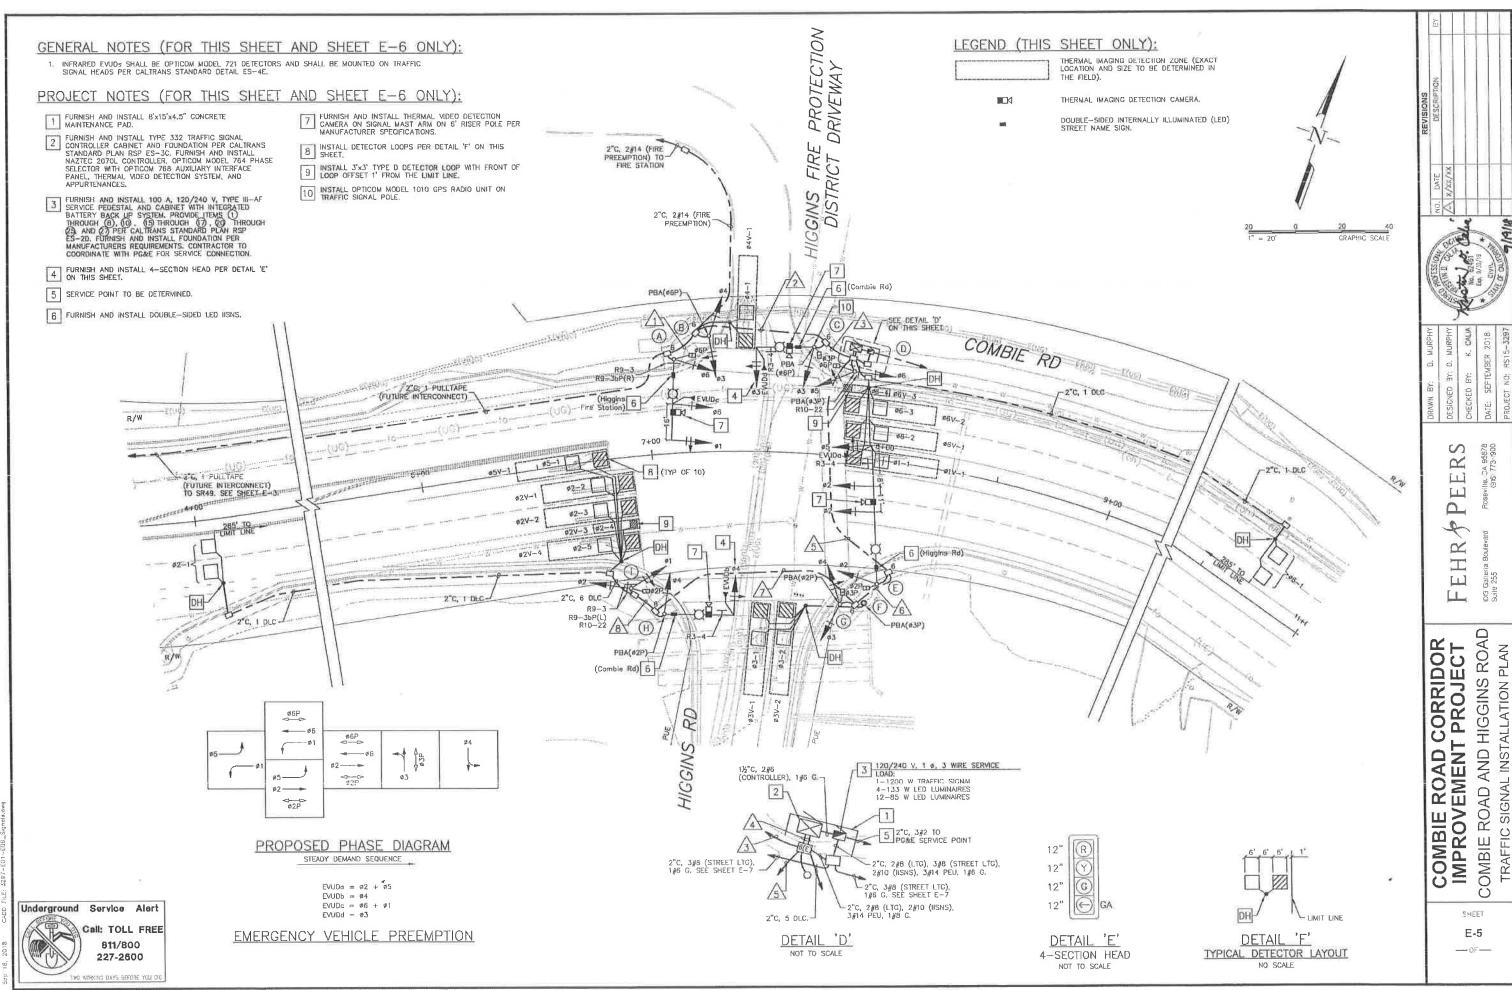

2019 Capp File: 3297-E01-E06_Signols.dwg

Febr. J. Phora Associates. He employees its afficers or ecents shall not be remonsible for the accuracy or completeness of electronic capies of this

| AWG OR CABLE CONDUCTOR DESIGNATION #1 | | CONDUC | TOR | SC | HE | DUL | .E | | | | | | |
|--|--------------|--|-------------|-----------|----|-----|-----|------|-------------|---|--|--|--|
| CONDUCTOR DESIGNATION A | | | 1 | | | | | CTOR | S | | | | |
| Mo. 14 Mo. 14 Mo. 14 Mo. 14 Mo. 14 Mo. 14 Mo. 15 Mo. 16 M | AWG OR CABLE | CONDUCTOR DESIGNATION | RUN NUMBERS | | | | | | | | | | |
| Mathematical Part Math | | COMBOCION DESIGNATION | | Section 1 | | | - | | \triangle | A | | | |
| #3 | | ø1 | 3 | 3 | 3 | | | | 3 | 3 | | | |
| MA | | | | | | | | | 3 | 3 | | | |
| PFB (#2P) | | | _ | | | | | | | _ | | | |
| MO. 14 Mo. 14 M | | | | 3 | 3 | | | 3 | 3 | _ | | | |
| NO. 14 ## PPB (#2P) | | | - | | | | 3 | | - 1 | | | | |
| NO. 14 | | ø6 | 3 | 3 | 3 | 3 | | - | | - | | | |
| NO. 14 | | #2P | + | - | - | 2 | 2 | 2 | 2 | 2 | | | |
| NO. 14 PPB (#2P) | | | | | 2 | | | _ | - | | | | |
| NO. 14 PPB (#2P) PPB (#3P) PPB (#5P) PPB (#5P) PPB (#5P) PPB (#5P) PPB COMMON PHOTOELECTRIC UNIT (120 V) SPARES TOTAL NO. 14 11 19 24 45 25 22 NO. 10 LED IISNS PER (240 V) SIGNAL COMMON TOTAL NO. 8' TOTAL NO. 8' TOTAL NO. 8' TOTAL NO. 8' TOTAL NO. 8' TOTAL NO. 8' TOTAL DETECTOR CABLES THERMAL VIDEO DETECTION COAX CABLE THERMAL VIDEO DETECTION COAX CABLE TOTAL EVUD TOTAL EVUD TOTAL EVUD TOTAL EVUD TOTAL EVUD TOTAL EVUD TOTAL EVUD TOTAL EVUD TOTAL EVUC TOT | | | 2 | 2 | - | _ | | _ | | | | | |
| PPB (#3P) | NO. 14 | | | | | | | | | | | | |
| PPB (#3P) | | PPB (#2P) | | | | 1 | 1 | 1 | 1 | | | | |
| PPB (65P) | | | | | | 1 | 1 | 1 | | | | | |
| PPB COMMON 1 1 1 1 1 1 1 1 1 1 1 1 1 1 1 1 1 1 1 | | | | 1 | 1 | 1 | | | | - | | | |
| PHOTOELECTRIC UNIT (120 V) SPARES 3 3 3 6 3 3 TOTAL NO. 14 11 19 24 45 25 22 NO. 10 LED IISNS 2 2 2 2 2 2 2 NO. 8 TOTAL NO. 8 TOTAL NO. 8 TOTAL NO. 8 TOTAL NO. 8 TOTAL NO. 8 40 (WB) 41 1 1 1 1 TOTAL NO. 8 61 (WB) 62 (EB) 63 (NB) 74 (SB) 75 (EB) 76 (WB) TOTAL DETECTOR CABLES THERMAL VIDEO DETECTION COAX CABLE EVUDG EVUC (OPTICOM 138) EVUDG FOTAL EVUC GPS EVUC (OPTICOM 1070) TOTAL DETECTOR NO. 10 1 1 1 1 1 1 1 1 1 1 1 1 1 1 1 1 1 1 | | 117.00 80,710 | _ | | | | | | | | | | |
| SPARES 3 3 3 6 3 3 3 3 5 6 3 3 3 5 70TAL NO. 14 11 19 24 45 25 22 2 2 2 2 2 2 2 | | PPB COMMON | | 1 | 1 | 1 | 1 | 1 | 1 | Г | | | |
| SPARES 3 3 3 6 3 3 3 3 5 6 3 3 3 5 70TAL NO. 14 11 19 24 45 25 22 2 2 2 2 2 2 2 | | PHOTOELECTRIC UNIT (120 V) | | | 3 | | | | | | | | |
| NO. 10 LED IISNS 2 2 2 2 2 2 2 2 2 2 2 2 2 2 2 2 2 2 | | The state of the s | 3 | 3 | 3 | 6 | 3 | 3 | 3 | | | | |
| NO. 8 | | TOTAL NO. 14 | 11 | 19 | 24 | 45 | 25 | 22 | 16 | 1 | | | |
| NO. 8 SIGNAL COMMON | NO. 10 | LED IISNS | 2 | 2 | 2 | | 2 | 2 | 2 | | | | |
| NO. 8 TOTAL NO. 8' 3 3 3 1 3 3 #1 (WB) | | LUMINAIRES (240 V) | 2 | 2 | 2 | | 2 | - | 2 | | | | |
| DLC # 01 (WB) # 02 (EB) # 03 (NB) # 04 (SB) # 1 1 1 1 1 1 1 1 1 1 1 1 1 1 1 1 1 1 | NO. B | SIGNAL COMMON | 1 | 1 | 1 | 1 | 1 | 1 | 1 | | | | |
| ## ## ## ## ## ## ## ## ## ## ## ## ## | DW7 | TOTAL NO. 8° | 3 | 3 | 3 | 1 | 3 | 3 | 3 | | | | |
| DLC #3 (NB) #4 (SB) #6 (WB) TOTAL DETECTOR CABLES THERMAL VIDEO DETECTION COAX CABLE EVUD (OPTICOM 138) EVUD EVUD TOTAL EVUC GPS EVUC (OPTICOM 1070) #4 1 | | Ø1 (WEI) | | | | 1 | | | | | | | |
| DLC #4 (SB) #5 (EB) #6 (WB) TOTAL DETECTOR CABLES THERMAL VIDEO DETECTION COAX CABLE EVUD EVUC (OPTICOM 138) EVUD EVUD TOTAL EVUC GPS EVUC (OPTICOM 1070) 1 1 1 1 1 1 1 1 1 1 1 1 1 1 1 1 1 1 1 | | #2 (EB) | | | | 5 | 5 | 5 | 5 | L | | | |
| DLC #5 (EB) 1 1 1 1 1 1 1 1 1 | | ø3 (NB) | | | | 2 | 2 | 2 | | L | | | |
| #6 (WB) | D) C | ø4 (SB) | | 1 | 1 | 1 | - | | | _ | | | |
| TOTAL DETECTOR CABLES 1 1 1 14 8 8 8 THERMAL VIDEO DETECTION COAX CABLE 1 1 2 4 2 1 EVUD 1 1 1 1 1 1 1 1 1 1 1 1 1 1 1 1 1 1 1 | DLC | ø5 (EB) | | | | 1 | 1 | 1 | 1 | | | | |
| THERMAL VIDEO DETECTION COAX CABLE 1 1 2 4 2 1 EVUD | | ø6 (WB) | - | | | 4 | | - | | - | | | |
| EVUD 1 1 1 | | TOTAL DETECTOR CABLES | | 1 | 1 | 14 | 8 | - | 6 | | | | |
| EVUC (OPTICOM 138) | THERMAL | VIDEO DETECTION COAX CABLE | 1 | 1 | 2 | _ | _ | 1 | 1 | 1 | | | |
| EVUC (OPTICOM 138) | | EVUDa | | | _ | - | - | 1 | | 1 | | | |
| (OPTICOM 138) EVUD: 1 1 1 1 1 1 1 1 1 1 1 1 1 1 1 1 1 1 1 | DAIC | EVUDb | | | | | 1 | 1 | 1 | L | | | |
| TOTAL EVUC 1 1 2 4 2 1 GPS EVUC (OPTICOM 1070) 1 1 1 | | | 1 | 1 | _ | _ | | | - | - | | | |
| GPS EVUC (OPTICOM 1070) 1 1 | | EVUDd | | - | _ | _ | 1 0 | 1 | 1 | - | | | |
| | | | 1 | 1 | _ | _ | 2 | 1 | 1 | - | | | |
| PULL TAPE FUTURE INTERCONNECT 1 1 1 1 1 1 1 | | | - | - | 1 | | | - | - | + | | | |
| CONDUIT SIZE (IN.) 3 3 3 2-3 2-3 3 | PULL TAPE | | _ | - | _ | - | 2 2 | 7 | 3 | + | | | |
| CONDUIT SIZE (IN.) 3 3 3 2-3 2-3 3 PERCENT FILL 12 15 22 24 15 23 | | | _ | - | _ | | _ | - | 19 | 2 | | | |

NOTES:

ALL CONDUITS, CABLES, AND CONDUCTORS SHALL BE NEW UNLESS OTHERWISE NOTED.

| | | | | | | | | | EQUI | PMENT SC | HEDULE | |
|-----|----------|-------------------|-------------------|-------------------|--------------------|--------|-------------|-----------|-------|------------------|--------------|--|
| \$7 | TANDARD | | | VEHICL | E SIGNAL INTING | PEDEST | RIAN SIGNAL | APS | PBA | LED LUMINAIRE | IISNS | REMARKS |
| LOC | TYPE | SIG, MA (FEET) | LUM, MA (FEET) | MAST | POLE | ø | MOUNTING | Ø | ARROW | LUMINAIRE | 11.131.74 | |
| (A) | 24-4-100 | 35' | 15' | MAT MAS | SV-1-T | ø6 | SP-1-T | - | - | 133 W | 6 Higgins Rd | 7 INSTALL EVUDE ATOP SIGNAL HEAD, INSTALL R9-3 AND R9-36P(R) ON SIGNAL POLE. |
| B | 1-B | - | _ | æ | TV-2-T | æ | | ø6 | | * | - | · |
| 0 | 19-4-100 | 25' | 15' | MAS-4C | SV-1-T | ø3 | SP-1-T | ø6 | - | 133 W | 6 Combie Rd | 7 10 INSTALL EVUDA ATOP SIGNAL HEAD, INSTALL R3-4 SIGN ON SIGNAL MAST ARM, INSTALL PEU ATOP SIGNAL POLE. |
| 0 | 1-8 | - | (+) | - | TV2-T | ø6 | SP-1-T | ø3 | - | - | ÷ | INSTALL R10-22 SIGN ON SIGNAL POLE. |
| E | 61-5-100 | 60' | 15' | MAT MAS MAS | SV-1-T | ø2 | SP-1-T | | - | 133 W | 6 Higgins Rd | 7 INSTALL EVUDO ATOP SIGNAL HEAD, INSTALL R3-4 SIGN ON SIGNAL MAST ARM. |
| F | PPB POST | 41 | 348 | - | : =) | (# | _ | ø3 | | - | 2/ | |
| G | 1-8 | - | 127 | - | TV-2-T | #3 | SP-1-T | #2 | - | - | - | 8 |
| H | 19-4-100 | 30' | 15' | MAS-4C | SV-1-T | - | 7% | ø2 | - | 133 W | 6 Combie Rd | 7 INSTALL EVUDЬ ATOP SIGNAL HEAD. INSTALL R3-4 SIGN ON SIGNAL MAST ARM. |
| 1 | 1-8 | - | - | - | TV-2-T | ø2 | SP-1-T | - | >= | - | - | INSTALL R9-3, R9-3bP(L), AND R10-22 SIGNS ON SIGNAL POLE. |

NOTES;
1. ALL EQUIPMENT IS NEW UNLESS OTHERWISE NOTED,
2. PEDESTRIAN PUSH BUTTONS SHALL BE ACCESSIBLE PEDESTRIAN SIGNALS (APS),
3. PEDESTRIAN SIGNALS SHALL BE FULL LED COUNTDOWN PEDESTRIAN SIGNAL MODULE.
4. LUMINAIRES SHALL BE LECTEK GREEN COBRA MODEL GC1-80F-MV-NW-3-GY-530,
5. SEE SHEET E-5 FOR PROJECT NOTES.

PEERS FEHRF

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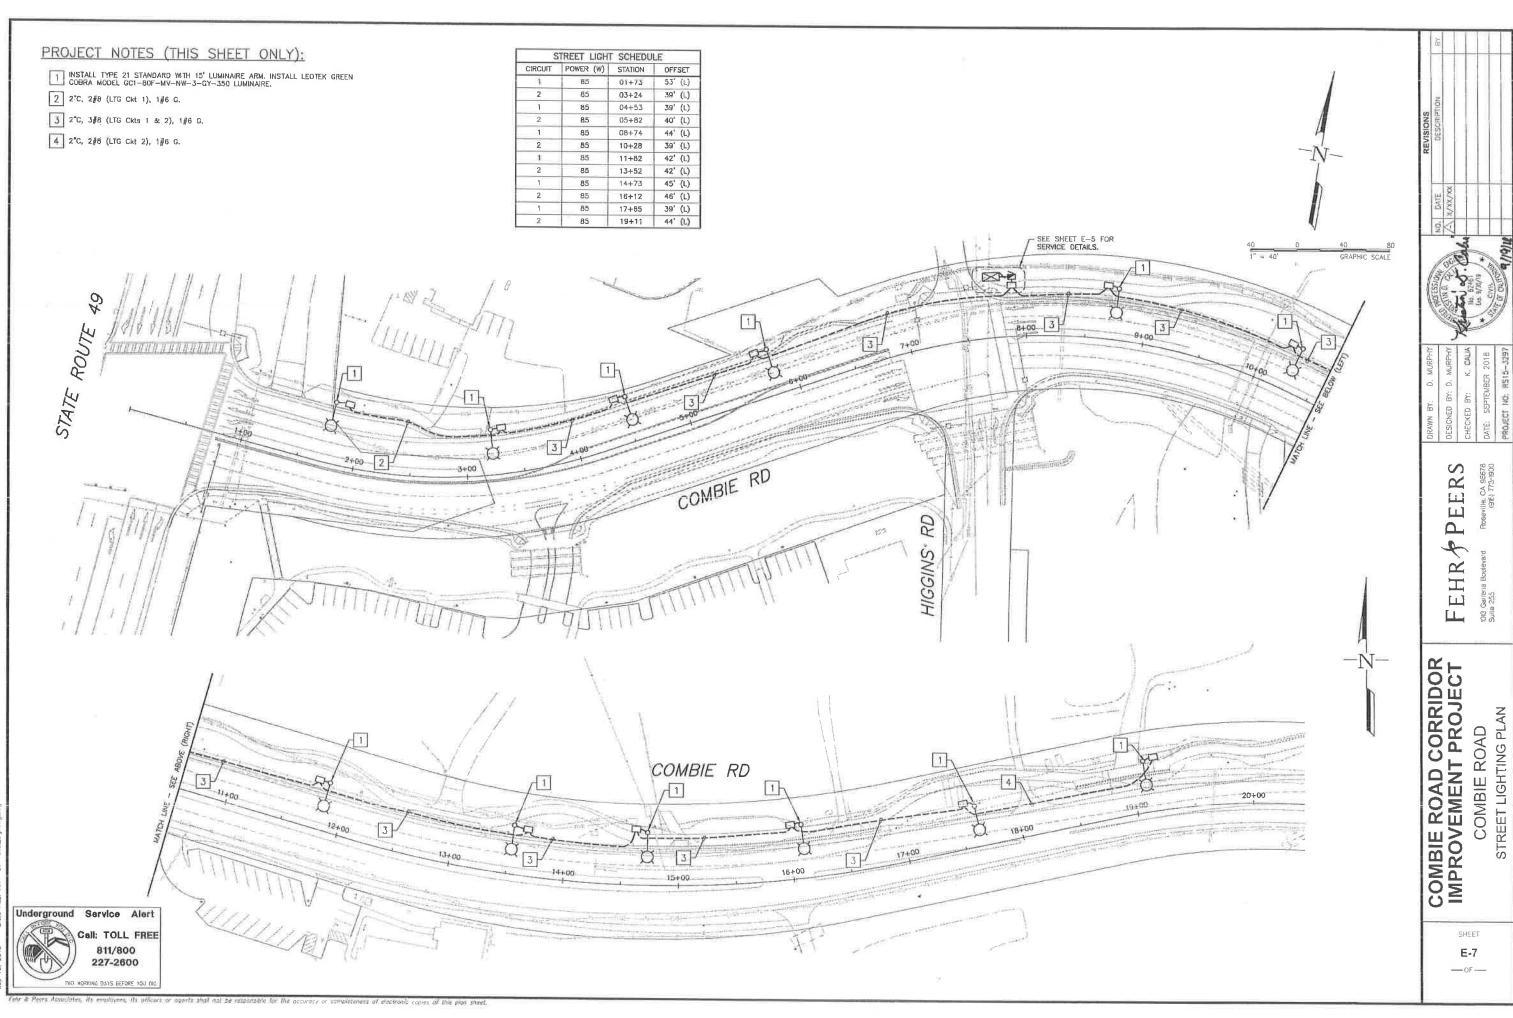
10j3 Galleria Suite 255

COMBIE ROAD CORRIDOR IMPROVEMENT PROJECT COMBIE ROAD AND HIGGINS ROAD EQUIPMENT AND CONDUCTOR SCHEDULES

SHEET

E-6 --05---

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18 CAND FRF. 3297—E07—E09 Lighting.